

## **2025 Proposed Configuration** Toronto 31855 +/- 1,313' Legend Parcels Kraus Road (Lot A): <u>SBL:</u> 58.00-4-19.121 Size: +/- 64.15 acres Frontage: +/- 1,805 ft. Meadowglen Drive A Road Kraus NOTE: This map is not an official +/- 1,292'

**ERIE COUNTY** DEPARTMENT OF ENVIRONMENT & PLANNING OFFICE OF GIS

0.07

WGS\_1984\_Web\_Mercator\_Auxiliary\_Sphere THIS MAP IS NOT TO BE USED FOR NAVIGATION

0.1 Miles

This map is a user generated static output from an Internet mapping site and is for reference only. Data layers that appear on this map may or may not be accurate, current, or otherwise reliable.

property survey.

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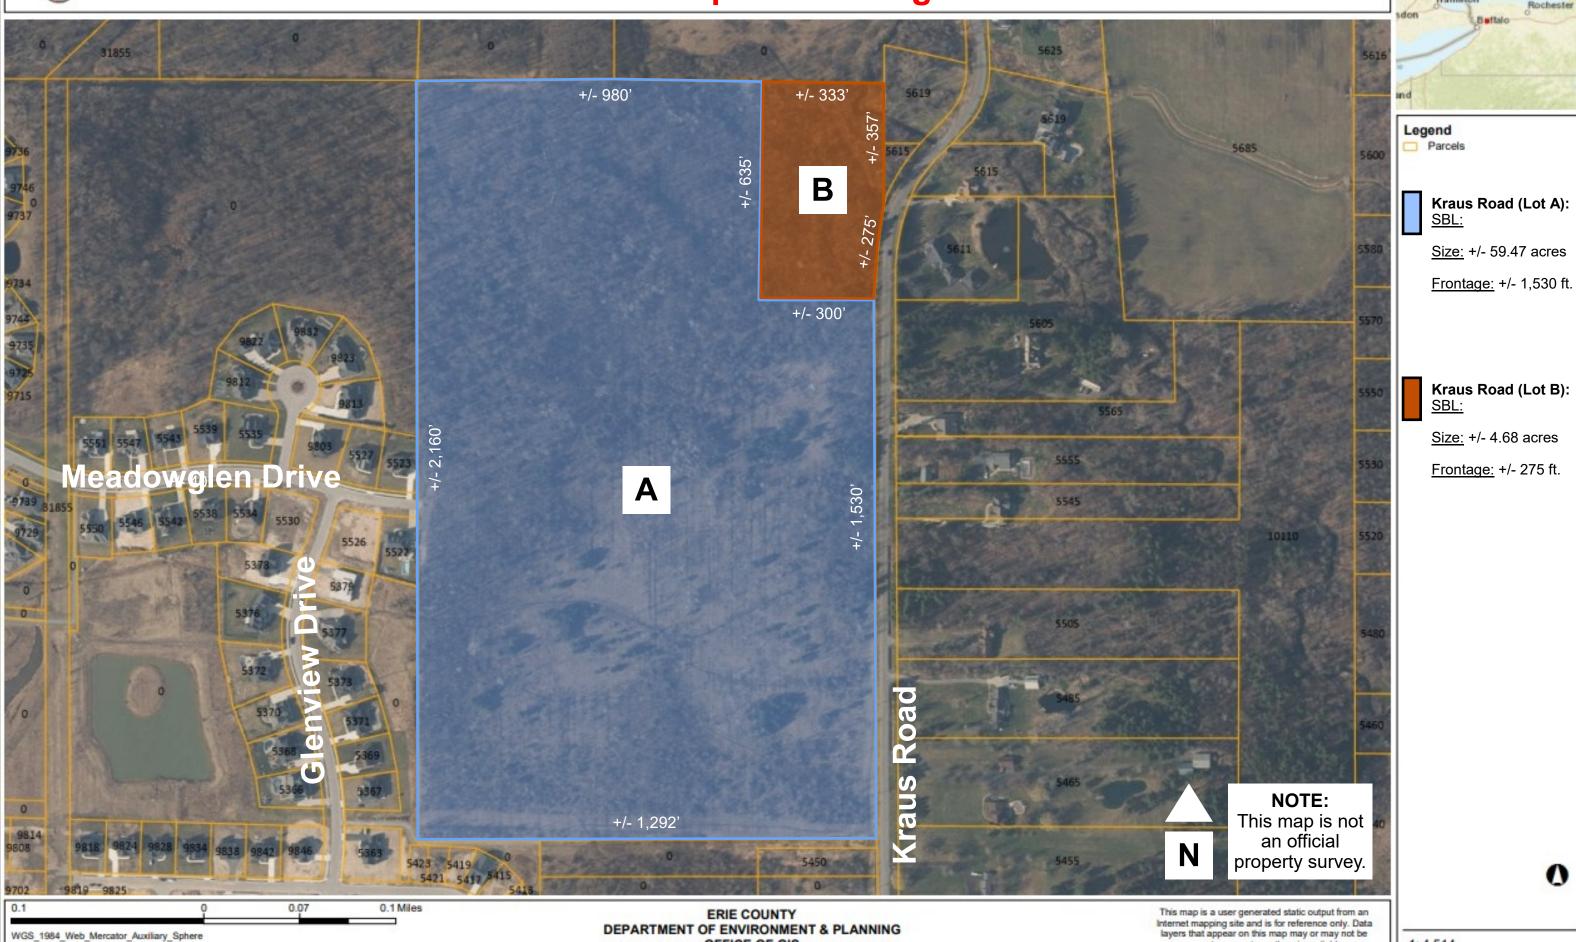
Rochester

1:4,514



THIS MAP IS NOT TO BE USED FOR NAVIGATION

### **2025 Proposed Configuration**



**OFFICE OF GIS** 

1:4,514

accurate, current, or otherwise reliable.

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Toronto

Rochester

#### Short Environmental Assessment Form Part 1 - Project Information

#### **Instructions for Completing**

Part 1 – Project Information The applicant or project sponsor is responsible for the completion of Part 1. Responses become part of the application for approval or funding, are subject to public review, and may be subject to further verification. Complete Part 1 based on information currently available. If additional research or investigation would be needed to fully respond to any item, please answer as thoroughly as possible based on current information.

Complete all items in Part 1. You may also provide any additional information which you believe will be needed by or useful to the lead agency; attach additional pages as necessary to supplement any item.

| Part 1 - Project and Sponsor Information   | - Contraction of the Contraction |           |     |
|--|--|-----------|-----|
| Estate of Jennie Deni, Leonard A. Deni, Executor   |  |           |     |
| Name of Action or Project:   |  |           |     |
| Minor subdivision of vacant land on Kraus Road   |  |           |     |
| Project Location (describe, and attach a location map):  |  |           | 1 7 |
| 4.68 acres in northeast corner of 65-acre parcel of vacant land on Kraus Road, Clarence, NY  |  |           |     |
| Brief Description of Proposed Action:  |  |           |     |
| Subdividing 4.68-acres of vacant land from larger 65-acre parcel of vacant land.   |  |           |     |
|  |  |           |     |
|  |  |           |     |
|  |  |           |     |
|  |  |           |     |
|  |  |           |     |
|  |  |           |     |
| Name of Applicant or Sponsor:  | Telephone: 716-983-9492  | 2         |     |
| Estate of Jennie Deni, Leonard A. Deni, Executor   | E-Mail: lad@deni.com   |           |     |
| Address:   |  |           |     |
| 20 Norris Street   |  |           |     |
| City/PO:   | State:   | Zip Code: |     |
| Buffalo  | NY   | 14207     |     |
| 1. Does the proposed action only involve the legislative adoption of a plan, loc   | al law, ordinance,   | NO        | YES |
| administrative rule, or regulation?  |  |           | TES |
| If Yes, attach a narrative description of the intent of the proposed action and the  | environmental resources th   | nat 🗸     |     |
| may be affected in the municipality and proceed to Part 2. If no, continue to que  |  |           |     |
| 2. Does the proposed action require a permit, approval or funding from any oth If Yes, list agency(s) name and permit or approval: | ner government Agency?   | NO        | YES |
| 11 Tes, list agency(s) hame and permit of approval.  |  | V         |     |
| 3. a. Total acreage of the site of the proposed action?  | 65acres  |           |     |
| b. Total acreage to be physically disturbed?   | 0acres   |           |     |
| c. Total acreage (project site and any contiguous properties) owned  | 65   |           |     |
| or controlled by the applicant or project sponsor?   | 65 acres   |           |     |
| 4. Check all land uses that occur on, are adjoining or near the proposed action:   |  |           |     |
| ☐ Urban ☑ Rural (non-agriculture) ☐ Industrial ☐ Commerc   | ial Residential (subu  | rban)     |     |
| Forest Agriculture Aquatic Other(Spe   | 8  |           |     |
| Parkland   | cc 50  |           |     |
|  |  |           |     |

| 5. Is the proposed action,  | NO          | YES | N/A      |
|---|-------------|-----|----------|
| a. [A permitted use under the zoning regulations]   |             | 12  |          |
| b. Consistent with the adopted comprehensive plan?  | $\dashv$    |     | 屵        |
| b. Regularistent with the adopted completensive plans   | Ш           | 1   | <u>Ш</u> |
| 6. Is the proposed action consistent with the predominant character of the existing built or natural landscape?   | 1           | NO  | YES      |
|   |             |     | ~        |
| 7. Is the site of the proposed action located in, or does it adjoin, a state listed Critical Environmental Area?  |             | NO  | YES      |
| If Yes, identify:   |             | 7   |          |
|   |             |     | 7,770    |
| 8. a. Will the proposed action result in a substantial increase in traffic above present levels?  |             | МО  | YES      |
| b. Are public transportation services available at or near the site of the proposed action?   |             | ᆜ   | ᆜ        |
|   |             | ~   | <u> </u> |
| c. Are any pedestrian accommodations or bicycle routes available on or near the site of the proposed action?  |             | ~   |          |
| 9. Does the proposed action meet or exceed the state energy code requirements?  |             | NO  | YES      |
| If the proposed action will exceed requirements, describe design features and technologies:   |             |     |          |
|   |             | ~   |          |
|   |             |     |          |
| 10. Will the proposed action connect to an existing public/private water supply?  |             | NO  | YES      |
| If No, describe method for providing potable water:   |             |     |          |
| No potable water needed. Proposed action is to transfer unimproved vacant land.   |             | ~   |          |
|   |             | _   |          |
| 11. Will the proposed action connect to existing wastewater utilities?  | -           | NO  | YES      |
| If No, describe method for providing wastewater treatment:  |             |     |          |
| No wastewater treatment needed. Proposed action is to transfer unimproved vacant land.  |             | ~   |          |
|   | <del></del> |     |          |
| 12. a. Does the project site contain, or is it substantially contiguous to, a building, archaeological site, or district which is listed on the National or State Register of Historic Places, or that has been determined by the |             | NO  | YES      |
| Commissioner of the NYS Office of Parks, Recreation and Historic Preservation to be eligible for listing on the   |             | 7   |          |
| State Register of Historic Places?  | J           |     |          |
| b. Is the project site, or any portion of it, located in or adjacent to an area designated as sensitive for   |             | ~   |          |
| archaeological sites on the NY State Historic Preservation Office (SHPO) archaeological site inventory?   |             |     |          |
| 13. a. Does any portion of the site of the proposed action, or lands adjoining the proposed action, contain wetlands or other waterbodies regulated by a federal, state or local agency?  | -           | NO  | YES      |
|   |             |     | V        |
| b. Would the proposed action physically alter, or encroach into, any existing wetland or waterbody?   |             | 2   |          |
| If Yes, identify the wetland or waterbody and extent of alterations in square feet or acres:  |             |     |          |
|   |             |     |          |
|   | _           |     |          |
|   |             |     |          |

| 14. Identify the typical habitat types that occur on, or are likely to be found on the project site. Check all that apply:  |       |              |
|---|-------|--------------|
| ☐ Shoreline ☐ Forest ☑ Agricultural/grasslands ☐ Early mid-successional   |       |              |
| ■Wetland ■ Urban ☑ Suburban   |       |              |
| 15. Does the site of the proposed action contain any species of animal, or associated habitats, listed by the State or  | NO    | YES          |
| Federal government as threatened or endangered?   | ~     |              |
| 16. Is the project site located in the 100-year flood plan?   | NO    | YES          |
|   | V     |              |
| 17. Will the proposed action create storm water discharge, either from point or non-point sources?  | NO    | YES          |
| If Yes,   | V     |              |
| a. Will storm water discharges flow to adjacent properties?   |       |              |
| b. Will storm water discharges be directed to established conveyance systems (runoff and storm drains)?   |       |              |
| If Yes, briefly describe:   |       |              |
|   |       |              |
|   |       |              |
| 18. Does the proposed action include construction or other activities that would result in the impoundment of water or other liquids (e.g., retention pond, waste lagoon, dam)? | NO    | YES          |
| If Yes, explain the purpose and size of the impoundment:  |       |              |
|   |       |              |
|   |       |              |
| 19. Has the site of the proposed action or an adjoining property been the location of an active or closed solid waste management facility?                                      | NO    | YES          |
| If Yes, describe:   |       | <b> </b>     |
|   | ~     | $  \sqcup  $ |
|   |       |              |
| 20. Has the site of the proposed action or an adjoining property been the subject of remediation (ongoing of completed) for hazardous waste?                                    | NO    | YES          |
| If Yes, describe:   |       | _            |
|   |       | Ш            |
|   |       |              |
| I CERTIFY THAT THE INFORMATION PROVIDED ABOVE IS TRUE AND ACCURATE TO THE BE MY KNOWLEDGE   | ST OF | •            |
| // /  |       |              |
| Applicant/sponsor/panie: Estate of Jenn/e Deni Date:  |       |              |
| SignatureTitle: Executor  |       |              |
|   |       |              |
|   |       |              |

Project:
Date:

#### Short Environmental Assessment Form Part 2 - Impact Assessment

#### Part 2 is to be completed by the Lead Agency.

Answer all of the following questions in Part 2 using the information contained in Part 1 and other materials submitted by the project sponsor or otherwise available to the reviewer. When answering the questions the reviewer should be guided by the concept "Have my responses been reasonable considering the scale and context of the proposed action?"

|     |   | No, or<br>small<br>impact<br>may<br>occur | Moderate<br>to large<br>impact<br>may<br>occur |
|-----|---|---|--|
| 1.  | Will the proposed action create a material conflict with an adopted land use plan or zoning regulations?  |   |  |
| 2.  | Will the proposed action result in a change in the use or intensity of use of land?   |   |  |
| 3.  | Will the proposed action impair the character or quality of the existing community?   |   |  |
| 4.  | Will the proposed action have an impact on the environmental characteristics that caused the establishment of a Critical Environmental Area (CEA)?                      |   |  |
| 5.  | Will the proposed action result in an adverse change in the existing level of traffic or affect existing infrastructure for mass transit, biking or walkway?            |   |  |
| 6.  | Will the proposed action cause an increase in the use of energy and it fails to incorporate reasonably available energy conservation or renewable energy opportunities? |   |  |
| 7.  | Will the proposed action impact existing: a. public / private water supplies?   |   |  |
|     | b. public / private wastewater treatment utilities?   |   |  |
| 8.  | Will the proposed action impair the character or quality of important historic, archaeological, architectural or aesthetic resources?                                   |   |  |
| 9.  | Will the proposed action result in an adverse change to natural resources (e.g., wetlands, waterbodies, groundwater, air quality, flora and fauna)?                     |   |  |
| 10. | Will the proposed action result in an increase in the potential for erosion, flooding or drainage problems?   |   |  |
| 11. | Will the proposed action create a hazard to environmental resources or human health?  |   |  |


| Agency Use Only [If applicable] |
|---------------------------------|
| Project:                        |
| Date:                           |


### Short Environmental Assessment Form Part 3 Determination of Significance

For every question in Part 2 that was answered "moderate to large impact may occur", or if there is a need to explain why a particular element of the proposed action may or will not result in a significant adverse environmental impact, please complete Part 3. Part 3 should, in sufficient detail, identify the impact, including any measures or design elements that have been included by the project sponsor to avoid or reduce impacts. Part 3 should also explain how the lead agency determined that the impact may or will not be significant. Each potential impact should be assessed considering its setting, probability of occurring, duration, irreversibility, geographic scope and magnitude. Also consider the potential for short-term, long-term and cumulative impacts.

| Check this box if you have determined, based on the information and analysis above, and any supporting documentation, that the proposed action may result in one or more potentially large or significant adverse impacts and an environmental impact statement is required.  Check this box if you have determined, based on the information and analysis above, and any supporting documentation, that the proposed action will not result in any significant adverse environmental impacts. |   |  |  |  |
|--|---|--|--|--|
| Name of Lead Agency  | Date  |  |  |  |
| Print or Type Name of Responsible Officer in Lead Agency   | Title of Responsible Officer                                  |  |  |  |
| Signature of Responsible Officer in Lead Agency  | Signature of Preparer (if different from Responsible Officer) |  |  |  |



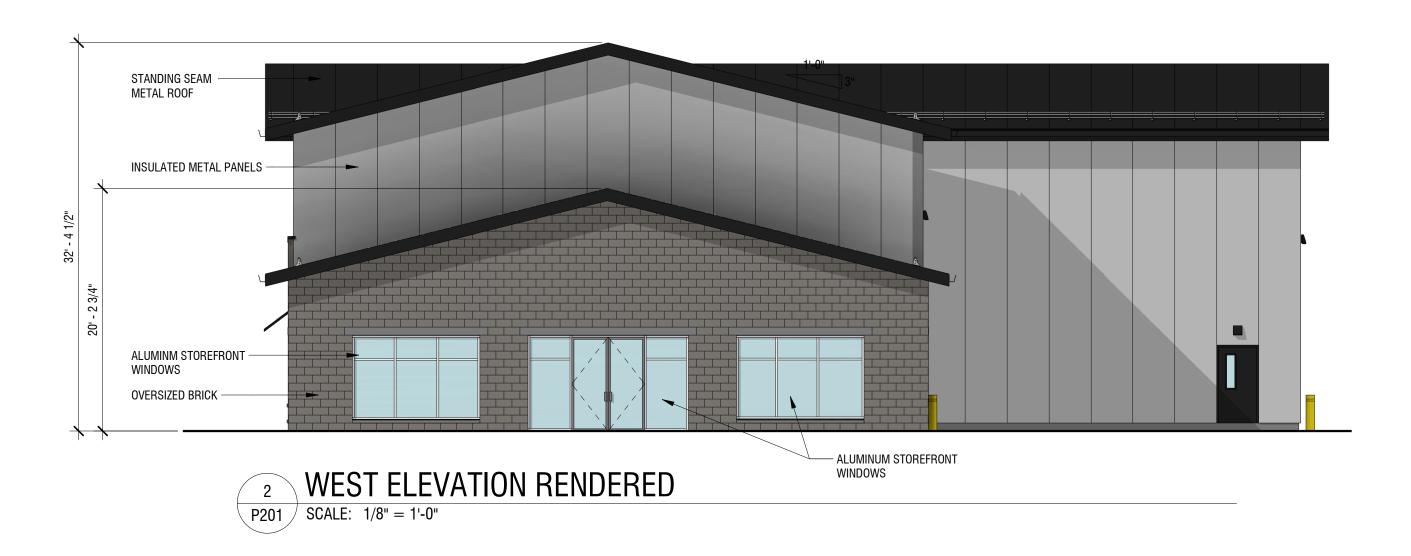

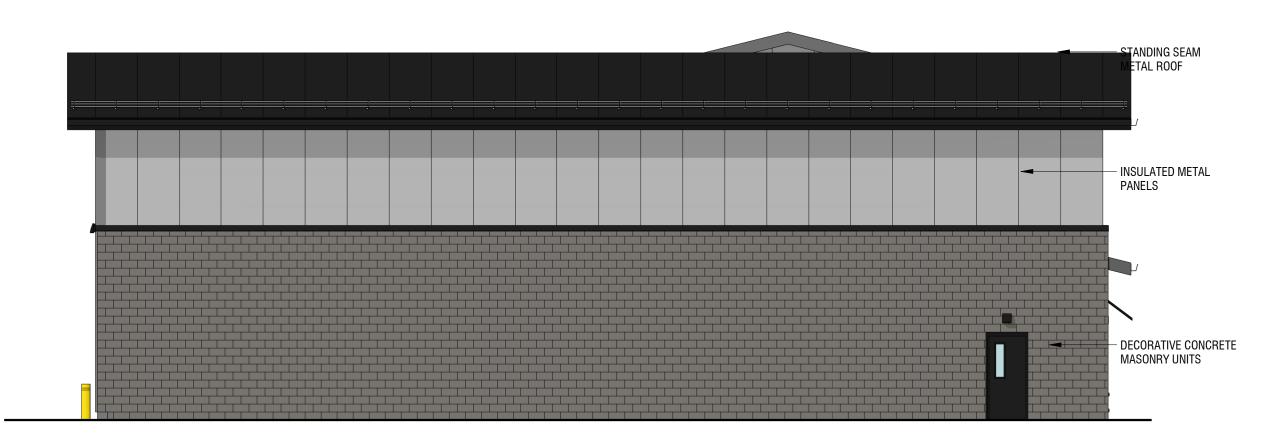








LaBella Powered by partnershi

300 Pearl Street, Suite 130 Buffalo, NY 14202 716-551-6281 labellapc.com

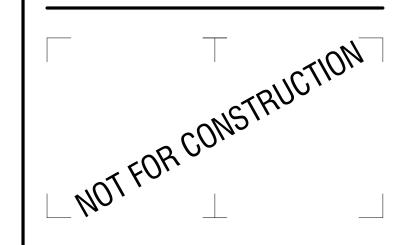

CERTIFICATE OF AUTHORIZATION NUMBER: PROFESSIONAL ENGINEERING: 018281 LAND SURVEYING: 017976 GEOLOGICAL: 018750

It is a violation of New York Education Law Art. 145 Sec. 7209 & Art. 147 Sec. 7307, for any person, unless acting under the direction of a licensed architect, professional engineer, or land surveyor, to alter an item in any way. If an item bearing the seal of an architect, engineer, or land surveyor is altered; the altering architect, engineer, or land surveyor shall affix to the item their seal and notation "altered by" followed by their signature and date of such alteration, and a specific description of the alteration.

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9500 MARTIN ROAD CLARENCE CENTER, NEW YORK 14032

# COMMERCIAL SITE DEVELOPMENT


0 COUNTY ROAD CLARENCE, NEW YORK 14032

| NO:         | DATE: | DESCRIPTION:    |
|-------------|-------|-----------------|
| Revisions   |       |                 |
| DDO ISOT NU | MDED  |                 |
| PROJECT NU  | MBEK: | 2250578         |
| DRAWN BY:   |       | JMR             |
| REVIEWED B  | Y:    | TBD             |
| ISSUED FOR: |       | E PLAN APPROVAL |
| DATE:       | 0     | CTOBER 8, 2025  |
| DRAWING NA  | ME:   |                 |

## EXTERIOR ELEVATIONS RENDERED


DRAWING NUMBER:

P201

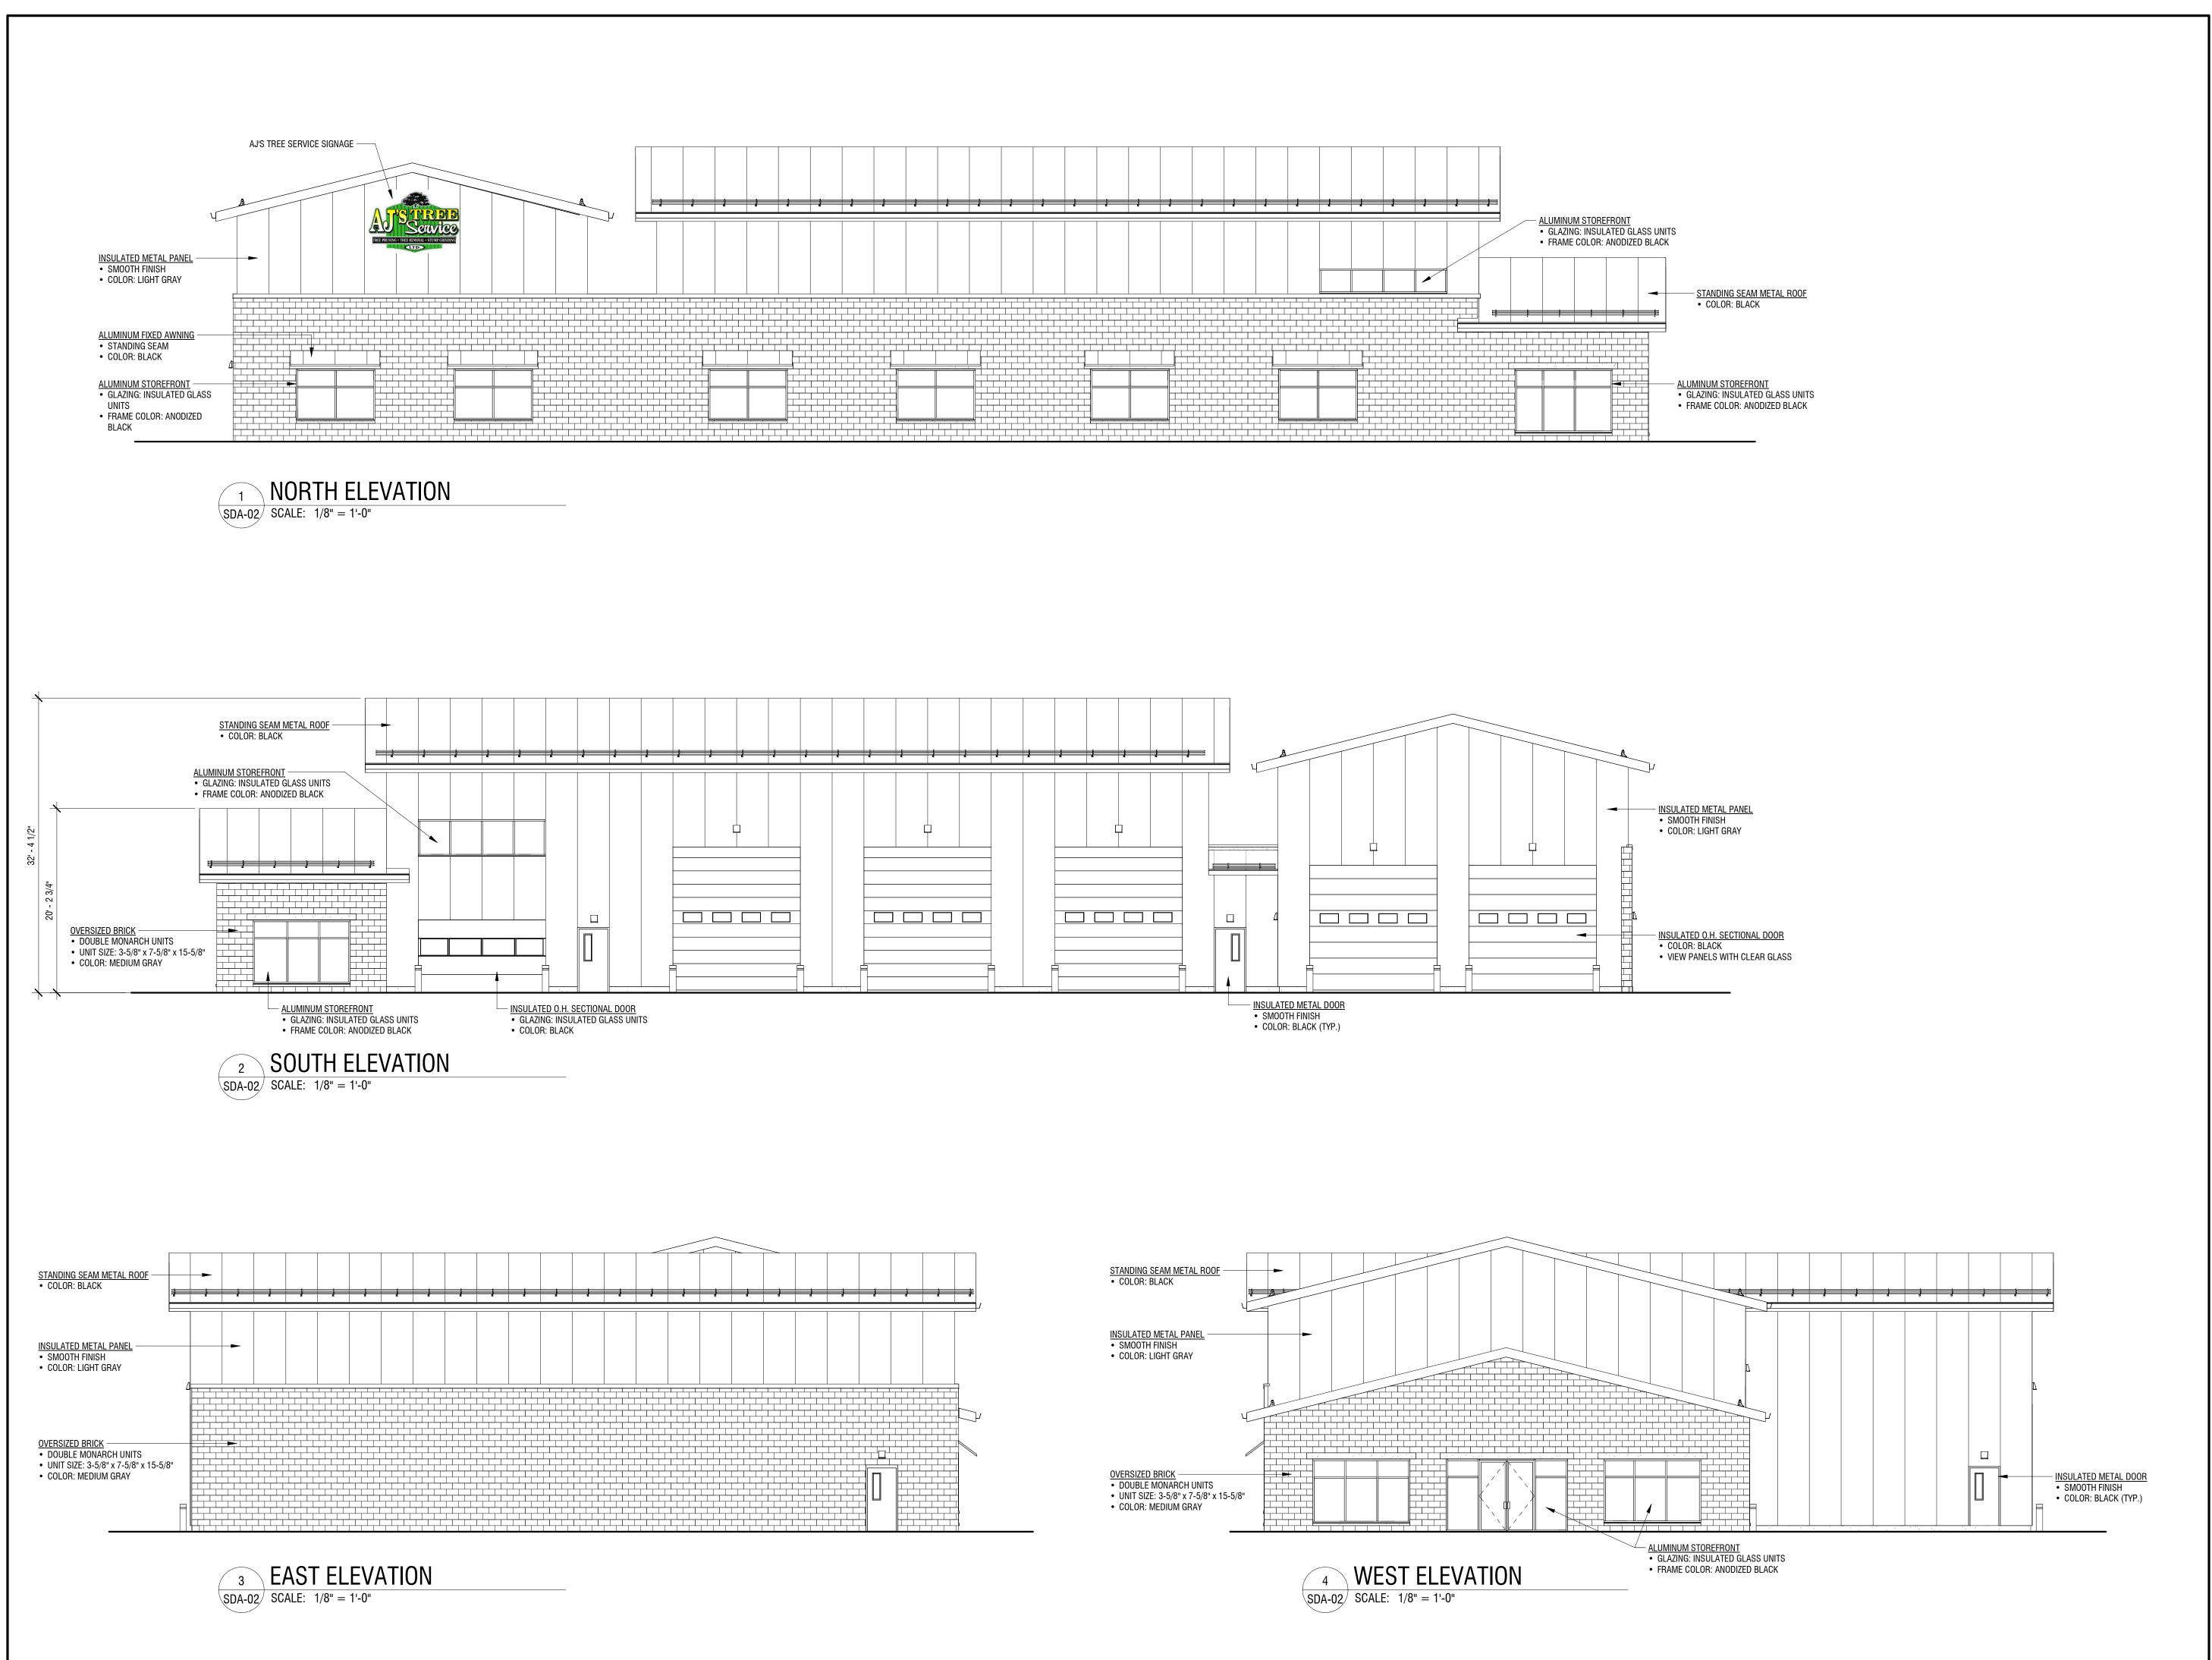



300 Pearl Street, Suite 130 Buffalo, NY 14202 716-551-6281 labellapc.com

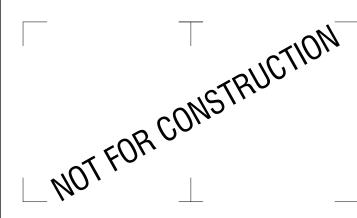

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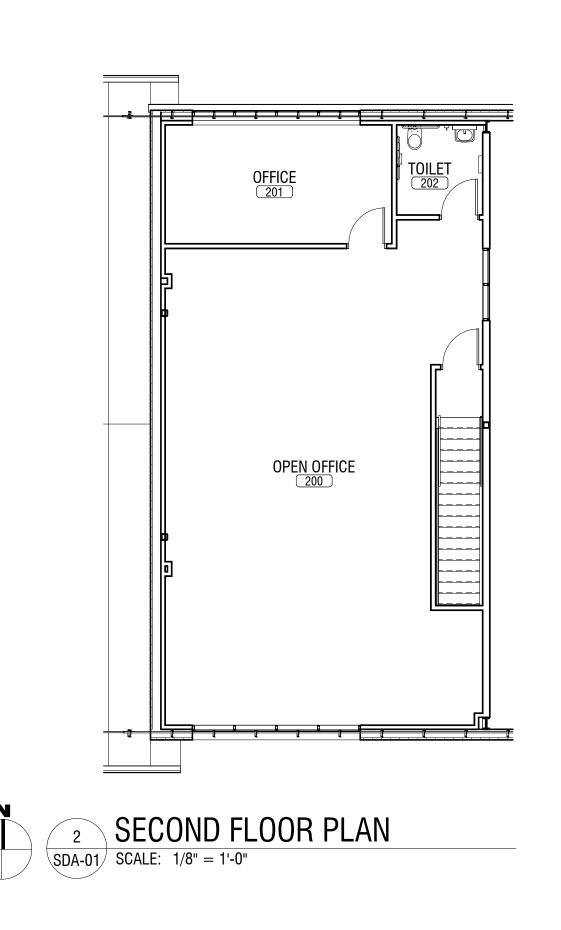
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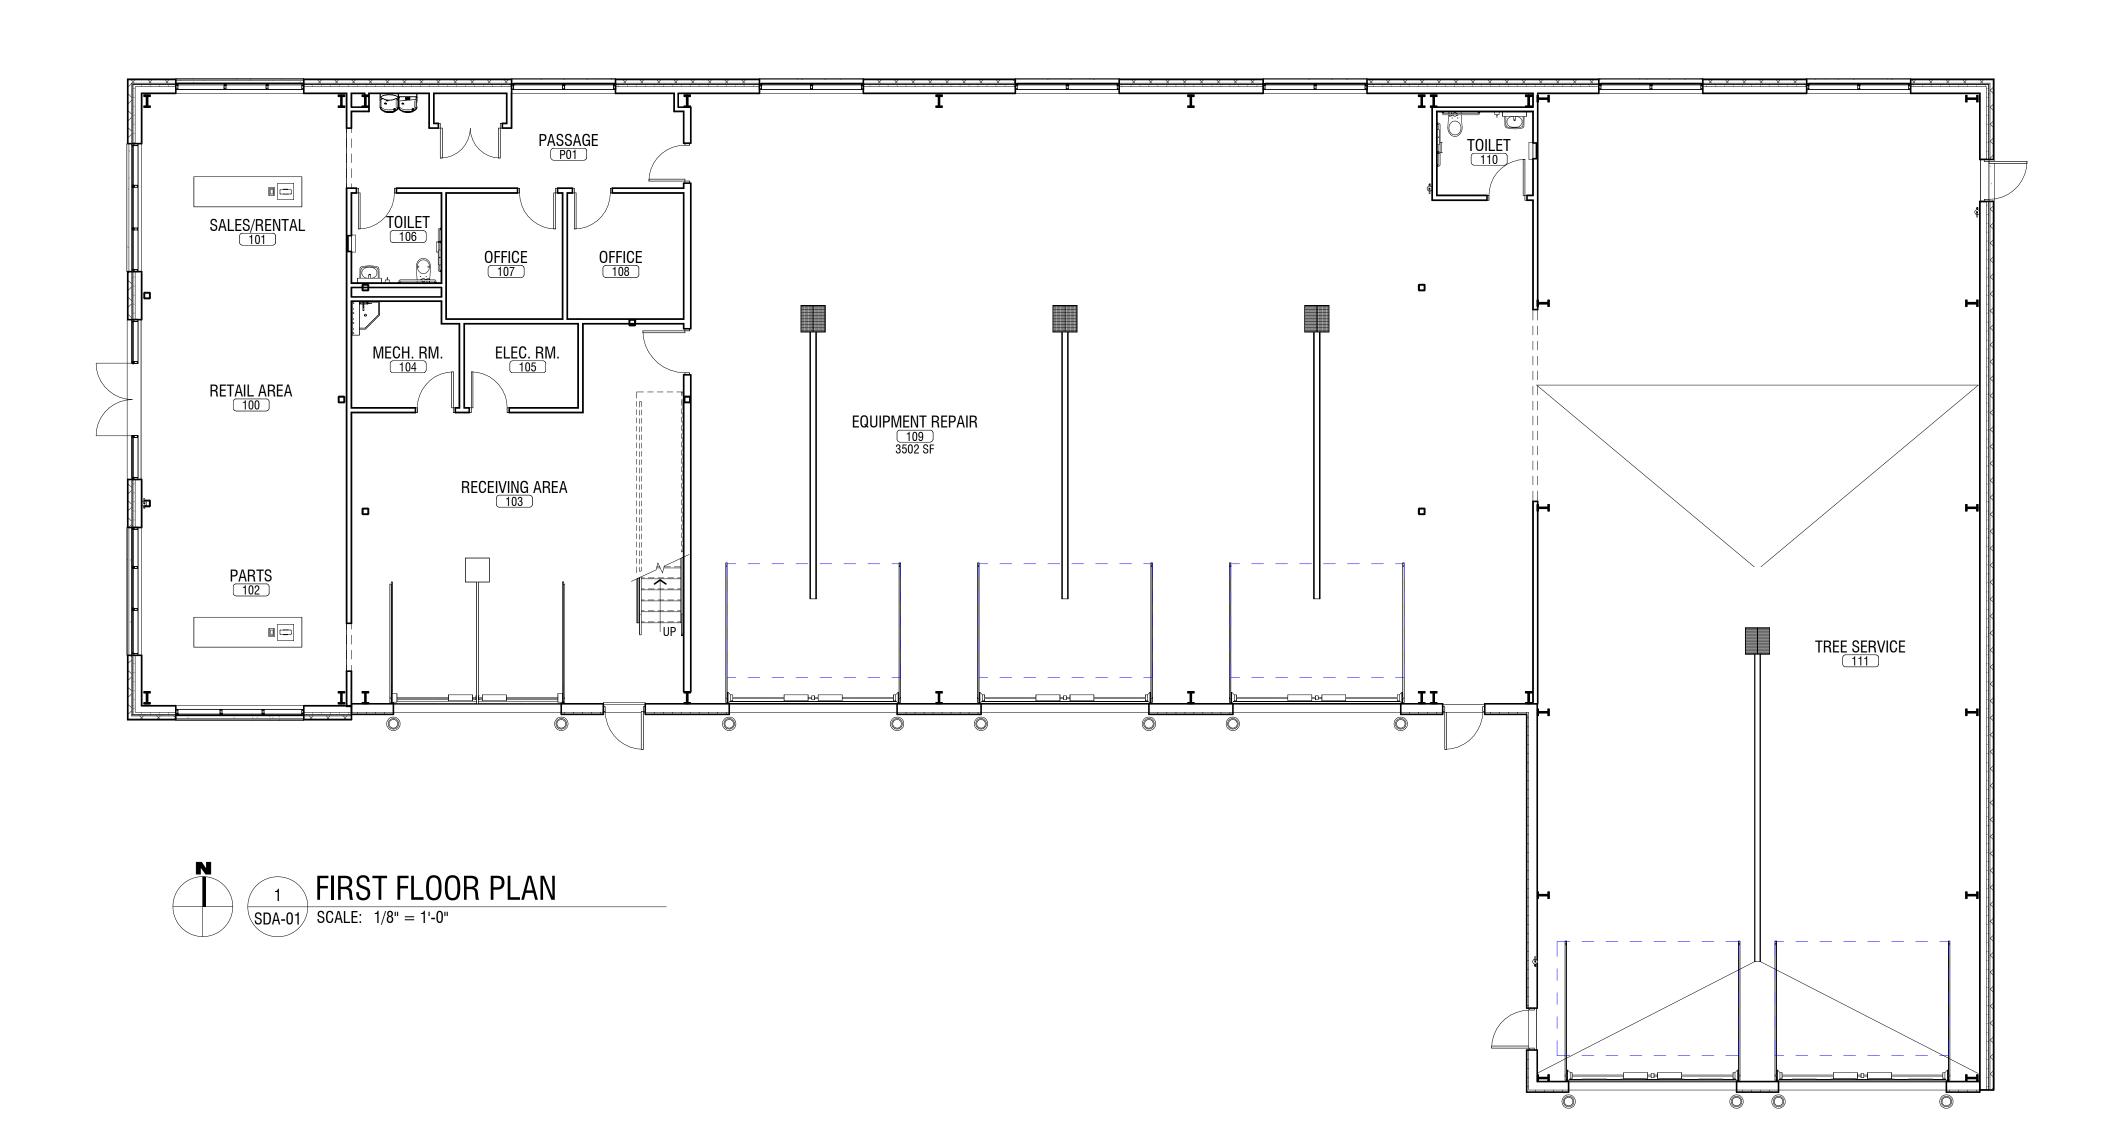
| NO:       | DATE:      | DESCRIPTION:       |  |
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| PROJECT N | NUMBER:    | 2250578            |  |
|           |            | 2230370            |  |
| DRAWN BY  | <b>/</b> : | JMR                |  |
| REVIEWED  | RV·        | OIVII (            |  |
| NEVIEVVED | ы.         | JAK                |  |
| ISSUED FO |            | EE DI ANI ADDDOVAL |  |
|           | SII        | TE PLAN APPROVAL   |  |
| DATE:     |            | 2070050 0 0005     |  |
|           | (          | OCTOBER 8, 2025    |  |
| DRAWING   | NAME:      |                    |  |

### **EXTERIOR ELEVATIONS**

DRAWING NUMBER:

**SDA-02** 







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CERTIFICATE OF AUTHORIZATION NUMBER: PROFESSIONAL ENGINEERING: 018281 LAND SURVEYING: 017976 GEOLOGICAL: 018750

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# COMMERCIAL SITE DEVELOPMENT

0 COUNTY ROAD CLARENCE, NEW YORK 14032


| NO:       | DATE:   | DESCRIPTION:     |
|-----------|---------|------------------|
| Revisions |         |                  |
|           |         |                  |
| PROJECT   | NUMBER: | 2250578          |
| DRAWN B   | Y:      | JMR              |
| REVIEWE   | D BY:   | JAK              |
| ISSUED FO |         | E PLAN APPROVAL  |
| DATE:     | SEI     | PTEMBER 12, 2025 |
| DRAWING   | NAME:   |                  |

**FLOOR PLANS** 

DRAWING NUMBER:

**SDA-01** 



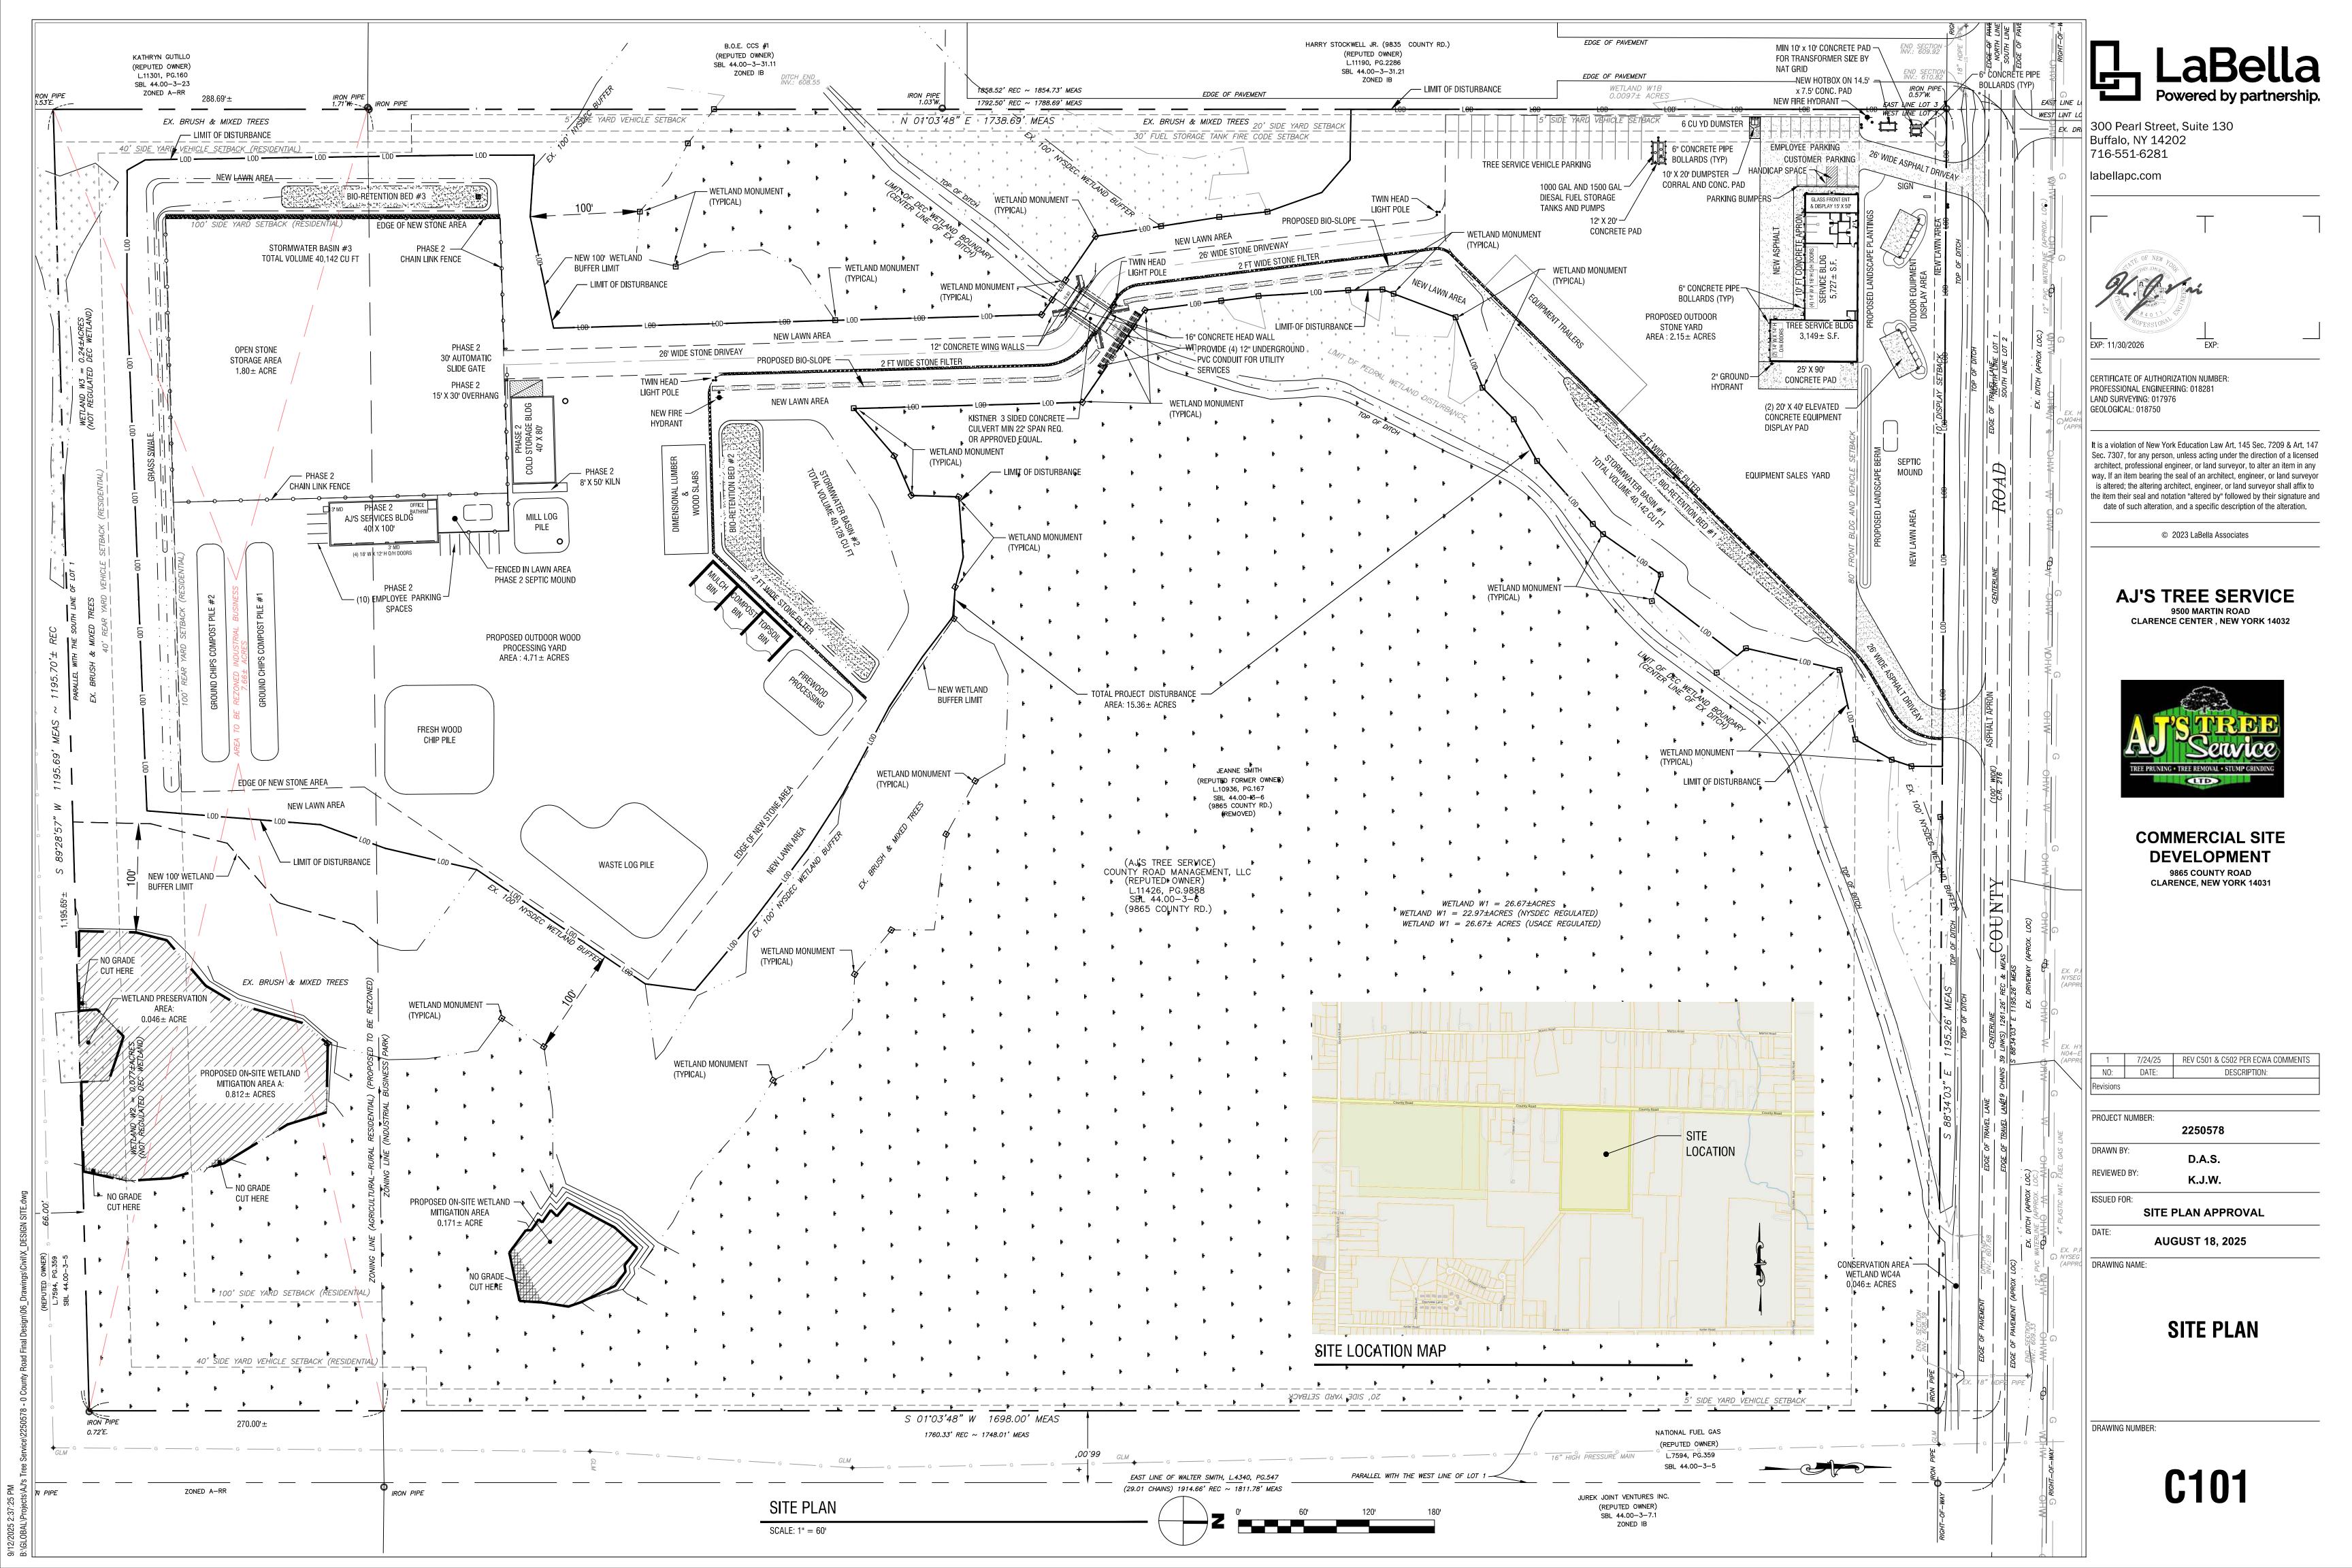



August 14, 2025

Jonathan Bleuer Town of Clarence Planning & Zoning Dept. One Town Place Clarence, New York

RE: SEQR Review & PB Comments
AJ's Tree Service
9865 County Rd.
Town of Clarence, New York
SEQR Response Letter – Dated July 17, 2025
Job No. 2250578

Dear Jonathan.

Our responses to the SEQR review letter received on July 17, 2025 from state and local agencies is below.

#### **NYSDEC**

1. DEC's amended Article 24, Freshwater Wetland Jurisdictional and Classification regulations (6 NYCRR Part 664) went into effect January 1, 2025. If regulated freshwater wetlands or adjacent areas are disturbed a Freshwater Wetland Permit must be obtained per (6 NYCRR Part 663).

#### Response:

A wetland verification letter was obtained from the NYSDEC on January 23, 2024 prior to the January 1, 2025 regulations taking effect. This project will have 1.595 acres of NYSDEC wetland and buffer disturbance along with 1.259 acres of USACE wetland disturbance. An Article 24 if needed will be submitted along with a Nationwide 14 permit. The NYSDEC letter received is valid until 2028. Copy of the letter is attached to this response.

2. Project may involve federally regulated wetlands which will require a Jurisdiction Determination and obtain a Section 401 Water Quality Certificate.

#### Response:

A federal wetland jurisdictional determination was obtained on June 23, 2025. A Nationwide Permit 14 will be applied for to obtain the issuance of the 401 WQC. Copy of the JD is attached to this response.

 The project area has indicated via the NYS Natural Heritage database that the Short-eared Owl may be impacted by the project. A Part 182 Endangered and Threatened Species Incidental Take permit will be required.

#### Response:

The IPaC was submitted on August 11, 2025 to the United States Dept Fish and Wildlife Services for final determination. Copy of the IPaC is attached to this response.



4. Project involving activities with land disturbance of 1 acre or more will need to obtain a State Pollutant Discharge Elimination System General Permit for Stormwater Discharges from Construction Activities (GP-0-25-001). The town of Clarence is designated as an MS4 community requiring review and approval of the Stormwater Pollution Prevention Plan (SWPPP) associated with (GP-0-25-001) before the eNOI can be submitted to NYSDEC for approval.

#### Response:

This project involves soil disturbance of 15.6 acres, therefore a MS4 accepted SWPPP will be designed and coordinated with state and local officials for this project.

5. Project involves storage of 1,100 gallons of petroleum products on-site, a NYSDEC Petroleum Bulk Storage (PBS) registration pursuant to (6 NYCRR Parts 612-614 Petroleum Bulk Storage Regulations) will be required.

#### Response:

This project involves storage of 2,500 gallons of diesel fuel within 2 above ground storage tanks. The current 1,000 gallon and 1,500 gallon tanks at 9500 Martin Road will be transferred from the current business to the proposed business at 9865 County Road, Clarence NY. Per regulations a PBS will be filed with the NYSDEC prior to that transfer.

6. Project site is located within Erie County Agricultural District #1, known as Alden-Newstead Agricultural District.

#### Response:

The location of this site is in District #1, however there will be no agricultural impact to the site. The 47.6 acre site contains 25.72 acres of NYSDEC and UASCE regulated wetlands with an intermittent waterway dividing the north and south sides of the parcel. The site has had no evidence of any current or past agricultural activity, therefore this project will have no impact to the district.

#### **Erie County Dept of Public Works**

1. Department requires a full set of site plans including a stormwater management report.

#### Response:

A full set of site plans and Stormwater management report will be submitted to ECDPW for review by August 22, 2025 to Garret Hacker

#### **ECWA**

1. Department requires review for any new service to the site.

#### Response:

Plans were submitted to ECWA for review and approval on July 24, 2025 via email to Adam Massaro.

#### **Erie County Division of Planning**

1. No recommendation, proposed action is a local concern.



#### Response:

Not applicable for review.

#### **Planning Board – Resident Comments**

- 1. 9955 Martin Road Kuchlewind Residence (fig 1)
  - a. Concerns with noise and sound from material production.
  - b. Has similar business behind them, the woodchipper is very loud.
- 2. 9995 Martin Road Sass Residence (fig 2)
  - a. Concerns with noise mitigation, woodchipper noise extreme and invasive.
  - b. Has years of un-mitigated noise from krantz and K&D Landscaping till 8:30 pm.
- 3. 10015 Martin Road DiMatteo Residence (fig 3)
  - a. Similar noise complaint as previous residences.
  - b. Prevailing wind blows dirt and dust in direction of residence.
- 4. 9854 Keller Road Castellani Residence (fig 4 & 5)
  - a. Millhusrt Construction to the east has a woodchipper that is very loud.
  - b. Concerned how far from gas line applicants woodchipper would be.

#### Response:

The residence concerns of the noise levels in the area seem to be generated by the existing businesses immediately abutting the property lines along the south side of Martin Road and east of the proposed location on County Road. AJ's Tree Service will work with the neighbors and Town of Clarence in keeping noise levels to a minimum as possible during evening hours. AJ's will look into noise mitigation availability on any equipment that they will purchase for the business. The project site will maintain existing vegetation, trees and wetland areas where possible to help with noise reduction.

Based on location of the proposed project on County Road, the closest residence from Martin Road is approximately 2,470 ft north of the proposed yard where wood chipping would take place. The sound from this machine along with the existing vegetation and distance away should not create additional noise levels over current conditions.

The residence located at 9854 Keller Road is approximately 3,050 ft SW of Millhurst Construction where the chipper is located. AJ's Tree Service is approximately 2,367 ft north 9854 Keller Road residence where wood chipping would take place. The sound from this machine may have an impact on the south residence, however there is enough existing vegetation along the south portion of the proposed project along with a min 60 ft buffer and approximately 1000+ feet of existing vegetation between the residence and proposed work area of the chipper to help in providing a natural noise buffer. The existing gas line sits within a 60' foot wide Right-of-way and will be approximately 150+ feet from the closet proposed woodchipper.





Figure 1



Figure 2



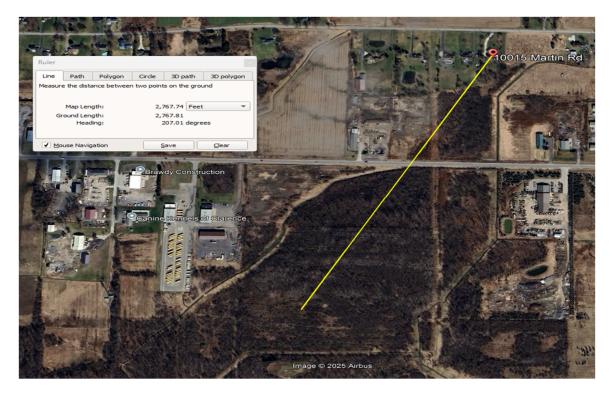


Figure 3



Figure 4





Figure 5

Please forward any additional comments or questions to my office via email or by phone.

Thank you

#### **David Stutz**

LaBella Associates | Senior Civil Engineer

716 710-3060 Direct Line 716-551-6281 Office/ Ext 7136 716-946-6391 Cell 300 Pearl Street, Suite 130 Buffalo, NY 14202

Website: LaBellaPC.com
Email: dstutz@LaBellaPC.com

6221 Goodrich Road Clarence Center, New York 14032 Phone: (716) 741-8952 Fax: (716) 407-8915

### **Town of Clarence Engineering Department**

## Memo



To: Jonathan Bleuer, Director of Community Development

From: Joseph Lancellotti, Asst. Municipal Engineer

cc: David Stutz, Labella Associates, 300 Pearl Street, Buffalo, NY 14202

Jeff Tomaro, AJ's Tree Service, 9500 Martin Road, Clarence Center, NY 14032

Timothy Lavocat, P.E., Town Engineer

File

Date: September 30, 2025

9865 County – AJ's Tree Service - Preliminary Grading and Drainage Plan Review

Jon,

Re:

The Engineering Department has reviewed the Preliminary Grading and Drainage Plans dated August 18, 2025 and received on September 18, 2025. This concept level review is not an all-inclusive project review and additional comments may be warranted and provided at any time throughout the formal project review process. The below comments are to be addressed for preliminary grading and drainage plan resubmittal. This Department has no further comments at this time.

#### Full Environmental Assessment Form Part 1 - Project and Setting

#### **Instructions for Completing Part 1**

**Part 1 is to be completed by the applicant or project sponsor.** Responses become part of the application for approval or funding, are subject to public review, and may be subject to further verification.

Complete Part 1 based on information currently available. If additional research or investigation would be needed to fully respond to any item, please answer as thoroughly as possible based on current information; indicate whether missing information does not exist, or is not reasonably available to the sponsor; and, when possible, generally describe work or studies which would be necessary to update or fully develop that information.

Applicants/sponsors must complete all items in Sections A & B. In Sections C, D & E, most items contain an initial question that must be answered either "Yes" or "No". If the answer to the initial question is "Yes", complete the sub-questions that follow. If the answer to the initial question is "No", proceed to the next question. Section F allows the project sponsor to identify and attach any additional information. Section G requires the name and signature of the applicant or project sponsor to verify that the information contained in Part 1 is accurate and complete.

#### A. Project and Applicant/Sponsor Information.

| Name of Action or Project:  |            |           |  |
|---|------------|-----------|--|
|   |            |           |  |
| Project Location (describe, and attach a general location map):     |            |           |  |
|   |            |           |  |
|   |            |           |  |
| Brief Description of Proposed Action (include purpose or need):     |            |           |  |
|   |            |           |  |
|   |            |           |  |
| Name of Applicant/Sponsor:  | Telephone: |           |  |
| Tunio di Appireuni Sponsoi.   |            |           |  |
|   | E-Mail:    |           |  |
| Address:  |            |           |  |
| Address.  |            |           |  |
| City/PO:  | State:     | Zip Code: |  |
| City/1 o.   | State.     | zip couc. |  |
| Project Contact (if not same as sponsor; give name and title/role): | Telephone: |           |  |
|   |            |           |  |
|   | E-Mail:    |           |  |
| Address:  |            |           |  |
| Tidd Voo.   |            |           |  |
| C'. DO  | g, ,       | 7' 0 1    |  |
| City/PO:  | State:     | Zip Code: |  |
|   |            |           |  |
| Property Owner (if not same as sponsor):                            | Telephone: |           |  |
|   | E-Mail:    |           |  |
|   | E Mun.     |           |  |
| Address:  |            |           |  |
|   |            |           |  |
| City/PO:  | State:     | Zip Code: |  |
|   |            |           |  |

#### **B.** Government Approvals

| <b>B.</b> Government Approvals, Funding, or Sponsorship. ("Funding" includes grants, loans, tax relief, and any other forms of financial assistance.)   |  |                     |                          |  |
|---|--|---------------------|--------------------------|--|
| Government Entity   | If Yes: Identify Agency and Approval(s)  Required  (Actual or p  |                     |                          |  |
| a. City Counsel, Town Board, ☐ Yes ☐ No or Village Board of Trustees  |  |                     |                          |  |
| b. City, Town or Village ☐ Yes ☐ No<br>Planning Board or Commission   |  |                     |                          |  |
| c. City, Town or ☐ Yes ☐ No Village Zoning Board of Appeals   |  |                     |                          |  |
| d. Other local agencies □ Yes □ No  |  |                     |                          |  |
| e. County agencies □ Yes □ No   |  |                     |                          |  |
| f. Regional agencies □ Yes □ No   |  |                     |                          |  |
| g. State agencies □ Yes □ No  |  |                     |                          |  |
| h. Federal agencies □ Yes □ No  |  |                     |                          |  |
| <ul><li>i. Coastal Resources.</li><li>i. Is the project site within a Coastal Area, or the waterfront area of a Designated Inland Waterway?</li></ul>   |  |                     |                          |  |
| <ul><li>ii. Is the project site located in a community with an approved Local Waterfront Revitalization Program?</li><li>iii. Is the project site within a Coastal Erosion Hazard Area?</li></ul> |  |                     | □ Yes □ No<br>□ Yes □ No |  |
| C. Planning and Zoning  |  |                     |                          |  |
| C.1. Planning and zoning actions.   |  |                     |                          |  |
| only approval(s) which must be granted to enal  • If Yes, complete sections C, F and G.   | mendment of a plan, local law, ordinance, rule or<br>ble the proposed action to proceed?<br>mplete all remaining sections and questions in Par | -                   | □ Yes □ No               |  |
| C.2. Adopted land use plans.  |  |                     |                          |  |
| a. Do any municipally- adopted (city, town, vil where the proposed action would be located?   | lage or county) comprehensive land use plan(s) is  | nclude the site     | □ Yes □ No               |  |
|   | ecific recommendations for the site where the pro-   | posed action        | □ Yes □ No               |  |
|   | ocal or regional special planning district (for exa<br>nated State or Federal heritage area; watershed ma                                      |                     | □ Yes □ No               |  |
|   |  |                     |                          |  |
| c. Is the proposed action located wholly or part or an adopted municipal farmland protection If Yes, identify the plan(s):  | ially within an area listed in an adopted municipan plan?  | al open space plan, | □ Yes □ No               |  |
|   |  |                     |                          |  |

| C.3. Zoning  |                |
|--|----------------|
| a. Is the site of the proposed action located in a municipality with an adopted zoning law or ordinance. If Yes, what is the zoning classification(s) including any applicable overlay district?   | □ Yes □ No     |
|  |                |
| b. Is the use permitted or allowed by a special or conditional use permit?   | □ Yes □ No     |
| c. Is a zoning change requested as part of the proposed action? If Yes,  | □ Yes □ No     |
| i. What is the proposed new zoning for the site?   |                |
| C.4. Existing community services.  |                |
| a. In what school district is the project site located?  |                |
| b. What police or other public protection forces serve the project site?   |                |
| c. Which fire protection and emergency medical services serve the project site?  |                |
| d. What parks serve the project site?  |                |
|  |                |
| D. Project Details   |                |
| D.1. Proposed and Potential Development  |                |
| a. What is the general nature of the proposed action (e.g., residential, industrial, commercial, recreational; if mixed components)?   | , include all  |
| b. a. Total acreage of the site of the proposed action? acres  |                |
| b. Total acreage to be physically disturbed? acres c. Total acreage (project site and any contiguous properties) owned or controlled by the applicant or project sponsor? acres  |                |
| c. Is the proposed action an expansion of an existing project or use?  | □ Yes □ No     |
| i. If Yes, what is the approximate percentage of the proposed expansion and identify the units (e.g., acres, miles, square feet)? % Units:   | housing units, |
| d. Is the proposed action a subdivision, or does it include a subdivision?   | □ Yes □ No     |
| If Yes, <i>i.</i> Purpose or type of subdivision? (e.g., residential, industrial, commercial; if mixed, specify types)   |                |
| <ul><li>ii. Is a cluster/conservation layout proposed?</li><li>iii. Number of lots proposed?</li></ul>   | □ Yes □ No     |
| iv. Minimum and maximum proposed lot sizes? Minimum Maximum  |                |
| e. Will the proposed action be constructed in multiple phases?  i. If No, anticipated period of construction: months  ii. If Yes:  | □ Yes □ No     |
| <ul> <li>Total number of phases anticipated</li> <li>Anticipated commencement date of phase 1 (including demolition) month year</li> <li>Anticipated completion date of final phase month year</li> <li>Generally describe connections or relationships among phases, including any contingencies where progress determine timing or duration of future phases:</li> </ul> |                |
|  |                |

|                      | t include new resid              |                     |                        |   | □ Yes □ No         |
|----------------------|----------------------------------|---------------------|------------------------|---|--------------------|
| If Yes, show num     | bers of units propo              |                     |                        |   |                    |
|                      | One Family                       | Two Family          | Three Family           | Multiple Family (four or more)  |                    |
| Initial Phase        |                                  |                     |                        |   |                    |
| At completion        |                                  |                     |                        |   |                    |
| of all phases        |                                  |                     |                        | - <del></del> -   |                    |
| D 4                  | 1 1 1                            |                     | 1                      | 1   | - 77 - 77          |
|                      | osed action include              | new non-residentia  | al construction (inclu | iding expansions)?  | □ Yes □ No         |
| If Yes,              | of structures                    |                     |                        |   |                    |
| ii Dimensions (      | in feet) of largest p            | ronosed structure   | height:                | width; andlength  |                    |
| iii. Approximate     | extent of building s             | space to be heated  | or cooled:             | square feet   |                    |
|                      |                                  |                     |                        | I result in the impoundment of any  | □ Yes □ No         |
|                      |                                  |                     |                        | agoon or other storage?   | □ Tes □ No         |
| If Yes,              | s creation of a water            | suppry, reservoir,  | , pond, lake, waste ia | igoon of other storage:   |                    |
|                      | impoundment:                     |                     |                        |   |                    |
| ii. If a water imp   | impoundment:oundment, the prince | cipal source of the | water:                 | ☐ Ground water ☐ Surface water stream                                       | s □ Other specify: |
|                      |                                  |                     |                        |   |                    |
| iii. If other than w | vater, identify the ty           | pe of impounded/o   | contained liquids and  | d their source.   |                    |
| iv. Approximate      | size of the proposed             | d impoundment.      | Volume:                | million gallons; surface area:  | acres              |
| v. Dimensions o      | f the proposed dam               | or impounding str   | ucture:                | height; length  |                    |
|                      |                                  |                     |                        | ructure (e.g., earth fill, rock, wood, conc                                 | rete):             |
|                      |                                  |                     |                        |   |                    |
| D.2. Project Op      | erations                         |                     |                        |   |                    |
|                      |                                  |                     | ning on Anadaina da    | i   | D Van D Na         |
|                      |                                  |                     |                        | uring construction, operations, or both? or foundations where all excavated | □ Yes □ No         |
| materials will r     |                                  | mon, grading or in  | stanation of utilities | or foundations where all excavated  |                    |
| If Yes:              | cmam onsite)                     |                     |                        |   |                    |
|                      | rnose of the excava              | tion or dredging?   |                        |   |                    |
|                      |                                  |                     |                        | be removed from the site?   | -                  |
|                      |                                  |                     |                        |   |                    |
|                      | at duration of time?             |                     |                        |   |                    |
|                      |                                  |                     |                        | ged, and plans to use, manage or dispose                                    | of them.           |
|                      |                                  |                     |                        |   |                    |
| iv. Will there be    | onsite dewatering of             | or processing of ex | cavated materials?     |   | □ Yes □ No         |
|                      |                                  |                     |                        |   |                    |
| v What is the to     | ital area to be dredg            | ed or excavated?    |                        | acres   |                    |
| vi What is the m     | aximum area to be                | worked at any one   | time?                  | acres   |                    |
|                      |                                  | •                   |                        | feet  |                    |
|                      | vation require blast             |                     | 7 drod5m5              | 1001  | □ Yes □ No         |
|                      |                                  |                     |                        |   |                    |
|                      |                                  | <u> </u>            |                        |   |                    |
|                      |                                  |                     |                        |   |                    |
|                      |                                  |                     |                        |   |                    |
|                      |                                  |                     |                        | crease in size of, or encroachment  | □ Yes □ No         |
| •                    | ng wetland, waterb               | ody, shoreline, bea | ch or adjacent area?   |   |                    |
| If Yes:              | .1 1 . 1 . 1                     | 1.1 11.             | CC 4 1 /1              |   |                    |
|                      |                                  |                     |                        | vater index number, wetland map number                                      |                    |
| description):        |                                  |                     |                        |   |                    |
|                      |                                  |                     |                        |   |                    |

| ii. Describe how the proposed action would affect that waterbody or wetland, e.g. excavation, fill, placem alteration of channels, banks and shorelines. Indicate extent of activities, alterations and additions in sq |                   |
|---|-------------------|
|   |                   |
| iii. Will the proposed action cause or result in disturbance to bottom sediments?  If Yes, describe:  | Yes □ No          |
| <i>iv</i> . Will the proposed action cause or result in the destruction or removal of aquatic vegetation? If Yes:   | □ Yes □ No        |
| acres of aquatic vegetation proposed to be removed:   |                   |
| expected acreage of aquatic vegetation remaining after project completion:  |                   |
| • purpose of proposed removal (e.g. beach clearing, invasive species control, boat access):   |                   |
| proposed method of plant removal:   |                   |
| if chemical/herbicide treatment will be used, specify product(s):   |                   |
| v. Describe any proposed reclamation/mitigation following disturbance:  |                   |
| . Will the proposed action use, or create a new demand for water?   | □ Yes □ No        |
| Yes:  |                   |
| i. Total anticipated water usage/demand per day: gallons/day  |                   |
| ii. Will the proposed action obtain water from an existing public water supply?   | □ Yes □ No        |
| Yes:  |                   |
| Name of district or service area:   |                   |
| Does the existing public water supply have capacity to serve the proposal?  Let be a principle of the principle of the proposal.  | □ Yes □ No        |
| • Is the project site in the existing district?   | □ Yes □ No        |
| Is expansion of the district needed?  | □ Yes □ No        |
| Do existing lines serve the project site?  Will be a serve the project site?  | □ Yes □ No        |
| ii. Will line extension within an existing district be necessary to supply the project? Yes:  | □ Yes □ No        |
| Describe extensions or capacity expansions proposed to serve this project:  |                   |
| Source(s) of supply for the district:   |                   |
| iv. Is a new water supply district or service area proposed to be formed to serve the project site? Yes:  | □ Yes □ No        |
| Applicant/sponsor for new district:   |                   |
| Date application submitted or anticipated:  |                   |
| Proposed source(s) of supply for new district:  |                   |
| v. If a public water supply will not be used, describe plans to provide water supply for the project:   |                   |
| vi. If water supply will be from wells (public or private), what is the maximum pumping capacity:   | _ gallons/minute. |
| . Will the proposed action generate liquid wastes?  | □ Yes □ No        |
| Yes:  |                   |
| i. Total anticipated liquid waste generation per day: gallons/day   | 11 . 1            |
| ii. Nature of liquid wastes to be generated (e.g., sanitary wastewater, industrial; if combination, describe a approximate volumes or proportions of each):   |                   |
| approximate volumes of proportions of each).  |                   |
| i. Will the proposed action use any existing public wastewater treatment facilities?  If Yes:   | □ Yes □ No        |
| Name of wastewater treatment plant to be used:  |                   |
| Name of district:   |                   |
| <ul> <li>Does the existing wastewater treatment plant have capacity to serve the project?</li> </ul>  | □ Yes □ No        |
| <ul> <li>Is the project site in the existing district?</li> </ul>   | □ Yes □ No        |
| <ul> <li>Is expansion of the district needed?</li> </ul>  | □ Yes □ No        |

| Do existing sewer lines serve the project site?   | □ Yes □ No                 |
|---|----------------------------|
| • Will a line extension within an existing district be necessary to serve the project?  | □ Yes □ No                 |
| If Yes:   |                            |
| Describe extensions or capacity expansions proposed to serve this project:  |                            |
|   |                            |
| iv. Will a new wastewater (sewage) treatment district be formed to serve the project site?  | □ Yes □ No                 |
| If Yes:   |                            |
| Applicant/sponsor for new district:   | -                          |
| Date application submitted or anticipated:  |                            |
| What is the receiving water for the wastewater discharge?   |                            |
| v. If public facilities will not be used, describe plans to provide wastewater treatment for the project, including speci   | fying proposed             |
| receiving water (name and classification if surface discharge or describe subsurface disposal plans):   |                            |
| vi. Describe any plans or designs to capture, recycle or reuse liquid waste:  |                            |
|   |                            |
| e. Will the proposed action disturb more than one acre and create stormwater runoff, either from new point sources (i.e. ditches, pipes, swales, curbs, gutters or other concentrated flows of stormwater) or non-point | □ Yes □ No                 |
| sources (i.e. thenes, pipes, swales, curbs, guiters of other concentrated flows of stormwater) of non-point source (i.e. sheet flow) during construction or post construction?  |                            |
| If Yes:   |                            |
| i. How much impervious surface will the project create in relation to total size of project parcel?   |                            |
| Square feet or acres (impervious surface)   |                            |
| Square feet or acres (parcel size)  |                            |
| ii. Describe types of new point sources.  |                            |
| iii. Where will the stormwater runoff be directed (i.e. on-site stormwater management facility/structures, adjacent pr groundwater, on-site surface water or off-site surface waters)?                                  |                            |
| If to surface waters, identify receiving water bodies or wetlands:  |                            |
|   |                            |
| Will stormwater runoff flow to adjacent properties?   | □ Yes □ No                 |
| <i>iv.</i> Does the proposed plan minimize impervious surfaces, use pervious materials or collect and re-use stormwater?  | □ Yes □ No                 |
| f. Does the proposed action include, or will it use on-site, one or more sources of air emissions, including fuel   | □ Yes □ No                 |
| combustion, waste incineration, or other processes or operations?   |                            |
| If Yes, identify:   |                            |
| i. Mobile sources during project operations (e.g., heavy equipment, fleet or delivery vehicles)   |                            |
| ii. Stationary sources during construction (e.g., power generation, structural heating, batch plant, crushers)  |                            |
| iii. Stationary sources during operations (e.g., process emissions, large boilers, electric generation)   |                            |
| g. Will any air emission sources named in D.2.f (above), require a NY State Air Registration, Air Facility Permit,  | □ Yes □ No                 |
| or Federal Clean Air Act Title IV or Title V Permit?  | - 1 <b>c</b> 5 - 110       |
| If Yes:   |                            |
| i. Is the project site located in an Air quality non-attainment area? (Area routinely or periodically fails to meet   | $\square$ Yes $\square$ No |
| ambient air quality standards for all or some parts of the year)  |                            |
| ii. In addition to emissions as calculated in the application, the project will generate:   |                            |
| •Tons/year (short tons) of Carbon Dioxide (CO <sub>2</sub> )  |                            |
| •Tons/year (short tons) of Nitrous Oxide (N <sub>2</sub> O)   |                            |
| •Tons/year (short tons) of Perfluorocarbons (PFCs)  |                            |
| •Tons/year (short tons) of Sulfur Hexafluoride (SF <sub>6</sub> )   |                            |
| •Tons/year (short tons) of Carbon Dioxide equivalent of Hydroflourocarbons (HFCs)   |                            |
| • Tons/year (short tons) of Hazardous Air Pollutants (HAPs)   |                            |

| h. Will the proposed action generate or emit methane (includ landfills, composting facilities)?  If Yes:  |  | □ Yes □ No |
|---|--|------------|
| <ul> <li>i. Estimate methane generation in tons/year (metric):</li> <li>ii. Describe any methane capture, control or elimination measures included in project design (e.g., combustion to generate heat or electricity, flaring):</li> </ul>  |  |            |
| Will the proposed action result in the release of air pollutar quarry or landfill operations?  If Yes: Describe operations and nature of emissions (e.g., die)  |  | □ Yes □ No |
| j. Will the proposed action result in a substantial increase in a new demand for transportation facilities or services?  If Yes:  i. When is the peak traffic expected (Check all that apply):  □ Randomly between hours of to to   | ☐ Morning ☐ Evening ☐ Weekend<br>  | □ Yes □ No |
| <ul> <li>iii. Parking spaces: Existing</li></ul>  | ting roads, creation of new roads or change in existing a vailable within ½ mile of the proposed site?  ortation or accommodations for use of hybrid, electric | Yes No     |
| <ul> <li>k. Will the proposed action (for commercial or industrial profor energy?</li> <li>If Yes: <ul> <li>i. Estimate annual electricity demand during operation of th</li> </ul> </li> <li>ii. Anticipated sources/suppliers of electricity for the project other):</li> <li>iii. Will the proposed action require a new, or an upgrade, to</li> </ul> | te proposed action:t (e.g., on-site combustion, on-site renewable, via grid/lo   |            |
| Hours of operation. Answer all items which apply.     i. During Construction:   | <ul> <li>ii. During Operations:</li> <li>Monday - Friday:</li></ul>  |            |

| m. Will the proposed action produce noise that will exceed existing ambient noise levels during construction,  | □ Yes □ No  |
|--|-------------|
| operation, or both? If yes:  |             |
| i. Provide details including sources, time of day and duration:  |             |
|  | <del></del> |
| <i>ii.</i> Will the proposed action remove existing natural barriers that could act as a noise barrier or screen?  | □ Yes □ No  |
| Describe:  |             |
|  |             |
| n. Will the proposed action have outdoor lighting? If yes:   | □ Yes □ No  |
| <ul><li>i. Describe source(s), location(s), height of fixture(s), direction/aim, and proximity to nearest occupied structures:</li></ul>                       |             |
|  |             |
| <i>ii.</i> Will proposed action remove existing natural barriers that could act as a light barrier or screen?  | □ Yes □ No  |
| Describe:  |             |
|  |             |
| o. Does the proposed action have the potential to produce odors for more than one hour per day?  | □ Yes □ No  |
| If Yes, describe possible sources, potential frequency and duration of odor emissions, and proximity to nearest  |             |
| occupied structures:   |             |
|  |             |
| p. Will the proposed action include any bulk storage of petroleum (combined capacity of over 1,100 gallons)  | □ Yes □ No  |
| or chemical products 185 gallons in above ground storage or any amount in underground storage?   |             |
| If Yes:  |             |
| <ul><li>i. Product(s) to be stored</li></ul>   |             |
| iii. Generally, describe the proposed storage facilities:  |             |
|  |             |
| q. Will the proposed action (commercial, industrial and recreational projects only) use pesticides (i.e., herbicides,  | □ Yes □ No  |
| insecticides) during construction or operation?  |             |
| <ul><li>If Yes:</li><li>i. Describe proposed treatment(s):</li></ul>   |             |
|  |             |
|  |             |
|  |             |
| ii. Will the proposed action use Integrated Pest Management Practices?   | □ Yes □ No  |
| r. Will the proposed action (commercial or industrial projects only) involve or require the management or disposal   | □ Yes □ No  |
| of solid waste (excluding hazardous materials)? If Yes:  |             |
| <i>i.</i> Describe any solid waste(s) to be generated during construction or operation of the facility:  |             |
| • Construction: tons per (unit of time)  |             |
| • Operation : tons per (unit of time)  |             |
| <ul><li>ii. Describe any proposals for on-site minimization, recycling or reuse of materials to avoid disposal as solid waste:</li><li>Construction:</li></ul> |             |
| Construction.  |             |
| • Operation:   |             |
| iii. Proposed disposal methods/facilities for solid waste generated on-site:   | <del></del> |
| Construction:  |             |
|  |             |
| Operation:   |             |
|  |             |

| s. Does the proposed action include construction or mod   | ification of a solid waste mana   | gement facility?             | □ Yes □ No     |  |
|---|-----------------------------------|------------------------------|----------------|--|
| If Yes:   |                                   |                              |                |  |
| i. Type of management or handling of waste proposed for the site (e.g., recycling or transfer station, composting, landfill, or   |                                   |                              |                |  |
| other disposal activities):   |                                   |                              |                |  |
| ii. Anticipated rate of disposal/processing:  |                                   |                              |                |  |
| • Tons/month, if transfer or other non-combustion/thermal treatment, or   |                                   |                              |                |  |
| • Tons/hour, if combustion or thermal treatment   |                                   |                              |                |  |
| iii. If landfill, anticipated site life:  | years                             |                              |                |  |
| t. Will the proposed action at the site involve the comme   | ercial generation, treatment, sto | rage, or disposal of hazard  | ous □ Yes □ No |  |
| waste?  |                                   |                              |                |  |
| If Yes:   |                                   |                              |                |  |
| i. Name(s) of all hazardous wastes or constituents to be  | e generated, handled or manage    | ed at facility:              |                |  |
|   |                                   |                              | <del></del>    |  |
| =   |                                   |                              |                |  |
| ii. Generally describe processes or activities involving  | hazardous wastes or constituen    | ts:                          |                |  |
|   |                                   |                              |                |  |
| iii. Specify amount to be handled or generatedt   | ons/month                         |                              |                |  |
| <i>iv.</i> Describe any proposals for on-site minimization, rec   |                                   | onstituents:                 |                |  |
| w. Describe any proposais for on-site minimization, rec   | Lyching of feuse of hazardous e   | onstituents.                 |                |  |
|   |                                   |                              |                |  |
| v. Will any hazardous wastes be disposed at an existing   | g offsite hazardous waste facili  | ty?                          | □ Yes □ No     |  |
| If Yes: provide name and location of facility:  |                                   |                              |                |  |
|   |                                   |                              |                |  |
| If No: describe proposed management of any hazardous  | wastes which will not be sent     | to a hazardous waste facilit | ty:            |  |
|   |                                   |                              |                |  |
|   |                                   |                              |                |  |
|   |                                   |                              |                |  |
| E. Site and Setting of Proposed Action  |                                   |                              |                |  |
| E 1 Land uses an and suppounding the preject site   |                                   |                              |                |  |
| E.1. Land uses on and surrounding the project site  |                                   |                              |                |  |
| a. Existing land uses.  |                                   |                              |                |  |
| i. Check all uses that occur on, adjoining and near the project site.   |                                   |                              |                |  |
| □ Urban □ Industrial □ Commercial □ Residential (suburban) □ Rural (non-farm)   |                                   |                              |                |  |
| □ Forest □ Agriculture □ Aquatic □ Other (specify):   |                                   |                              |                |  |
| ii. If mix of uses, generally describe:   |                                   |                              |                |  |
| <del></del>   |                                   |                              |                |  |
|   |                                   |                              |                |  |
| b. Land uses and covertypes on the project site.  |                                   |                              |                |  |
| Land use or   | Current                           | Acreage After                | Change         |  |
| Covertype   | Acreage                           | Project Completion           | (Acres +/-)    |  |
| Roads, buildings, and other paved or impervious   | ricreage                          | Troject Completion           | (Pieres 17)    |  |
| surfaces  |                                   |                              |                |  |
| • Forested  |                                   |                              |                |  |
|   |                                   |                              |                |  |
| Meadows, grasslands or brushlands (non-  minute of the order of t |                                   |                              |                |  |
| agricultural, including abandoned agricultural)   |                                   |                              |                |  |
| Agricultural  |                                   |                              |                |  |
| (includes active orchards, field, greenhouse etc.)  |                                   |                              |                |  |
| Surface water features  |                                   |                              |                |  |
| (lakes, ponds, streams, rivers, etc.)   |                                   |                              |                |  |
| • Wetlands (freshwater or tidal)  |                                   |                              |                |  |
| Non-vegetated (bare rock, earth or fill)  |                                   |                              |                |  |
|   |                                   |                              |                |  |
| • Other   |                                   |                              |                |  |
| Describe:   |                                   |                              |                |  |
| <del></del> -   |                                   |                              |                |  |

| c. Is the project site presently used by members of the community for public recreation?   |  |
|--|--|
| i. If Yes: explain:  | □ Yes □ No                             |
| d. Are there any facilities serving children, the elderly, people with disabilities (e.g., schools, hospitals, licensed day care centers, or group homes) within 1500 feet of the project site?  If Yes,  i. Identify Facilities:  | □ Yes □ No                             |
|  |  |
| e. Does the project site contain an existing dam?  | □ Yes □ No                             |
| If Yes:  | □ Tes □ No                             |
| i. Dimensions of the dam and impoundment:  |  |
| • Dam height: feet   |  |
| • Dam length: feet   |  |
| • Surface area: acres  |  |
| • Volume impounded: gallons OR acre-feet<br>ii. Dam's existing hazard classification:  |  |
| iii. Provide date and summarize results of last inspection:  |  |
|  |  |
|  |  |
| f. Has the project site ever been used as a municipal, commercial or industrial solid waste management facility, or does the project site adjoin property which is now, or was at one time, used as a solid waste management facility Yes:   | □ Yes □ No<br>lity?                    |
| i. Has the facility been formally closed?  | □ Yes □ No                             |
| If yes, cite sources/documentation:  |  |
| <i>ii.</i> Describe the location of the project site relative to the boundaries of the solid waste management facility:  |  |
|  |  |
|  |  |
| iii. Describe any development constraints due to the prior solid waste activities:   |  |
| g. Have hazardous wastes been generated, treated and/or disposed of at the site, or does the project site adjoin property which is now or was at one time used to commercially treat, store and/or dispose of hazardous waste? If Yes:   | □ Yes □ No                             |
| g. Have hazardous wastes been generated, treated and/or disposed of at the site, or does the project site adjoin property which is now or was at one time used to commercially treat, store and/or dispose of hazardous waste?   | □ Yes □ No                             |
| g. Have hazardous wastes been generated, treated and/or disposed of at the site, or does the project site adjoin property which is now or was at one time used to commercially treat, store and/or dispose of hazardous waste? If Yes:  i. Describe waste(s) handled and waste management activities, including approximate time when activities occurr  | □ Yes □ No                             |
| g. Have hazardous wastes been generated, treated and/or disposed of at the site, or does the project site adjoin property which is now or was at one time used to commercially treat, store and/or dispose of hazardous waste? If Yes:  i. Describe waste(s) handled and waste management activities, including approximate time when activities occurr h. Potential contamination history. Has there been a reported spill at the proposed project site, or have any remedial actions been conducted at or adjacent to the proposed site?   | □ Yes □ No                             |
| g. Have hazardous wastes been generated, treated and/or disposed of at the site, or does the project site adjoin property which is now or was at one time used to commercially treat, store and/or dispose of hazardous waste? If Yes:  i. Describe waste(s) handled and waste management activities, including approximate time when activities occurr h. Potential contamination history. Has there been a reported spill at the proposed project site, or have any remedial actions been conducted at or adjacent to the proposed site?  If Yes:  i. Is any portion of the site listed on the NYSDEC Spills Incidents database or Environmental Site  | □ Yes □ No                             |
| g. Have hazardous wastes been generated, treated and/or disposed of at the site, or does the project site adjoin property which is now or was at one time used to commercially treat, store and/or dispose of hazardous waste? If Yes:  i. Describe waste(s) handled and waste management activities, including approximate time when activities occurr the proposed project site, or have any remedial actions been conducted at or adjacent to the proposed site? If Yes:  i. Is any portion of the site listed on the NYSDEC Spills Incidents database or Environmental Site Remediation database? Check all that apply:  | □ Yes □ No  red: □ Yes □ No □ Yes □ No |
| g. Have hazardous wastes been generated, treated and/or disposed of at the site, or does the project site adjoin property which is now or was at one time used to commercially treat, store and/or dispose of hazardous waste? If Yes:  i. Describe waste(s) handled and waste management activities, including approximate time when activities occurr h. Potential contamination history. Has there been a reported spill at the proposed project site, or have any remedial actions been conducted at or adjacent to the proposed site?  If Yes:  i. Is any portion of the site listed on the NYSDEC Spills Incidents database or Environmental Site  | □ Yes □ No  red: □ Yes □ No □ Yes □ No |
| g. Have hazardous wastes been generated, treated and/or disposed of at the site, or does the project site adjoin property which is now or was at one time used to commercially treat, store and/or dispose of hazardous waste? If Yes:  i. Describe waste(s) handled and waste management activities, including approximate time when activities occurr remedial actions been conducted at or adjacent to the proposed site?  If Yes:  i. Is any portion of the site listed on the NYSDEC Spills Incidents database or Environmental Site Remediation database? Check all that apply:    Yes - Spills Incidents database   | □ Yes □ No  red: □ Yes □ No □ Yes □ No |
| g. Have hazardous wastes been generated, treated and/or disposed of at the site, or does the project site adjoin property which is now or was at one time used to commercially treat, store and/or dispose of hazardous waste? If Yes:  i. Describe waste(s) handled and waste management activities, including approximate time when activities occurr h. Potential contamination history. Has there been a reported spill at the proposed project site, or have any remedial actions been conducted at or adjacent to the proposed site?  If Yes:  i. Is any portion of the site listed on the NYSDEC Spills Incidents database or Environmental Site Remediation database? Check all that apply:  Yes - Spills Incidents database  Provide DEC ID number(s):  Neither database  ii. If site has been subject of RCRA corrective activities, describe control measures:  iii. Is the project within 2000 feet of any site in the NYSDEC Environmental Site Remediation database? | □ Yes □ No  red: □ Yes □ No □ Yes □ No |
| g. Have hazardous wastes been generated, treated and/or disposed of at the site, or does the project site adjoin property which is now or was at one time used to commercially treat, store and/or dispose of hazardous waste? If Yes:  i. Describe waste(s) handled and waste management activities, including approximate time when activities occurr he proposed waste(s) handled and waste management activities, including approximate time when activities occurr he proposed site? If Yes:  i. Is any portion of the site listed on the NYSDEC Spills Incidents database or Environmental Site Remediation database? Check all that apply:    Yes - Spills Incidents database   | □ Yes □ No  red: □ Yes □ No □ Yes □ No |

| v. Is the project site subject to an institutional control limiting property uses?  | □ Yes □ No                 |
|---|----------------------------|
| <ul> <li>If yes, DEC site ID number:</li> <li>Describe the type of institutional control (e.g., deed restriction or easement):</li> </ul>     |                            |
| <ul> <li>Describe the type of institutional control (e.g., deed restriction or easement):</li> <li>Describe any use limitations:</li> </ul>   |                            |
| Describe any engineering controls:  |                            |
| <ul> <li>Will the project affect the institutional or engineering controls in place?</li> </ul>   | □ Yes □ No                 |
| Explain:  |                            |
|   |                            |
|   |                            |
| E.2. Natural Resources On or Near Project Site  |                            |
| a. What is the average depth to bedrock on the project site? feet   |                            |
| b. Are there bedrock outcroppings on the project site?  | □ Yes □ No                 |
| If Yes, what proportion of the site is comprised of bedrock outcroppings?%  |                            |
| c. Predominant soil type(s) present on project site:  | %                          |
|   | %<br>%                     |
|   | %                          |
| d. What is the average depth to the water table on the project site? Average: feet  |                            |
| e. Drainage status of project site soils:   Well Drained:   % of site   |                            |
| □ Moderately Well Drained:% of site   |                            |
| □ Poorly Drained% of site   |                            |
| f. Approximate proportion of proposed action site with slopes:   0-10%:  % of site  |                            |
| □ 10-15%:% of site □ 15% or greater:% of site   |                            |
|   | D.V. D.N.                  |
| g. Are there any unique geologic features on the project site?  If Yes, describe:   | □ Yes □ No                 |
| 1 200, 400011001  |                            |
| h. Surface water features.  |                            |
| i. Does any portion of the project site contain wetlands or other waterbodies (including streams, rivers,                                     | □ Yes □ No                 |
| ponds or lakes)?  |                            |
| ii. Do any wetlands or other waterbodies adjoin the project site?   | $\square$ Yes $\square$ No |
| If Yes to either <i>i</i> or <i>ii</i> , continue. If No, skip to E.2.i.  |                            |
| iii. Are any of the wetlands or waterbodies within or adjoining the project site regulated by any federal,                                    | □ Yes □ No                 |
| state or local agency?  iv. For each identified regulated wetland and waterbody on the project site, provide the following information        | on.                        |
| • Streams: Name Classification  |                            |
| <ul> <li>Lakes or Ponds: Name</li> <li>Classification</li> </ul>  |                            |
| Wetlands: Name Approximate Size     Wetland No. (if regulated by DEC)   | e                          |
| • Wetland No. (if regulated by DEC)  v. Are any of the above water bodies listed in the most recent compilation of NYS water quality-impaired | □ Yes □ No                 |
| waterbodies?  | - 1 <b>c</b> s - 110       |
| If yes, name of impaired water body/bodies and basis for listing as impaired:   |                            |
|   |                            |
| i. Is the project site in a designated Floodway?  | □ Yes □ No                 |
| j. Is the project site in the 100-year Floodplain?  | □ Yes □ No                 |
| k. Is the project site in the 500-year Floodplain?  | □ Yes □ No                 |
| 1. Is the project site located over, or immediately adjoining, a primary, principal or sole source aquifer?                                   | □ Yes □ No                 |
| If Yes:  i. Name of aquifer:  |                            |
| 6. I raine of aquiter.  |                            |

| m. Identify the predominant wildlife species that occupy  | or use the project site:                          |            |
|---|---|------------|
|   |   |            |
| n. Does the project site contain a designated significant na If Yes:  i. Describe the habitat/community (composition, function)   | atural community? on, and basis for designation): | □ Yes □ No |
| , ,   | acres acres acres                                 | □ Yes □ No |
| o. Does project site contain any species of plant or animal that is listed by the federal government or NYS as □ Yes □ No endangered or threatened, or does it contain any areas identified as habitat for an endangered or threatened species?  If Yes:  i. Species and listing (endangered or threatened):                          |   |            |
| <ul> <li>p. Does the project site contain any species of plant or an special concern?</li> <li>If Yes: <ul> <li>i. Species and listing:</li> </ul> </li> </ul>  | •   | □ Yes □ No |
| q. Is the project site or adjoining area currently used for h If yes, give a brief description of how the proposed action   |   | □ Yes □ No |
| E.3. Designated Public Resources On or Near Project   | Site  |            |
| a. Is the project site, or any portion of it, located in a design Agriculture and Markets Law, Article 25-AA, Section If Yes, provide county plus district name/number:   | 303 and 304?                                      | □ Yes □ No |
| b. Are agricultural lands consisting of highly productive s  i. If Yes: acreage(s) on project site?  ii. Source(s) of soil rating(s):   | •   | □ Yes □ No |
| c. Does the project site contain all or part of, or is it substantially contiguous to, a registered National  Natural Landmark?  If Yes:  i. Nature of the natural landmark: □ Biological Community □ Geological Feature  ii. Provide brief description of landmark, including values behind designation and approximate size/extent: |   |            |
| d. Is the project site located in or does it adjoin a state list If Yes:  i. CEA name:  ii. Basis for designation:  |   | □ Yes □ No |
| iii. Designating agency and date:   |   |            |

| e. Does the project site contain, or is it substantially contiguous to, a but which is listed on the National or State Register of Historic Places, of Office of Parks, Recreation and Historic Preservation to be eligible for If Yes: | r that has been determined by the Commission |                 |
|---|--|-----------------|
| i. Nature of historic/archaeological resource: □ Archaeological Site  | ☐ Historic Building or District              |                 |
| ii. Name:   |  |                 |
| f. Is the project site, or any portion of it, located in or adjacent to an archaeological sites on the NY State Historic Preservation Office (SF  |  | □ Yes □ No      |
| <ul> <li>g. Have additional archaeological or historic site(s) or resources been in If Yes:</li> <li>i. Describe possible resource(s):</li> <li>ii. Basis for identification:</li> </ul>  |  | □ Yes □ No      |
| tt. Dasis for identification.   |  |                 |
| h. Is the project site within fives miles of any officially designated and scenic or aesthetic resource?  If Yes:   | publicly accessible federal, state, or local | □ Yes □ No      |
| i. Identify resource:   |  |                 |
| <ul><li>i. Identify resource:</li><li>ii. Nature of, or basis for, designation (e.g., established highway overletc.):</li></ul>   |  | scenic byway,   |
| iii. Distance between project and resource:n  | niles.                                       |                 |
| <ul> <li>i. Is the project site located within a designated river corridor under the Program 6 NYCRR 666?</li> <li>If Yes:</li> </ul>   |  | □ Yes □ No      |
| <i>i.</i> Identify the name of the river and its designation:   |  |                 |
| <i>ii.</i> Is the activity consistent with development restrictions contained in  | 6NYCRR Part 666?                             | □ Yes □ No      |
| <b>F. Additional Information</b> Attach any additional information which may be needed to clarify you   | ur project.                                  |                 |
| If you have identified any adverse impacts which could be associated measures which you propose to avoid or minimize them.  | with your proposal, please describe those im | npacts plus any |
| <b>G. Verification</b> I certify that the information provided is true to the best of my knowled  | edge.  |                 |
| Applicant/Sponsor Name  | Date   | <del></del>     |
| Signature   | Title  |                 |
|   |  |                 |



**Disclaimer:** The EAF Mapper is a screening tool intended to assist project sponsors and reviewing agencies in preparing an environmental assessment form (EAF). Not all questions asked in the EAF are answered by the EAF Mapper. Additional information on any EAF question can be obtained by consulting the EAF Workbooks. Although the EAF Mapper provides the most up-to-date digital data available to DEC, you may also need to contact local or other data sources to confirm data provided by the Mapper or to obtain data not provided by the Mapper.



| B.i.i [Coastal or Waterfront Area]   | No   |
|--|--|
| B.i.ii [Local Waterfront Revitalization Area]                                      | No   |
| C.2.b. [Special Planning District]   | Yes - Digital mapping data are not available for all Special Planning Districts. Refer to EAF Workbook.  |
| C.2.b. [Special Planning District - Name]  | NYS Heritage Areas:West Erie Canal Corridor  |
| E.1.h [DEC Spills or Remediation Site - Potential Contamination History]           | Digital mapping data are not available or are incomplete. Refer to EAF Workbook.   |
| E.1.h.i [DEC Spills or Remediation Site - Listed]                                  | Digital mapping data are not available or are incomplete. Refer to EAF Workbook.   |
| E.1.h.i [DEC Spills or Remediation Site - Environmental Site Remediation Database] | Digital mapping data are not available or are incomplete. Refer to EAF Workbook.   |
| E.1.h.iii [Within 2,000' of DEC Remediation Site]                                  | No   |
| E.2.g [Unique Geologic Features]   | No   |
| E.2.h.i [Surface Water Features]   | Yes - Digital mapping information on local, New York State, and federal wetlands and waterbodies is known to be incomplete. Refer to the EAF Workbook. |
| E.2.h.ii [Surface Water Features]  | Yes - Digital mapping information on local, New York State, and federal wetlands and waterbodies is known to be incomplete. Refer to the EAF Workbook. |
| E.2.h.iii [Surface Water Features]   | Yes - Digital mapping information on local, New York State, and federal wetlands and waterbodies is known to be incomplete. Refer to the EAF Workbook. |
| E.2.h.iv [Surface Water Features - Wetlands Name]                                  | Federal Waters   |
| E.2.h.v [Impaired Water Bodies]  | Yes  |
| E.2.h.v [Impaired Water Bodies - Name and Basis for Listing]                       | Name - Pollutants - Uses:Beeman Creek and tribs - Fecal Coliforms;Total Phosphorus;Dissolved Oxygen  |
|  |  |

| E.2.i. [Floodway]  | No   |
|--|--|
| E.2.j. [100 Year Floodplain]   | No   |
| E.2.k. [500 Year Floodplain]   | No   |
| E.2.I. [Aquifers]  | No   |
| E.2.n. [Natural Communities]   | No   |
| E.2.o. [Endangered or Threatened Species]                                      | Yes  |
| E.2.o. [Endangered or Threatened Species - Name]                               | Henslow's Sparrow, Short-eared Owl   |
| E.2.p. [Rare Plants or Animals]  | No   |
| E.3.a. [Agricultural District]   | Yes  |
| E.3.a. [Agricultural District]   | ERIEc01  |
| E.3.c. [National Natural Landmark]   | No   |
| E.3.d [Critical Environmental Area]  | No   |
| E.3.e. [National or State Register of Historic Places or State Eligible Sites] | Digital mapping data are not available or are incomplete. Refer to EAF Workbook. |
| E.3.f. [Archeological Sites]   | No   |
| E.3.i. [Designated River Corridor]   | No   |

#### Full Environmental Assessment Form Part 2 - Identification of Potential Project Impacts

Project : Date :

**Part 2** is to be completed by the lead agency. Part 2 is designed to help the lead agency inventory all potential resources that could be affected by a proposed project or action. We recognize that the lead agency's reviewer(s) will not necessarily be environmental professionals. So, the questions are designed to walk a reviewer through the assessment process by providing a series of questions that can be answered using the information found in Part 1. To further assist the lead agency in completing Part 2, the form identifies the most relevant questions in Part 1 that will provide the information needed to answer the Part 2 question. When Part 2 is completed, the lead agency will have identified the relevant environmental areas that may be impacted by the proposed activity.

If the lead agency is a state agency **and** the action is in any Coastal Area, complete the Coastal Assessment Form before proceeding with this assessment.

#### **Tips for completing Part 2:**

- Review all of the information provided in Part 1.
- Review any application, maps, supporting materials and the Full EAF Workbook.
- Answer each of the 18 questions in Part 2.
- If you answer "Yes" to a numbered question, please complete all the questions that follow in that section.
- If you answer "No" to a numbered question, move on to the next numbered question.
- Check appropriate column to indicate the anticipated size of the impact.
- Proposed projects that would exceed a numeric threshold contained in a question should result in the reviewing agency checking the box "Moderate to large impact may occur."
- The reviewer is not expected to be an expert in environmental analysis.
- If you are not sure or undecided about the size of an impact, it may help to review the sub-questions for the general question and consult the workbook.
- When answering a question consider all components of the proposed activity, that is, the "whole action".
- Consider the possibility for long-term and cumulative impacts as well as direct impacts.
- Answer the question in a reasonable manner considering the scale and context of the project.

| Proposed action may involve construction on, or physical alteration of, the land surface of the proposed site. (See Part 1. D.1)  If "Yes", answer questions a - j. If "No", move on to Section 2. | □NC                               |  | YES   |
|--|-----------------------------------|--|---|
|  | Relevant<br>Part I<br>Question(s) | No, or<br>small<br>impact<br>may occur | Moderate<br>to large<br>impact may<br>occur |
| a. The proposed action may involve construction on land where depth to water table is less than 3 feet.  | E2d                               |  |   |
| b. The proposed action may involve construction on slopes of 15% or greater.   | E2f                               |  |   |
| c. The proposed action may involve construction on land where bedrock is exposed, or generally within 5 feet of existing ground surface.   | E2a                               |  |   |
| d. The proposed action may involve the excavation and removal of more than 1,000 tons of natural material.   | D2a                               |  |   |
| e. The proposed action may involve construction that continues for more than one year or in multiple phases.   | D1e                               |  |   |
| f. The proposed action may result in increased erosion, whether from physical disturbance or vegetation removal (including from treatment by herbicides).  | D2e, D2q                          |  |   |
| g. The proposed action is, or may be, located within a Coastal Erosion hazard area.  | Bli                               |  |   |
| h. Other impacts:  |                                   |  |   |

| 2. Impact on Geological Features   |                                   |  |   |
|--|-----------------------------------|--|---|
| The proposed action may result in the modification or destruction of, or inhib access to, any unique or unusual land forms on the site (e.g., cliffs, dunes, minerals, fossils, caves). (See Part 1. E.2.g)  | ıt<br>□ NO                        |  | YES   |
| If "Yes", answer questions a - c. If "No", move on to Section 3.   | Relevant<br>Part I<br>Question(s) | No, or<br>small<br>impact<br>may occur | Moderate<br>to large<br>impact may<br>occur |
| a. Identify the specific land form(s) attached:  | E2g                               |  |   |
| b. The proposed action may affect or is adjacent to a geological feature listed as a registered National Natural Landmark.  Specific feature:  | E3c                               |  |   |
| c. Other impacts:  |                                   |  |   |
|  |                                   |  |   |
| 3. Impacts on Surface Water  The proposed action may affect one or more wetlands or other surface water bodies (e.g., streams, rivers, ponds or lakes). (See Part 1. D.2, E.2.h)  If "Yes", answer questions a - l. If "No", move on to Section 4. | □ NO                              |  | YES   |
|  | Relevant<br>Part I<br>Question(s) | No, or<br>small<br>impact<br>may occur | Moderate<br>to large<br>impact may<br>occur |
| a. The proposed action may create a new water body.  | D2b, D1h                          |  |   |
| b. The proposed action may result in an increase or decrease of over 10% or more than a 10 acre increase or decrease in the surface area of any body of water.   | D2b                               |  |   |
| c. The proposed action may involve dredging more than 100 cubic yards of material from a wetland or water body.  | D2a                               |  |   |
| d. The proposed action may involve construction within or adjoining a freshwater or tidal wetland, or in the bed or banks of any other water body.   | E2h                               |  |   |
| e. The proposed action may create turbidity in a waterbody, either from upland erosion, runoff or by disturbing bottom sediments.  | D2a, D2h                          |  |   |
| f. The proposed action may include construction of one or more intake(s) for withdrawal of water from surface water.   | D2c                               |  |   |
| g. The proposed action may include construction of one or more outfall(s) for discharge of wastewater to surface water(s).   | D2d                               |  |   |
| h. The proposed action may cause soil erosion, or otherwise create a source of stormwater discharge that may lead to siltation or other degradation of receiving water bodies.   | D2e                               |  |   |
| i. The proposed action may affect the water quality of any water bodies within or downstream of the site of the proposed action.   | E2h                               |  |   |
| j. The proposed action may involve the application of pesticides or herbicides in or around any water body.  | D2q, E2h                          |  |   |
| k. The proposed action may require the construction of new, or expansion of existing,  | D1a, D2d                          |  |   |

wastewater treatment facilities.

| 1. Other impacts:  |                                   |  |   |
|--|-----------------------------------|--|---|
| <b>4. Impact on groundwater</b> The proposed action may result in new or additional use of ground water, or may have the potential to introduce contaminants to ground water or an aquife (See Part 1. D.2.a, D.2.c, D.2.d, D.2.p, D.2.q, D.2.t)  If "Yes", answer questions a - h. If "No", move on to Section 5. | □ NC                              | ) [                                    | YES   |
| ij Tes , unswer questions a n. ij 110 , move on to section 3.  | Relevant<br>Part I<br>Question(s) | No, or<br>small<br>impact<br>may occur | Moderate<br>to large<br>impact may<br>occur |
| a. The proposed action may require new water supply wells, or create additional demand on supplies from existing water supply wells.   | D2c                               |  |   |
| b. Water supply demand from the proposed action may exceed safe and sustainable withdrawal capacity rate of the local supply or aquifer.  Cite Source:   | D2c                               |  |   |
| c. The proposed action may allow or result in residential uses in areas without water and sewer services.  | D1a, D2c                          |  |   |
| d. The proposed action may include or require wastewater discharged to groundwater.  | D2d, E2l                          |  |   |
| e. The proposed action may result in the construction of water supply wells in locations where groundwater is, or is suspected to be, contaminated.  | D2c, E1f,<br>E1g, E1h             |  |   |
| f. The proposed action may require the bulk storage of petroleum or chemical products over ground water or an aquifer.   | D2p, E2l                          |  |   |
| g. The proposed action may involve the commercial application of pesticides within 100 feet of potable drinking water or irrigation sources.   | E2h, D2q,<br>E2l, D2c             |  |   |
| h. Other impacts:  |                                   |  |   |
| 5. Impact on Flooding  The proposed action may result in development on lands subject to flooding.  (See Part 1. E.2)  If "Yes", answer questions a - g. If "No", move on to Section 6.  | □NC                               | ) [                                    | YES   |
|  | Relevant<br>Part I<br>Question(s) | No, or<br>small<br>impact<br>may occur | Moderate<br>to large<br>impact may<br>occur |
| a. The proposed action may result in development in a designated floodway.   | E2i                               |  |   |
| b. The proposed action may result in development within a 100 year floodplain.   | E2j                               |  |   |
| c. The proposed action may result in development within a 500 year floodplain.   | E2k                               |  |   |
| d. The proposed action may result in, or require, modification of existing drainage patterns.  | D2b, D2e                          |  |   |
| e. The proposed action may change flood water flows that contribute to flooding.   | D2b, E2i,<br>E2j, E2k             |  |   |
| f. If there is a dam located on the site of the proposed action, is the dam in need of repair, or upgrade?   | Ele                               |  |   |

| g. Other impacts:   |  |  |   |
|---|--|--|---|
| 6. Impacts on Air  The proposed action may include a state regulated air emission source.  (See Part 1. D.2.f., D.2.h, D.2.g)  If "Yes", answer questions a - f. If "No", move on to Section 7.   | □NO                                    |  | YES   |
|   | Relevant<br>Part I<br>Question(s)      | No, or<br>small<br>impact<br>may occur | Moderate<br>to large<br>impact may<br>occur |
| <ul> <li>a. If the proposed action requires federal or state air emission permits, the action may also emit one or more greenhouse gases at or above the following levels: <ol> <li>i. More than 1000 tons/year of carbon dioxide (CO<sub>2</sub>)</li> <li>ii. More than 3.5 tons/year of nitrous oxide (N<sub>2</sub>O)</li> <li>iii. More than 1000 tons/year of carbon equivalent of perfluorocarbons (PFCs)</li> <li>iv. More than .045 tons/year of sulfur hexafluoride (SF<sub>6</sub>)</li> <li>v. More than 1000 tons/year of carbon dioxide equivalent of hydrochloroflourocarbons (HFCs) emissions</li> <li>vi. 43 tons/year or more of methane</li> </ol> </li> </ul> | D2g<br>D2g<br>D2g<br>D2g<br>D2g<br>D2g |  |   |
| b. The proposed action may generate 10 tons/year or more of any one designated hazardous air pollutant, or 25 tons/year or more of any combination of such hazardous air pollutants.  | D2g                                    |  |   |
| c. The proposed action may require a state air registration, or may produce an emissions rate of total contaminants that may exceed 5 lbs. per hour, or may include a heat source capable of producing more than 10 million BTU's per hour.   | D2f, D2g                               |  |   |
| d. The proposed action may reach 50% of any of the thresholds in "a" through "c", above.  | D2g                                    |  |   |
| e. The proposed action may result in the combustion or thermal treatment of more than 1 ton of refuse per hour.   | D2s                                    |  |   |
| f. Other impacts:   |  |  |   |
| 7. Impact on Plants and Animals  The proposed action may result in a loss of flora or fauna. (See Part 1. E.2. If "Yes", answer questions a - j. If "No", move on to Section 8.   | mq.)                                   | □NO                                    | □ YES                                       |
|   | Relevant<br>Part I<br>Question(s)      | No, or<br>small<br>impact<br>may occur | Moderate<br>to large<br>impact may<br>occur |
| a. The proposed action may cause reduction in population or loss of individuals of any threatened or endangered species, as listed by New York State or the Federal government, that use the site, or are found on, over, or near the site.   | E2o                                    |  |   |
| b. The proposed action may result in a reduction or degradation of any habitat used by any rare, threatened or endangered species, as listed by New York State or the federal government.   | E2o                                    |  |   |
| c. The proposed action may cause reduction in population, or loss of individuals, of any species of special concern or conservation need, as listed by New York State or the Federal government, that use the site, or are found on, over, or near the site.  | E2p                                    |  |   |
| d. The proposed action may result in a reduction or degradation of any habitat used by any species of special concern and conservation need, as listed by New York State or the Federal government.   | E2p                                    |  |   |

| e. The proposed action may diminish the capacity of a registered National Natural Landmark to support the biological community it was established to protect.   | E3c  |  |   |
|---|--|--|---|
| f. The proposed action may result in the removal of, or ground disturbance in, any portion of a designated significant natural community.  Source:  | E2n  |  |   |
| g. The proposed action may substantially interfere with nesting/breeding, foraging, or over-wintering habitat for the predominant species that occupy or use the project site.  | E2m  |  |   |
| h. The proposed action requires the conversion of more than 10 acres of forest, grassland or any other regionally or locally important habitat.  Habitat type & information source:   | E1b  |  |   |
| i. Proposed action (commercial, industrial or recreational projects, only) involves use of herbicides or pesticides.  | D2q  |  |   |
| j. Other impacts:   |  |  |   |
|   |  |  |   |
| 8. Impact on Agricultural Resources The proposed action may impact agricultural resources. (See Part 1. E.3.a. ar   | nd b.)   | □ NO                                   | □ YES                                       |
| If "Yes", answer questions a - h. If "No", move on to Section 9.  |  |  |   |
| If "Yes", answer questions a - h. If "No", move on to Section 9.  | Relevant<br>Part I<br>Question(s)  | No, or<br>small<br>impact<br>may occur | Moderate<br>to large<br>impact may<br>occur |
| a. The proposed action may impact soil classified within soil group 1 through 4 of the NYS Land Classification System.  | Part I   | small<br>impact                        | to large<br>impact may                      |
| a. The proposed action may impact soil classified within soil group 1 through 4 of the  | Part I<br>Question(s)  | small<br>impact<br>may occur           | to large<br>impact may<br>occur             |
| <ul> <li>a. The proposed action may impact soil classified within soil group 1 through 4 of the NYS Land Classification System.</li> <li>b. The proposed action may sever, cross or otherwise limit access to agricultural land</li> </ul>  | Part I<br>Question(s)<br>E2c, E3b  | small<br>impact<br>may occur           | to large<br>impact may<br>occur             |
| <ul> <li>a. The proposed action may impact soil classified within soil group 1 through 4 of the NYS Land Classification System.</li> <li>b. The proposed action may sever, cross or otherwise limit access to agricultural land (includes cropland, hayfields, pasture, vineyard, orchard, etc).</li> <li>c. The proposed action may result in the excavation or compaction of the soil profile of</li> </ul>   | Part I<br>Question(s)<br>E2c, E3b<br>E1a, Elb                              | small impact may occur                 | to large impact may occur                   |
| <ul> <li>a. The proposed action may impact soil classified within soil group 1 through 4 of the NYS Land Classification System.</li> <li>b. The proposed action may sever, cross or otherwise limit access to agricultural land (includes cropland, hayfields, pasture, vineyard, orchard, etc).</li> <li>c. The proposed action may result in the excavation or compaction of the soil profile of active agricultural land.</li> <li>d. The proposed action may irreversibly convert agricultural land to non-agricultural uses, either more than 2.5 acres if located in an Agricultural District, or more than 10</li> </ul>   | Part I<br>Question(s)<br>E2c, E3b<br>E1a, Elb                              | small impact may occur                 | to large impact may occur                   |
| <ul> <li>a. The proposed action may impact soil classified within soil group 1 through 4 of the NYS Land Classification System.</li> <li>b. The proposed action may sever, cross or otherwise limit access to agricultural land (includes cropland, hayfields, pasture, vineyard, orchard, etc).</li> <li>c. The proposed action may result in the excavation or compaction of the soil profile of active agricultural land.</li> <li>d. The proposed action may irreversibly convert agricultural land to non-agricultural uses, either more than 2.5 acres if located in an Agricultural District, or more than 10 acres if not within an Agricultural District.</li> <li>e. The proposed action may disrupt or prevent installation of an agricultural land</li> </ul>   | Part I Question(s)  E2c, E3b  E1a, Elb  E3b  E1b, E3a                      | small impact may occur                 | to large impact may occur                   |
| <ul> <li>a. The proposed action may impact soil classified within soil group 1 through 4 of the NYS Land Classification System.</li> <li>b. The proposed action may sever, cross or otherwise limit access to agricultural land (includes cropland, hayfields, pasture, vineyard, orchard, etc).</li> <li>c. The proposed action may result in the excavation or compaction of the soil profile of active agricultural land.</li> <li>d. The proposed action may irreversibly convert agricultural land to non-agricultural uses, either more than 2.5 acres if located in an Agricultural District, or more than 10 acres if not within an Agricultural District.</li> <li>e. The proposed action may disrupt or prevent installation of an agricultural land management system.</li> <li>f. The proposed action may result, directly or indirectly, in increased development</li> </ul> | Part I Question(s)  E2c, E3b  E1a, Elb  E3b  E1b, E3a  El a, E1b  C2c, C3, | small impact may occur                 | to large impact may occur                   |

| 9. Impact on Aesthetic Resources  The land use of the proposed action are obviously different from, or are in sharp contrast to, current land use patterns between the proposed project and a scenic or aesthetic resource. (Part 1. E.1.a, E.1.b, E.3.h.)  If "Yes", answer questions a - g. If "No", go to Section 10.  | oposed action are obviously different from, or are in ent land use patterns between the proposed project and esource. (Part 1. E.1.a, E.1.b, E.3.h.) stions a - g. If "No", go to Section 10. |  | YES   |
|---|---|--|---|
|   | Relevant<br>Part I<br>Question(s)   | No, or<br>small<br>impact<br>may occur | Moderate<br>to large<br>impact may<br>occur |
| a. Proposed action may be visible from any officially designated federal, state, or local scenic or aesthetic resource.   | E3h   |  |   |
| b. The proposed action may result in the obstruction, elimination or significant screening of one or more officially designated scenic views.   | E3h, C2b  |  |   |
| c. The proposed action may be visible from publicly accessible vantage points: i. Seasonally (e.g., screened by summer foliage, but visible during other seasons) ii. Year round  | E3h   |  |   |
| <ul><li>d. The situation or activity in which viewers are engaged while viewing the proposed action is:</li><li>i. Routine travel by residents, including travel to and from work</li><li>ii. Recreational or tourism based activities</li></ul>  | E3h<br>E2q,<br>E1c  | _<br>_                                 | _<br>_                                      |
| e. The proposed action may cause a diminishment of the public enjoyment and appreciation of the designated aesthetic resource.  | E3h   |  |   |
| f. There are similar projects visible within the following distance of the proposed project:  0-1/2 mile  ½ -3 mile  3-5 mile  5+ mile  | D1a, E1a,<br>D1f, D1g   |  |   |
| g. Other impacts:   |   |  |   |
| 10. Impact on Historic and Archeological Resources  The proposed action may occur in or adjacent to a historic or archaeological resource. (Part 1. E.3.e, f. and g.)  If "Yes", answer questions a - e. If "No", go to Section 11.   |   | ) 🗆                                    | YES   |
|   | Relevant<br>Part I<br>Question(s)   | No, or<br>small<br>impact<br>may occur | Moderate<br>to large<br>impact may<br>occur |
| a. The proposed action may occur wholly or partially within, or substantially contiguous<br>to, any buildings, archaeological site or district which is listed on the National or<br>State Register of Historical Places, or that has been determined by the Commissioner<br>of the NYS Office of Parks, Recreation and Historic Preservation to be eligible for<br>listing on the State Register of Historic Places. | E3e   |  |   |
| b. The proposed action may occur wholly or partially within, or substantially contiguous to, an area designated as sensitive for archaeological sites on the NY State Historic Preservation Office (SHPO) archaeological site inventory.  | E3f   |  |   |
| c. The proposed action may occur wholly or partially within, or substantially contiguous to, an archaeological site not included on the NY SHPO inventory.  Source:   | E3g   |  |   |

| d. Other impacts:   |   |  |   |
|---|---|--|---|
| If any of the above (a-d) are answered "Moderate to large impact may e. occur", continue with the following questions to help support conclusions in Part 3:  |   |  |   |
| <ol> <li>The proposed action may result in the destruction or alteration of all or part<br/>of the site or property.</li> </ol>   | E3e, E3g,<br>E3f                          |  |   |
| <ol> <li>The proposed action may result in the alteration of the property's setting or<br/>integrity.</li> </ol>  | E3e, E3f,<br>E3g, E1a,<br>E1b             |  |   |
| iii. The proposed action may result in the introduction of visual elements which are out of character with the site or property, or may alter its setting.  | E3e, E3f,<br>E3g, E3h,<br>C2, C3          |  |   |
|   |   |  |   |
| 11. Impact on Open Space and Recreation  The proposed action may result in a loss of recreational opportunities or a reduction of an open space resource as designated in any adopted municipal open space plan.  (See Part 1. C.2.c, E.1.c., E.2.q.)  If "Yes", answer questions a - e. If "No", go to Section 12. | □ N0                                      | O 🗖                                    | YES   |
|   | Relevant<br>Part I<br>Question(s)         | No, or<br>small<br>impact<br>may occur | Moderate<br>to large<br>impact may<br>occur |
| a. The proposed action may result in an impairment of natural functions, or "ecosystem services", provided by an undeveloped area, including but not limited to stormwater storage, nutrient cycling, wildlife habitat.   | D2e, E1b<br>E2h,<br>E2m, E2o,<br>E2n, E2p |  |   |
| b. The proposed action may result in the loss of a current or future recreational resource.   | C2a, E1c,<br>C2c, E2q                     |  |   |
| c. The proposed action may eliminate open space or recreational resource in an area with few such resources.  | C2a, C2c<br>E1c, E2q                      |  |   |
| d. The proposed action may result in loss of an area now used informally by the community as an open space resource.  | C2c, E1c                                  |  |   |
| e. Other impacts:   |   |  |   |
|   |   |  |   |
| <b>12. Impact on Critical Environmental Areas</b> The proposed action may be located within or adjacent to a critical environmental area (CEA). (See Part 1. E.3.d)  If "Yes", answer questions a - c. If "No", go to Section 13.   | □ N0                                      | О 🗆                                    | YES   |
| zy zez y amane. questienz a et zy zie y ge ie zeenen zei  | Relevant<br>Part I<br>Question(s)         | No, or<br>small<br>impact<br>may occur | Moderate<br>to large<br>impact may<br>occur |
| a. The proposed action may result in a reduction in the quantity of the resource or characteristic which was the basis for designation of the CEA.  | E3d                                       |  |   |
| b. The proposed action may result in a reduction in the quality of the resource or characteristic which was the basis for designation of the CEA.   | E3d                                       |  |   |
| c. Other impacts:   |   |  |   |

| 13. Impact on Transportation  The proposed action may result in a change to existing transportation systems (See Part 1. D.2.j)  | s. 🗆 No                           | О 🗆                                    | YES   |
|--|-----------------------------------|--|---|
| If "Yes", answer questions a - f. If "No", go to Section 14.   | Relevant<br>Part I<br>Question(s) | No, or<br>small<br>impact<br>may occur | Moderate<br>to large<br>impact may<br>occur |
| a. Projected traffic increase may exceed capacity of existing road network.  | D2j                               |  |   |
| b. The proposed action may result in the construction of paved parking area for 500 or more vehicles.  | D2j                               |  |   |
| c. The proposed action will degrade existing transit access.   | D2j                               |  |   |
| d. The proposed action will degrade existing pedestrian or bicycle accommodations.   | D2j                               |  |   |
| e. The proposed action may alter the present pattern of movement of people or goods.   | D2j                               |  |   |
| f. Other impacts:  |                                   |  |   |
|  | 1                                 |  | •   |
| 14. Impact on Energy  The proposed action may cause an increase in the use of any form of energy.  (See Part 1. D.2.k)  If "Yes", answer questions a - e. If "No", go to Section 15.                                 | □Nº                               | O 🗆                                    | YES   |
|  | Relevant<br>Part I<br>Question(s) | No, or<br>small<br>impact<br>may occur | Moderate<br>to large<br>impact may<br>occur |
| a. The proposed action will require a new, or an upgrade to an existing, substation.   | D2k                               |  |   |
| b. The proposed action will require the creation or extension of an energy transmission or supply system to serve more than 50 single or two-family residences or to serve a commercial or industrial use.           | D1f,<br>D1q, D2k                  |  |   |
| c. The proposed action may utilize more than 2,500 MWhrs per year of electricity.  | D2k                               |  |   |
| d. The proposed action may involve heating and/or cooling of more than 100,000 square feet of building area when completed.  | D1g                               |  |   |
| e. Other Impacts:  |                                   |  |   |
| [12]   |                                   |  |   |
| 15. Impact on Noise, Odor, and Light  The proposed action may result in an increase in noise, odors, or outdoor ligh  (See Part 1. D.2.m., n., and o.)  If "Yes", answer questions a - f. If "No", go to Section 16. | ting.   NC                        | ) 🗆                                    | YES   |
| J ,  | Relevant<br>Part I<br>Question(s) | No, or<br>small<br>impact<br>may occur | Moderate<br>to large<br>impact may<br>occur |
| a. The proposed action may produce sound above noise levels established by local regulation.   | D2m                               |  |   |
| b. The proposed action may result in blasting within 1,500 feet of any residence, hospital, school, licensed day care center, or nursing home.   | D2m, E1d                          |  |   |

c. The proposed action may result in routine odors for more than one hour per day.

D2o

| d. The proposed action may result in light shining onto adjoining properties.                           | D2n      |  |
|---|----------|--|
| e. The proposed action may result in lighting creating sky-glow brighter than existing area conditions. | D2n, E1a |  |
| f. Other impacts:   |          |  |

#### 16. Impact on Human Health The proposed action may have an impact on human health from exposure $\square$ NO $\square$ YES to new or existing sources of contaminants. (See Part 1.D.2.q., E.1. d. f. g. and h.) If "Yes", answer questions a - m. If "No", go to Section 17. Relevant Moderate No,or Part I small to large **Ouestion(s)** impact impact may may cccur occur a. The proposed action is located within 1500 feet of a school, hospital, licensed day E1d П П care center, group home, nursing home or retirement community. Elg, Elh b. The site of the proposed action is currently undergoing remediation. Elg, Elh П c. There is a completed emergency spill remediation, or a completed environmental site remediation on, or adjacent to, the site of the proposed action. Elg, Elh d. The site of the action is subject to an institutional control limiting the use of the П property (e.g., easement or deed restriction). e. The proposed action may affect institutional control measures that were put in place Elg, Elh П to ensure that the site remains protective of the environment and human health. D2t f. The proposed action has adequate control measures in place to ensure that future generation, treatment and/or disposal of hazardous wastes will be protective of the environment and human health. g. The proposed action involves construction or modification of a solid waste D2q, E1f П management facility. D2q, E1f h. The proposed action may result in the unearthing of solid or hazardous waste. П D2r, D2s i. The proposed action may result in an increase in the rate of disposal, or processing, of solid waste. j. The proposed action may result in excavation or other disturbance within 2000 feet of E1f, E1g a site used for the disposal of solid or hazardous waste. E1h E1f, E1g k. The proposed action may result in the migration of explosive gases from a landfill П П site to adjacent off site structures. D2s, E1f, 1. The proposed action may result in the release of contaminated leachate from the D2r project site. m. Other impacts:

| 17. Consistency with Community Plans  |  |  |   |
|---|--|--|---|
| The proposed action is not consistent with adopted land use plans. (See Part 1. C.1, C.2. and C.3.)   | □ NO   |  | /ES   |
| If "Yes", answer questions a - h. If "No", go to Section 18.  |  |  |   |
|   | Relevant<br>Part I<br>Question(s)  | No, or<br>small<br>impact<br>may occur | Moderate<br>to large<br>impact may<br>occur |
| a. The proposed action's land use components may be different from, or in sharp contrast to, current surrounding land use pattern(s).   | C2, C3, D1a<br>E1a, E1b  |  |   |
| b. The proposed action will cause the permanent population of the city, town or village in which the project is located to grow by more than 5%.  | C2   |  |   |
| c. The proposed action is inconsistent with local land use plans or zoning regulations.   | C2, C2, C3   |  |   |
| d. The proposed action is inconsistent with any County plans, or other regional land use plans.   | C2, C2   |  |   |
| e. The proposed action may cause a change in the density of development that is not supported by existing infrastructure or is distant from existing infrastructure.  C3, D D1d, I D1d, I   |  |  |   |
| f. The proposed action is located in an area characterized by low density development that will require new or expanded public infrastructure.  | C4, D2c, D2d<br>D2j  |  |   |
| g. The proposed action may induce secondary development impacts (e.g., residential or commercial development not included in the proposed action)   | C2a  |  |   |
| h. Other:   |  |  |   |
|   |  |  |   |
|   |  |  |   |
| 18. Consistency with Community Character  The proposed project is inconsistent with the existing community character.  (See Part 1. C.2, C.3, D.2, E.3)   | □ NO   |  | /ES   |
| The proposed project is inconsistent with the existing community character.   |  |  |   |
| The proposed project is inconsistent with the existing community character. (See Part 1. C.2, C.3, D.2, E.3)  | Relevant Part I Question(s)  | No, or small impact may occur          | Moderate to large impact may occur          |
| The proposed project is inconsistent with the existing community character. (See Part 1. C.2, C.3, D.2, E.3)  | Relevant<br>Part I<br>Question(s)  | No, or<br>small<br>impact              | Moderate<br>to large<br>impact may          |
| The proposed project is inconsistent with the existing community character. (See Part 1. C.2, C.3, D.2, E.3)  If "Yes", answer questions a - g. If "No", proceed to Part 3.  a. The proposed action may replace or eliminate existing facilities, structures, or areas  | Relevant<br>Part I<br>Question(s)  | No, or<br>small<br>impact<br>may occur | Moderate<br>to large<br>impact may<br>occur |
| The proposed project is inconsistent with the existing community character. (See Part 1. C.2, C.3, D.2, E.3)  If "Yes", answer questions a - g. If "No", proceed to Part 3.  a. The proposed action may replace or eliminate existing facilities, structures, or areas of historic importance to the community.  b. The proposed action may create a demand for additional community services (e.g.   | Relevant<br>Part I<br>Question(s)  | No, or<br>small<br>impact<br>may occur | Moderate<br>to large<br>impact may<br>occur |
| The proposed project is inconsistent with the existing community character. (See Part 1. C.2, C.3, D.2, E.3)  If "Yes", answer questions a - g. If "No", proceed to Part 3.  a. The proposed action may replace or eliminate existing facilities, structures, or areas of historic importance to the community.  b. The proposed action may create a demand for additional community services (e.g. schools, police and fire)  c. The proposed action may displace affordable or low-income housing in an area where  | Relevant Part I Question(s)  E3e, E3f, E3g  C4  C2, C3, D1f                  | No, or small impact may occur          | Moderate to large impact may occur          |
| The proposed project is inconsistent with the existing community character. (See Part 1. C.2, C.3, D.2, E.3)  If "Yes", answer questions a - g. If "No", proceed to Part 3.  a. The proposed action may replace or eliminate existing facilities, structures, or areas of historic importance to the community.  b. The proposed action may create a demand for additional community services (e.g. schools, police and fire)  c. The proposed action may displace affordable or low-income housing in an area where there is a shortage of such housing.  d. The proposed action may interfere with the use or enjoyment of officially recognized  | Relevant Part I Question(s)  E3e, E3f, E3g  C4  C2, C3, D1f D1g, E1a         | No, or small impact may occur          | Moderate to large impact may occur          |
| The proposed project is inconsistent with the existing community character. (See Part 1. C.2, C.3, D.2, E.3)  If "Yes", answer questions a - g. If "No", proceed to Part 3.  a. The proposed action may replace or eliminate existing facilities, structures, or areas of historic importance to the community.  b. The proposed action may create a demand for additional community services (e.g. schools, police and fire)  c. The proposed action may displace affordable or low-income housing in an area where there is a shortage of such housing.  d. The proposed action may interfere with the use or enjoyment of officially recognized or designated public resources.  e. The proposed action is inconsistent with the predominant architectural scale and | Relevant Part I Question(s)  E3e, E3f, E3g  C4  C2, C3, D1f D1g, E1a  C2, E3 | No, or small impact may occur          | Moderate to large impact may occur          |

Project : Date :

# Full Environmental Assessment Form Part 3 - Evaluation of the Magnitude and Importance of Project Impacts and Determination of Significance

Part 3 provides the reasons in support of the determination of significance. The lead agency must complete Part 3 for every question in Part 2 where the impact has been identified as potentially moderate to large or where there is a need to explain why a particular element of the proposed action will not, or may, result in a significant adverse environmental impact.

Based on the analysis in Part 3, the lead agency must decide whether to require an environmental impact statement to further assess the proposed action or whether available information is sufficient for the lead agency to conclude that the proposed action will not have a significant adverse environmental impact. By completing the certification on the next page, the lead agency can complete its determination of significance.

#### **Reasons Supporting This Determination:**

To complete this section:

- Identify the impact based on the Part 2 responses and describe its magnitude. Magnitude considers factors such as severity, size or extent of an impact.
- Assess the importance of the impact. Importance relates to the geographic scope, duration, probability of the impact
  occurring, number of people affected by the impact and any additional environmental consequences if the impact were to
  occur.
- The assessment should take into consideration any design element or project changes.
- Repeat this process for each Part 2 question where the impact has been identified as potentially moderate to large or where
  there is a need to explain why a particular element of the proposed action will not, or may, result in a significant adverse
  environmental impact.
- Provide the reason(s) why the impact may, or will not, result in a significant adverse environmental impact
- For Conditional Negative Declarations identify the specific condition(s) imposed that will modify the proposed action so that no significant adverse environmental impacts will result.
- Attach additional sheets, as needed.

|                        | Determination of S             | ignificance - [ | Type 1 and Un | listed Actions |           |
|------------------------|--------------------------------|-----------------|---------------|----------------|-----------|
| SEQR Status:           | ☐ Type 1                       | □ Unlisted      |               |                |           |
| Identify portions of E | AF completed for this Project: | □ Part 1        | □ Part 2      | □ Part 3       |           |
|                        |                                |                 |               |                | FEAF 2019 |

| Upon review of the information recorded on this EAF, as noted, plus this additional support information recorded on this EAF, as noted, plus this additional support information recorded on this EAF, as noted, plus this additional support information recorded on this EAF, as noted, plus this additional support information recorded on this EAF, as noted, plus this additional support information recorded on this EAF, as noted, plus this additional support information recorded on this EAF, as noted, plus this additional support information recorded on this EAF, as noted, plus this additional support information recorded on this EAF, as noted, plus this additional support information recorded on this EAF, as noted, plus this additional support information recorded on the plus this additional support information recorded on this EAF, as noted, plus this additional support information recorded on the | mation                                  |
|--|---|
|  |   |
| and considering both the magnitude and importance of each identified potential impact, it is the co  | onclusion of the _ as lead agency that: |
| ☐ A. This project will result in no significant adverse impacts on the environment, and, therefore statement need not be prepared. Accordingly, this negative declaration is issued.   | ore, an environmental impact            |
| ☐ B. Although this project could have a significant adverse impact on the environment, that in substantially mitigated because of the following conditions which will be required by the lead age  |   |
|  |   |
| There will, therefore, be no significant adverse impacts from the project as conditioned, and, there declaration is issued. A conditioned negative declaration may be used only for UNLISTED action  |   |
| ☐ C. This Project may result in one or more significant adverse impacts on the environment, a statement must be prepared to further assess the impact(s) and possible mitigation and to explore a impacts. Accordingly, this positive declaration is issued.   |   |
| Name of Action:  |   |
| Name of Lead Agency:   |   |
| Name of Responsible Officer in Lead Agency:  |   |
| Title of Responsible Officer:  |   |
| Signature of Responsible Officer in Lead Agency:   | Date:                                   |
| Signature of Preparer (if different from Responsible Officer)  | Date:                                   |
| For Further Information:   |   |
| Contact Person:  |   |
| Address:   |   |
| Telephone Number:  |   |
| E-mail:  |   |
| For Type 1 Actions and Conditioned Negative Declarations, a copy of this Notice is sent to:  |   |
| Chief Executive Officer of the political subdivision in which the action will be principally located Other involved agencies (if any) Applicant (if any) Environmental Notice Bulletin: <a href="http://www.dec.ny.gov/enb/enb.html">http://www.dec.ny.gov/enb/enb.html</a>  | (e.g., Town / City / Village of)        |

#### **FEAF Part 3b Reasons Supporting this Determination:**

Project Name: AJ's Tree Service

Project Location: 9865 County Road | SBL: 44.00-3-6

**Date:** 10-15-2025

#### **Executive Summary:**

The "Project Site" is located at 9865 County Road – SBL 44.00-3-6. The Project Site consists of +/- 47.15 acres of land and is split zoned between Industrial Business Park ("I") and Agricultural Rural Residential ("A-RR") pursuant to the Town of Clarence Zoning Map. The "Proposed Project" includes an industrial tree service operation with an 8,876 sq.ft. sales, service, and office building proposed at County Road, which is accompanied by two vehicular access points to County Road, customer parking, and an equipment sales lot. A business inventory storage lot is proposed to the rear of the building with an access drive to the rear of the site. The rear of the site is proposed to contain an outdoor wood processing yard, fenced outdoor rental storage, storage and service buildings, and a future wood production facility.

After a thorough review with involved and interested agencies, it has been determined that the Proposed Project will not have a potentially significant adverse impact to the environment. The Proposed Project is in keeping with the zoning classifications' recommended land use, design guidelines, and site layout standards. *Clarence 2030 – Town of Clarence Comprehensive Plan*, encourages the development of complementary industrial uses in the Town of Clarence.

#### 1. Impact on Land:

The Proposed Project involves the alteration and clearing of approximately 15.62 acres of natural land. Portions of the Project Site have an average depth to water table of less than three feet. The Proposed Project does not involve construction on slopes of 15% or greater, and bedrock is not within 5 feet of the existing ground surface on the Project Site. The Proposed Project will not involve the excavation and removal of more than 1,000 tons of natural material. The Project Site is not located within a designated Coastal Erosion hazard area. Since the Proposed Project will result in disturbance of more than one acre of land, a Stormwater Pollution Prevention Plan ("SWPPP") prepared by a licensed engineering firm will be required and the SWPPP will need to be reviewed and approved by the Town Engineering Department prior to project construction. The requirement for the SWPPP is outlined per the letter dated July 17, 2025 from Michelle Woznick of the New York State Department of Environmental Conservation ("NYSDEC").

The Proposed Project will result in physical disturbance and vegetation removal; however, this potential impact represents a small impact since construction activities will need to comply with required applicable erosion and sediment control measures. Such erosion and sediment control measures will be specified in the engineered plans to be prepared by a licensed

engineering firm as well as the required SWPPP. The proposed erosion control measures will be reviewed by the Town Engineering Department during the Development Plan review process.

Construction of the Proposed Project is anticipated to occur in two (2) phases and the construction of the first phase of the Proposed Project is anticipated to occur for a period of less than one year. Construction activities in furtherance of the Proposed Project will be intermittent and represent a temporary and unavoidable adverse impact that is not potentially significant. During the construction phases, the Proposed Project will need to comply with the applicable stringent standards for stormwater quality and storm quantity management as well as applicable standards for required infrastructure improvements. This will be verified by the Town Engineering Department in connection with the Development Plan review process.

#### 2. Impact on Geological Features:

There are no documented unique or unusual land forms on the Project Site.

#### 3. Impacts on Surface Water:

The Project Site currently consists of vacant land containing vegetation and jurisdictional wetlands of the New York State Department of Environmental Conservation ("NYSDEC") and the United States Army Corp of Engineers ("USACE"). In a letter dated July 17, 2025 from Michelle Woznick of the NYSDEC, it was stated that portions of New York State regulated freshwater wetlands and their adjacent areas may be located in the project area. Although some limited activities are exempt from permitting, most activities that involve disturbance within a wetland or its 100-foot adjacent area require an Environmental Conservation Law ("ECL") Article 24, Freshwater Wetlands permit from the NYSDEC. To determine whether the property contains regulated freshwater wetlands, the project sponsor must submit a request for a Parcel Jurisdictional Determination ("Parcel JD"). The aforementioned letter also stated that the Project Site may include federally regulated wetlands based on a review of the National Wetlands Inventory wetland mapping, and the Project Sponsor should consult with the USACE concerning USACE regulatory jurisdiction.

The Project Sponsor obtained a wetland verification letter from the NYSDEC on January 23, 2024 prior to the January 1, 2025 regulations taking effect. The Proposed Project will have 1.595 acres of NYSDEC wetland/buffer disturbance along with 1.259 acres of USACE wetland disturbance. If needed, an Article 24 will be submitted along with a Nationwide 14 permit. The wetland verification letter from the NYSDEC is valid until 2028. Regarding federally regulated wetlands, the Project Sponsor obtained a federal wetland jurisdictional determination on June 23, 2025. The Project Sponsor shall apply for a Nationwide Permit 14 to obtain the issuance of the 401 WQC.

Based on the comments received during the coordinated review, the Project Sponsor modified the overall site plan so as to minimally impact the regulated wetlands on the Project Site. The Project Sponsor shall obtain all appropriate and necessary permits from the regulatory agencies prior to site disturbance. Any proposed impacts to wetlands shall be subject to review

and approval by the appropriate regulatory agency. Such impacts, if approved, will not represent a potentially significant adverse environmental impact, due to any required mitigation, or other conditions of approval. Should approvals not be granted, the applicant will be required to propose a modification of the Project Site.

The management of stormwater from impervious surfaces on the Project Site will require the installation of a stormwater management system. The stormwater management areas to be installed on the Project Site shall be designed to collect, discharge and improve the quality of surface water. The stormwater management system shall be designed and installed per the applicable stringent stormwater quality and quantity standards of the NYSDEC and the applicable standards of the Town of Clarence.

#### 4. Impact on Groundwater:

Minimal additional groundwater will be introduced as a result of the Proposed Project. A portion of the post developed site stormwater will be collected, managed and disbursed on-site for eventual percolation into the groundwater system through stormwater detention areas as designed and permitted to meet Federal, State and Local standards.

The Proposed Project will connect to existing water services in the area of the Project Site and the connection will require review and approval by the Erie County Water Authority ("ECWA"). The Project Sponsor identified that there will be a need for new water services requiring anticipated water usage/demand per day of approximately 300 gallons. The Project Sponsor shall coordinate with the ECWA to review any new service or modifications to the existing water service. The aforementioned coordination requirement is outlined in a letter dated July 1, 2025 from Mark S. Carney of the ECWA. The design and review of the proposed connection will be addressed during the Development Plan Application review process.

The Proposed Project includes treated wastewater discharge to groundwater in the form of an on-site sanitary system. The on-site sanitary system shall be designed and permitted in order to function per Erie County Health Department and NYSDEC standards.

#### 5. Impact on Flooding:

The Project Site does not fall within a 100-year floodplain, nor is it located within a designated floodway. The Proposed Project will require modification of existing drainage patterns, but such modifications do not represent a potentially significant adverse environmental impact because of the requirement for the installation of a stormwater management system complying with the applicable stringent standards. Any future Development Plan submittal shall include an Engineer's Report and full grading and drainage plans and details prepared by a licensed engineering firm for review by the Town of Clarence prior to Development Plan Approval. In addition, the Proposed Project will include the implementation of NYSDEC compliant stormwater management practices.

#### 6. Impacts on Air:

The Proposed Project does not involve a State regulated air emission source.

#### 7. Impact on Plants and Animals:

In a letter dated July 17, 2025 by Michelle Woznick of the NYSDEC, it was stated that the NYSDEC reviewed the available information in the New York State Natural Heritage Program database on known occurrences of rare or state-listed animals and plants, of significant natural communities, and other significant habitats. The Short-eared Owl, a listed endangered species, was last documented near the Project Site in the year 2000. The Project Sponsor submitted an Information for Planning and Consultation ("IPaC") on August 11, 2025 to the United States Department of Fish and Wildlife Services for final determination regarding this matter.

The Lead Agency of the Proposed Project has determined that the impact to the local habitat is considered minimal because of the limited disturbance to the overall Project Site, and the majority of the Project Site will still contain an abundant natural habitat for the area's plants and animals. If any of the endangered species are observed during the Proposed Project construction activities, the NYSDEC Bureau of Wildlife should be contacted immediately. A Landscape Plan prepared by a Registered Landscape Architect will need to be reviewed and approved by the Town Landscape Review Committee for the purpose of introducing native and beneficial vegetation to the Project Site.

#### 8. Impact on Agricultural Resources:

The Project Site is located within Erie County Agricultural District #1; however, the Project Site does not contain agricultural resources. The Project Site consists primarily of naturally occurring vegetation and wetlands. The Proposed Project does not sever, cross or otherwise limit access to agricultural land. Additionally, the Proposed Project does not pose a potentially significant adverse impact to soil classified within soil group 1 through 4 of the NYS Land Classification System.

#### 9. Impact on Aesthetic Resources:

The Project Site is located on County Road. The Proposed Project is not in sharp contrast to the nearby land use patterns and does not pose as a potentially significant adverse impact to an officially designated scenic or aesthetic resource. The primary land use patterns surrounding the Project Site are industrial parks, agricultural operations, and natural lands.

#### 10. Impact on Historic and Archeological Resources:

The Project Site is not located in or adjacent to an area designated as sensitive by the State Historic Preservation Office ("SHPO") archeological site inventory. In a letter dated December 24, 2024 from Daniel Mackay of SHPO, it was stated that SHPO reviewed the Proposed Project in accordance with Section 106 of the National Historic Preservation Act of 1966 and found that no historic properties, including archaeological and/or historic resources, will be affected by this undertaking.

#### 11. Impact on Open Space and Recreation:

The Proposed Project will not result in a loss of recreational opportunities or a reduction of protected open space. The Proposed Project that consists of privately owned property will not result in a loss of recreational opportunities or a reduction of protected open space as designated in any adopted municipal open space plan. The Proposed Project will not inhibit the use of any nearby recreational areas.

#### 12. Impact on Critical Environmental Areas:

The Project Site is not located within or adjacent to a designated Critical Environmental Area.

#### 13. Impact on Transportation:

After a thorough review by involved and interested agencies, including but not limited to the Erie County Department of Public Works ("ECDPW") and Clarence Fire Review, it has been determined that the Proposed Project will not have a significant adverse impact on the existing transportation system. Using the NYS SEQRA EAF Workbook as a guiding document, the Proposed Project will not result in a significant increase in traffic.

The Project Sponsor will be required to obtain all appropriate permits from the ECDPW for any proposed curb cut modifications and closures. In a letter dated July 11, 2025 from Garrett M. Hacker of the ECDPW, it was stated that the ECDPW requires a full set of site plans, including a stormwater management system, prior to further review by the ECDPW.

#### 14. Impact on Energy:

The Proposed Project will cause an increase in the use of energy. The Proposed Project shall be designed to meet energy compliance standards through the installation of energy efficient facilities and features, having minimal impact on the environment. As part of the Development Plan review process, the Project Sponsor shall coordinate with the appropriate utilities to obtain all appropriate permits as required.

#### 15. Impact on Noise, Odor, and Light:

The potential impact from noise, odors, and lighting will be addressed through the installation of new landscaping to reduce noise impacts; the installation of enclosed dumpsters / tote garbage facilities to reduce odors; and installation of dark-sky compliant shielded lighting to avoid off-site light pollution. In addition, the general impact to noise, odor and light will be consistent with existing surrounding industrial land uses. There will be temporary and unavoidable impacts to noise, odor and lighting during construction activities in furtherance of the Proposed Project; however, the Planning Board has determined this is not a potentially significant adverse environmental impact.

#### 16. Impact on Human Health:

The Project Site does not include a known source of regulated hazardous materials detrimental to human health. If regulated hazardous materials exceeding the applicable NYSDEC thresholds are unexpectedly encountered during the construction of the Proposed Project, cleanup activities compliant with Federal, State and Local standards will be completed prior to construction on the relevant portions of the Project Site.

In a letter dated July 17, 2025 from Michelle Woznick of the NYSDEC, it was stated that the Proposed Project will involve the storage of 1,100 gallons or more of petroleum products on-site; therefore, a NYSDEC Petroleum Bulk Storage ("PBS") registration will be required pursuant to 6 NYCRR Parts 612-614. The Project Sponsor stated that the Proposed Project involves storage of 2,500 gallons of diesel fuel within 2 above ground storage tanks. The current 1,000 gallon and 1,500-gallon tanks at 9500 Martin Road will be transferred from the current business to the proposed business at 9865 County Road, Clarence NY. Per the regulations outlined by the NYSDEC, a PBS will be filed with the NYSDEC prior to the aforementioned transfer.

#### 17. Consistency with Community Plans:

Clarence 2030 – Town of Clarence Comprehensive Plan ("Clarence 2030") is the Town's adopted Comprehensive Plan. Clarence 2030 encourages the development of industrial land where existing utilities and services exist. Map 8 of Clarence 2030 ("Future Land Use Map") designates the Project Site as appropriate for Light Industry. The Proposed Project is consistent with the recommended land use and site layout guidance for the Industrial Business Park zoning classification. Per Town of Clarence Zoning Code Chapter 229 Section 229-100, the Industrial Business Park zoning classification allows for light manufacturing, landscape supply operations, lumberyards, and warehousing. Although it is no longer proposed as part of this Proposed Project, the Project Sponsor has shown interest in the Town of Clarence rezoning the rear southern portion of the Project Site from Agricultural Rural Residential to Industrial Business Park. Should the rezoning to Industrial Business Park be granted by the Town Board, it has been determined that this rezoning does not represent a potentially significant adverse environmental impact. The rezoning is keeping with the Future Land Use Map of Clarence 2030, and the Proposed Project is keeping with the desired complementary industrial development of this section of County Road.

#### 18. Consistency with Community Character:

County Road is an Erie County roadway predominantly consisting of industrial business and vacant industrially zoned land on either side. Directly adjoining the Project Site is an industrial facility, a school bus storage lot, and rural residential lots. The Proposed Project will not be in sharp contrast to the existing community character. The layout of the Proposed Project focuses on preserving natural buffers between the Project Site and the existing residential uses along Keller Road. Additional buffering is proposed to mitigate the potential view, noise, and light impact from the existing homes along Martin Road.

# PROPOSED WAREHOUSE

# James Ryan Parkway (Sub. Lot 8) Clarence, New York SITE DEVELOPMENT DRAWINGS

#### **AGENCIES**

ENGINEERING DEPARTMENT

NAME/TITLE: TIMOTHY LAVOCAT P.E., TOWN ENGINEER
COMPANY/DEPT: TOWN OF CLARENCE ENGINEERING DEPARTMENT

ADDRESS: 6221 GOODRICH ROAD

CLARENCE CENTER, NEW YORK 14032

TELEPHONE 716-741-8952

PLANNING & ZONING DEPARTMENT

NAME/TITLE: JONA

JONATHAN BLEUER, DIRECTOR OF COMMUNITY

DEVELOPMENT

COMPANY/DEPT: TOWN OF CLARENCE PLANNING DEPARTMENT

ONE TOWN PLACE
CLARENCE, NEW YORK 14031

TELEPHONE 716-741-8933

LAND SURVEYOR

NAME/TITLE:

NUSSBAUMER & CLARKE, INC

COMPANY/DEPT: 3556 LAKE SHORE ROAD, SUITE 500 ADDRESS: BUFFALO, NY 14219

TELEPHONE 716-827-8000

UTILITIES

NATURAL GAS
COMPANY/DEPT:.
ADDRESS:

NATIONAL FUEL GAS CORP.

6363 MAIN STREET WILLIAMSVILLE, NEW YORK 14221

TELEPHONE 716-857-7000

TELEPHONE COMPANY COMPANY/DEPT:

ADDRESS:

VERIZON 65 FRANKLIN STREET BUFFALO, NEW YORK 14203

TELEPHONE 716-840-8748

CABLE COMPANY COMPANY/DEPT:

COMPANY/DEPT: ADDRESS:

TIME WARNER 789 CHURCH ROAD WEST SENECA, NEW YORK

TELEPHONE 716-558-8615

ELECTRIC COMPANY

COMPANY/DEPT: ADDRESS:

NATIONAL GRID 144 KENSINGTON AVENUE BUFFALO, NEW YORK 14214

TELEPHONE 716-236-2738

WATER

COMPANY/DEPT:. ADDRESS: ERIE COUNTY WATER AUTHORITY 3030 UNION ROAD CHEEKTOWAGA, NEW YORK 14227

TELEPHONE 716-684-1510

DIG SAFELY NEW YORK

TELEPHONE 1-800-962-7962

OWNER/DEVELOPER

NAME: ADDRESS DAVID CAPRETTO 470 CAYUGA ROAD BUFFALO, NY 14225

CONTACT: TELEPHONE


DAVID CAPRETTO 716-688-5597

**ENGINEER** 

CARMINAWOOD DESIGN


80 Silo City Row, Suite 100 Buffalo, New York 14203 Phone: (716) 842-3165

111 Bain Street, Suite 332 Greensboro, North Carolina 27406 Phone: (336) 937-9009

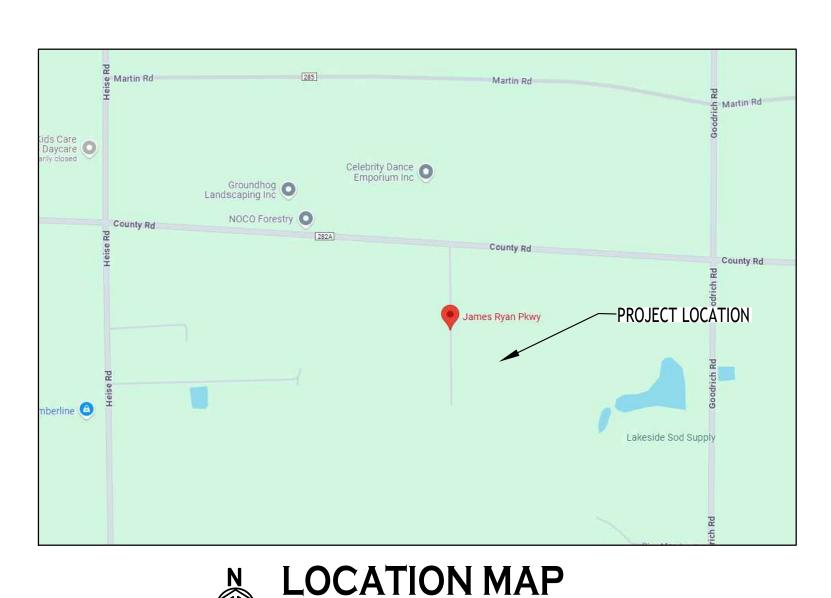

| DWG NO.  | DRAWING TITLE   |
|--|---|
| -<br>C-001<br>C-002<br>C-100<br>C-200<br>C-300<br>C-301<br>C-400<br>C-401<br>L-100<br>LP-100 | COVER SHEET SURVEY & TOPOGRAPHIC MAP DEMOLITION & EROSION CONTROL PLAN DEMOLITION & EROSION CONTROL DETAILS SITE PLAN AND DETAILS GRADING PLAN DRAINAGE PLAN DRAINAGE DETAILS UTILITY PLAN UTILITY DETAILS LANDSCAPE PLAN LIGHTING PLAN |

JUNE 2025

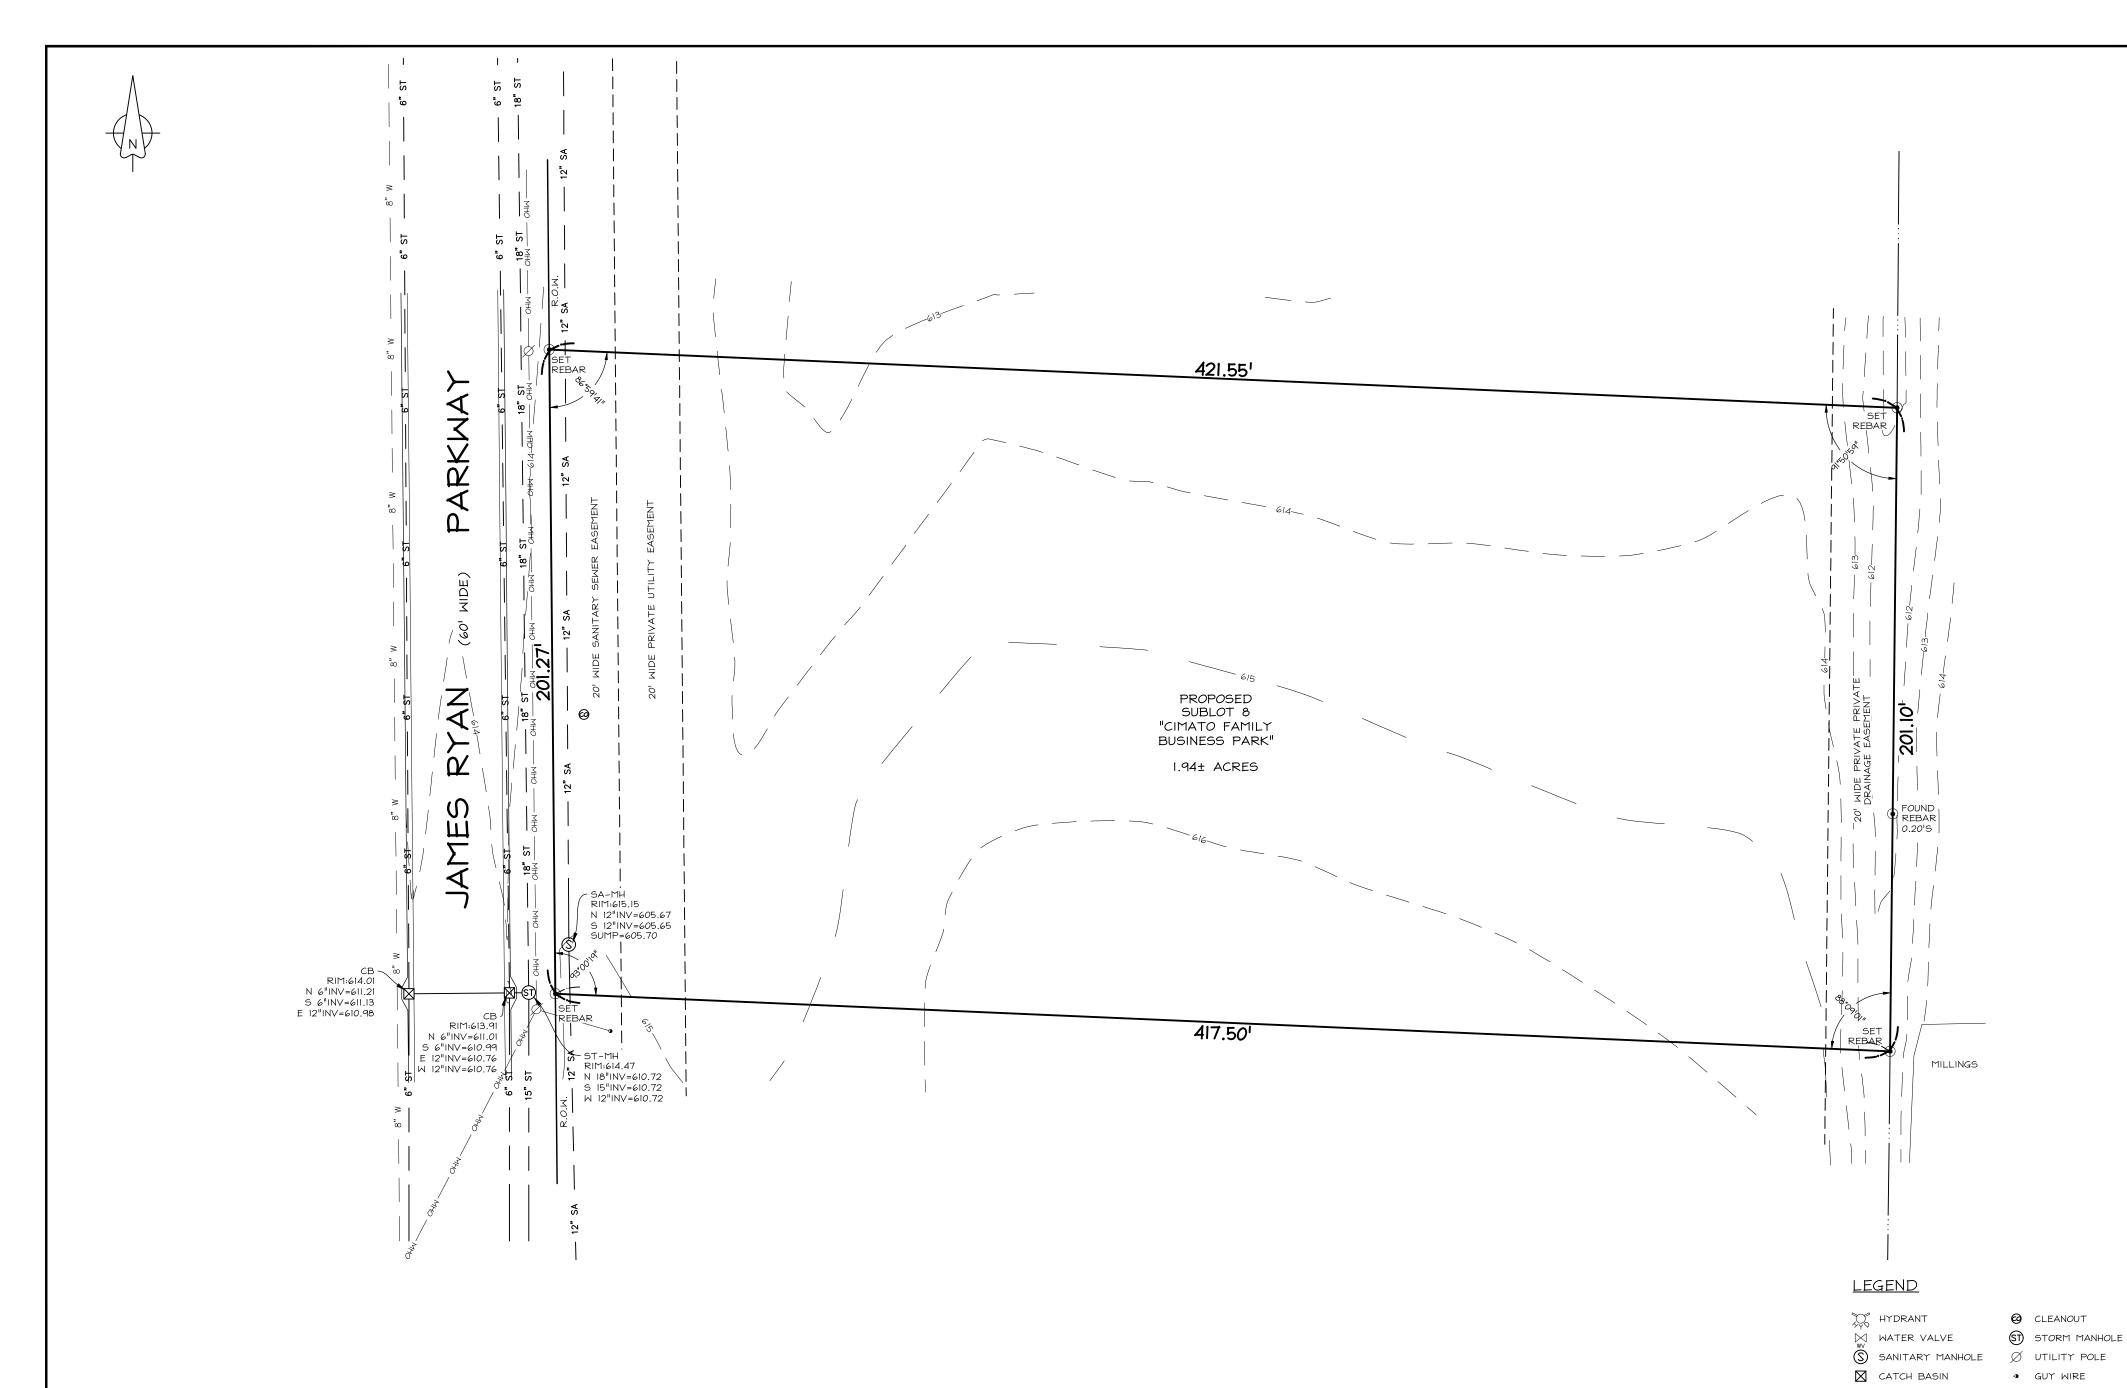

#### <u>NOTES</u>

- 1. ELEVATIONS ARE BASED UPON THE NORTH AMERICAN VERTICAL DATUM OF 1988 (NAVD 88).
- 2. HORIZONTAL DATUM REFERENCES THE NORTH AMERICAN DATUM 1983 (NAD 83) NEW YORK STATE PLANE WEST ZONE.
- 3. THE LOCATION OF ANY UNDERGROUND UTILITIES SHOWN ARE APPROXIMATE AND ALL UTILITIES MAY NOT BE SHOWN. PRIOR TO ANY CONSTRUCTION ACTIVITIES, ALL UTILITY COMPANIES SHOULD BE NOTIFIED IN ORDER TO VERIFY OR AMEND THEIR LOCATIONS AND/OR EXISTENCE. FOR ASSISTANCE CALL UFPO AT 1-800-962-7962.
- 4. UDIGNY.ORG DESIGN TICKET No. 10224-002-094 WAS SUBMITTED TO REQUEST UTILITY RECORDS:
- CHARTER COM NORTHEAST WESTERN NY: HAS RESPONDED, DESIGN CONFLICT, PLEASE SHARE DESIGN DRAWINGS WITH THEIR ENGINEERING DEPT.
- ERIE COUNTY WATER AUTHORITY: HAS RESPONDED, DRAWN HERON. - NATIONAL FUEL GAS / CLARENCE NFG-113: HAS RESPONDED, DRAWN HERON.



THIS SURVEY IS NOT VALID WITH AN AFFIDAVIT OF NO CHANGE 3556 Lake Shore Road, Suite 500, Buffalo, NY 14219 p (716) 827-8000 f (716) 270-6091 www.nussclarke.com This survey was prepared without the benefit of an abstract of title and is subject to any state of facts that may be revealed by an examination of such. Unauthorized alterations or additions to any survey, drawing design, specification, plan or report is a violation of section 7209, provision 2 of the New York State Education Law.

W ---- UNDERGROUND WATER

- OHW - OVERHEAD WIRES

---- SA ---- UNDERGROUND SANITARY SEWER ---- ST ---- UNDERGROUND STORM SEWER


### TOPOGRAPHIC SURVEY

James Ryan Parkway - Vacant Lot No. 8 Part of Lot 1, Section 12, Township 12, Range 6

Holland Land Company's Survey Town of Clarence County of Erie, State of New York

Date of Survey: 11/04/2024 Scale : 1" = 30' Project No.: 23J2-0708A



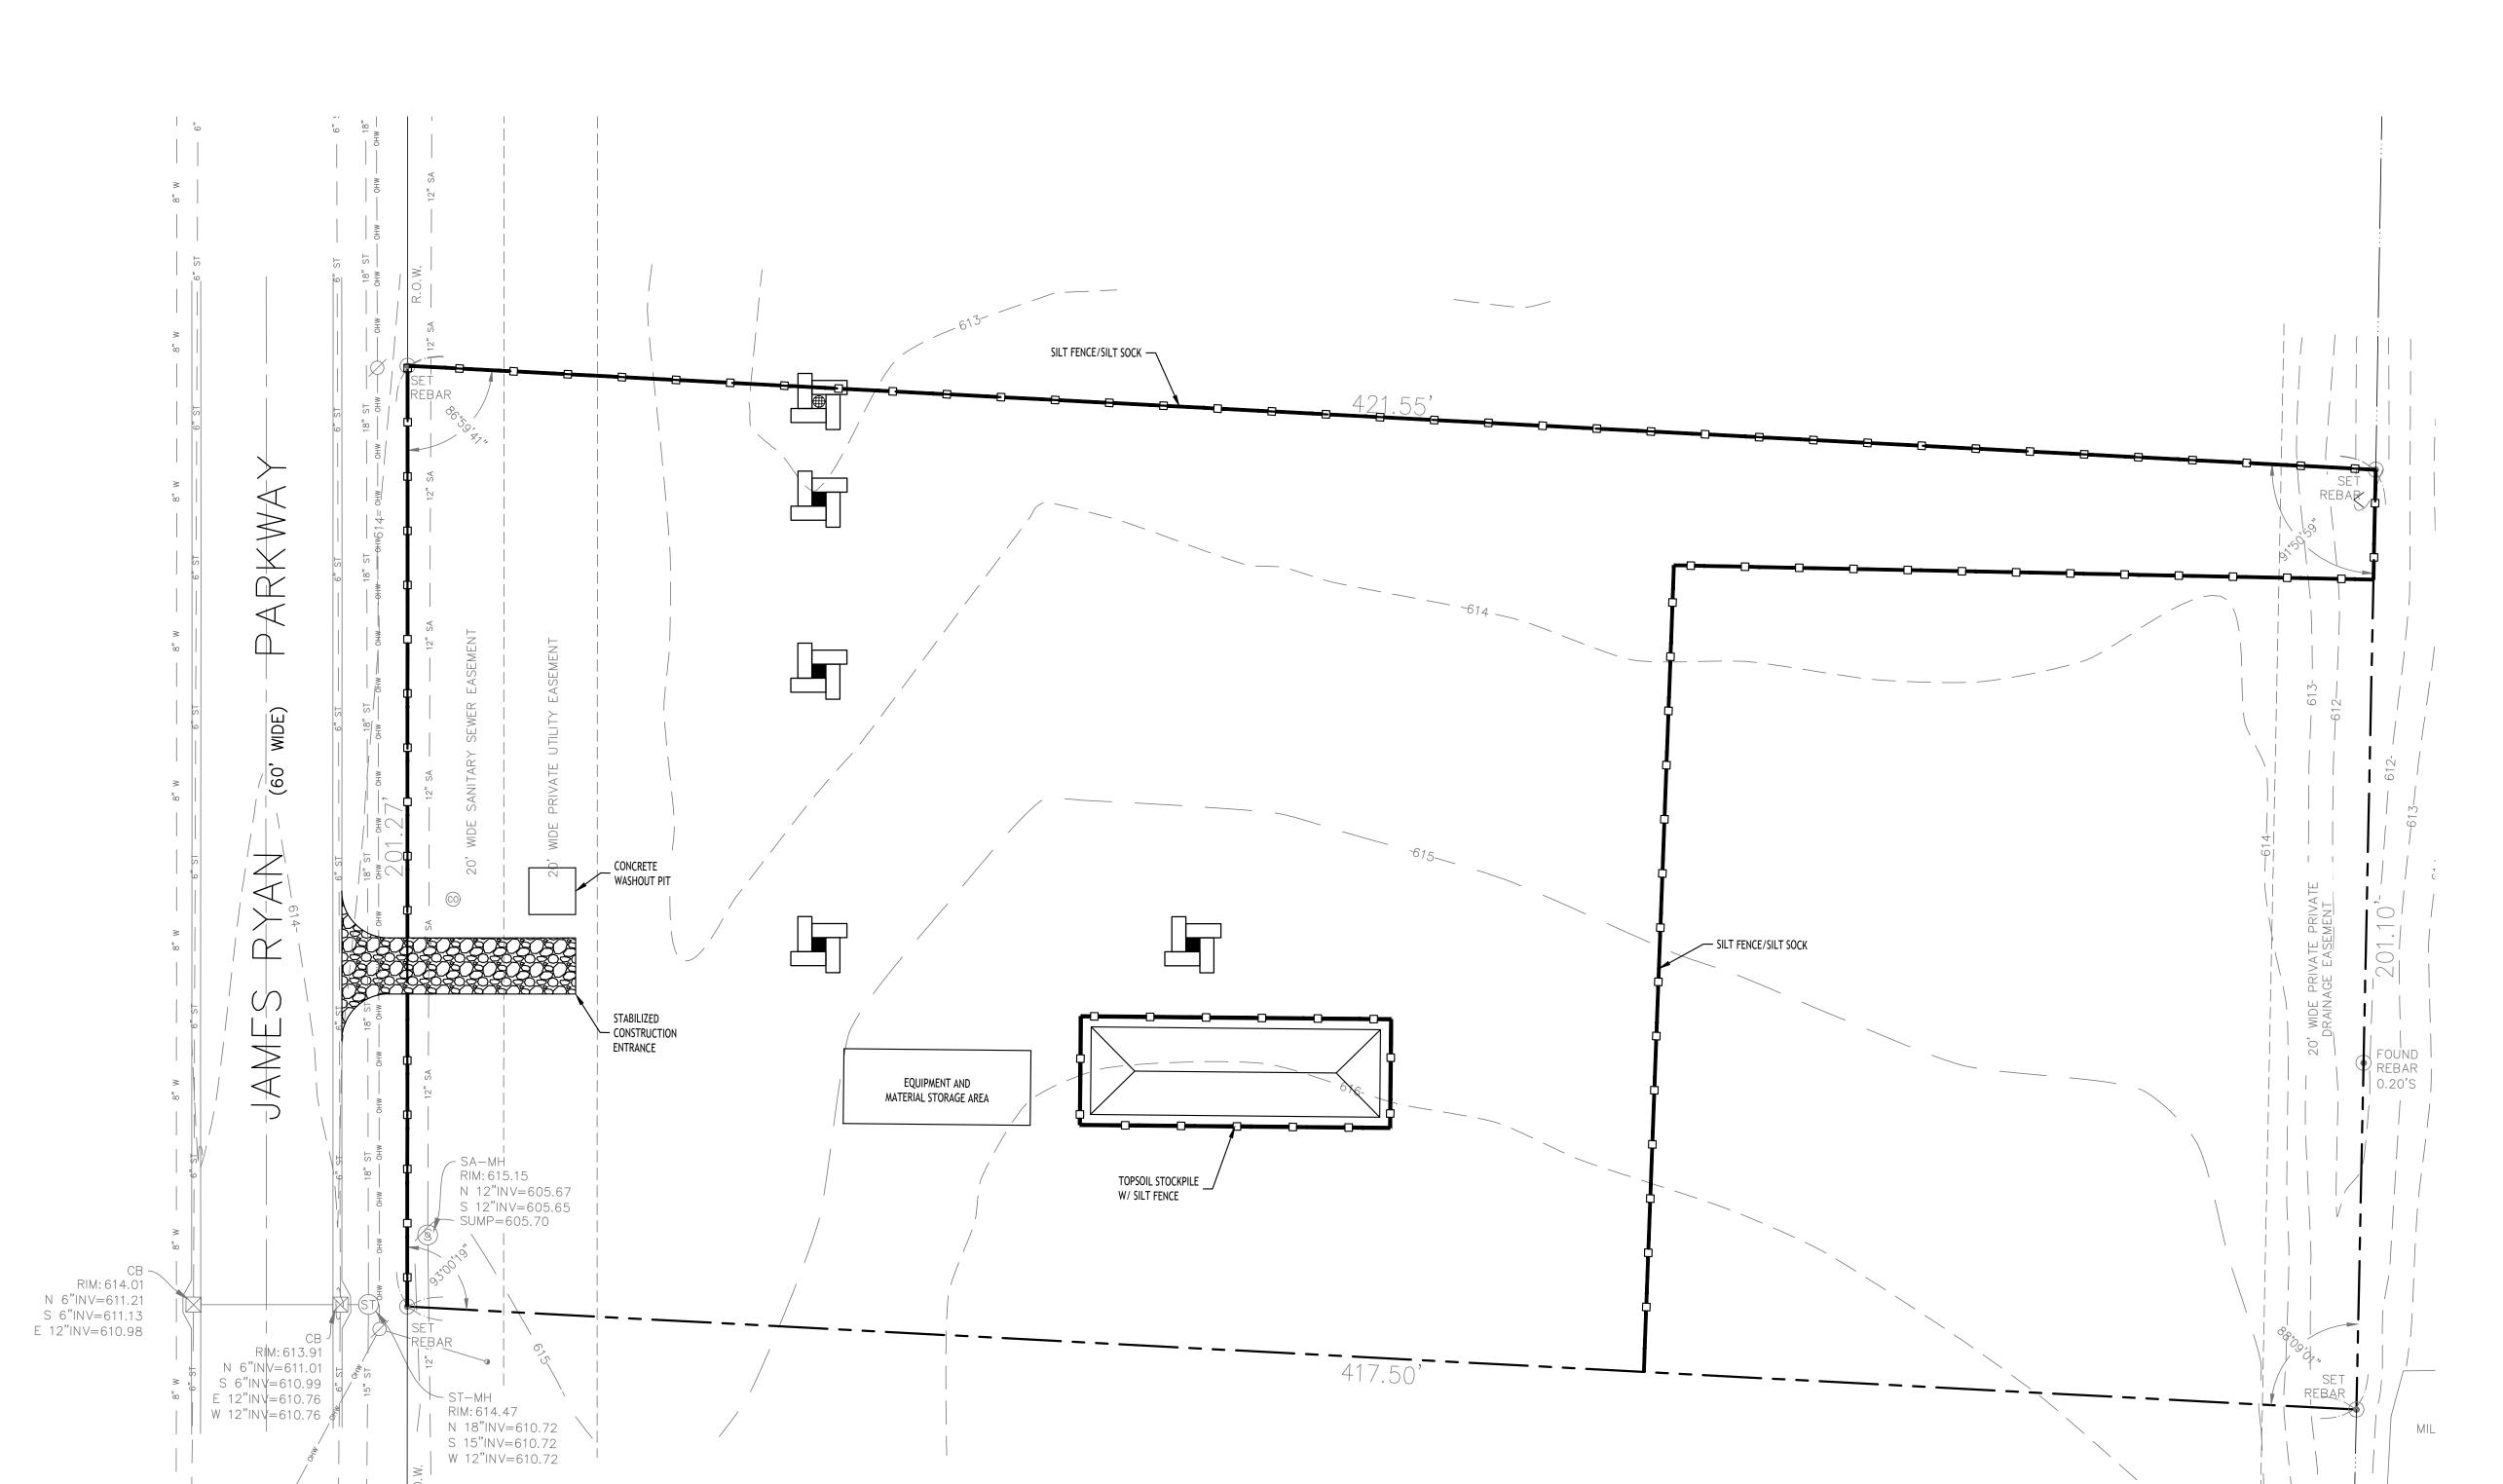


# Demo & Erosion Control Plan

#### EROSION CONTROL NOTES

THE FOLLOWING EROSION CONTROL PROCEDURES SHALL BE ADHERED TO BY THE CONTRACTOR:

- 1. INSTALL TEMPORARY SILT FENCE BARRIERS AS DIRECTED BY THE OWNER AND AT ALL EXISTING STORMWATER CATCH BASINS WITHIN THE WORK AREA TO PREVENT SEDIMENT MIGRATION. ALL SILT FENCE BARRIERS SHALL BE INSTALLED IN ACCORDANCE WITH THE DETAILS SHOWN ON THE PLANS.
- 2. TOPSOIL SHALL BE STRIPPED AND HAULED TO 1120 BULLIS ROAD, ELMA, NY 14059 AND HAULED BACK TO SITE AS NEEDED.
- 3. ALL SILT FENCE BARRIERS SHALL BE REPLACED WHEREVER THEY BECOME CLOGGED OR INOPERABLE.
- 4. THE CONTRACTOR SHALL BE RESPONSIBLE FOR MAINTENANCE AND REMOVAL OF TEMPORARY SEDIMENTATION CONTROLS.
- 5. THE CONTRACTOR MUST CONTROL DUST DURING CONSTRUCTION. DURING EARTHWORK OPERATIONS, WATER-SPREADING EQUIPMENT SHALL BE PROVIDED BY THE CONTRACTOR, AND SPREAD WATER AS NECESSARY AND AS DIRECTED BY THE OWNER IN ORDER TO CONTROL
- 6. DIRT OR DEBRIS LEFT ON LOCAL PUBLIC ROADS AS A RESULT OF THIS CONSTRUCTION PROJECT SHALL BE REMOVED AND ROAD SURFACES CLEANED BY THE CONTRACTOR ON A DAILY BASIS.
- 7. ALL DISTURBED AREAS (EXCEPT AREAS TO BE PAVED OR BUILT UPON) SHALL BE TOPSOILED TO A MINIMUM 6" DEPTH AND SEEDED IMMEDIATELY AFTER FINE GRADING TAKES PLACE AND AS SOON AS PHYSICALLY POSSIBLE.
- 8. THE CONTRACTOR IS RESPONSIBLE FOR THE MAINTENANCE OF DOWNSTREAM STORM SEWERS, DITCHES, AND CULVERTS. SILT BUILDUP FOUND TO BE A RESULT OF THIS SITE CONSTRUCTION WORK SHALL BE REMOVED FROM DOWNSTREAM CULVERTS BY THE CONTRACTOR AT NO ADDITIONAL EXPENSE TO THE OWNER OR THE TOWN/CITY.
- 9. ALL SOIL EROSION AND SEDIMENT CONTROL DEVICES AND MATERIALS SHALL BE IN PLACE PRIOR TO BEGINNING EARTHWORK OPERATIONS AND SHALL BE MAINTAINED UNTIL THE NEW SLOPES ARE STABILIZED WITH SEEDING AND/OR SLOPE PROTECTION, AS DIRECTED BY THE ENGINEER.
- 10. INSTALL TEMPORARY SILT FENCE AROUND THE BASE OF STOCKPILES.

- 1. THE CONTRACTOR SHALL TAKE PRECAUTIONS TO PROTECT THOSE ITEMS TO REMAIN, SUCH AS SIDEWALKS, TREES, PROPERTY CORNER PINS, UTILITY POLES, VALVES, HYDRANTS, CURBS, MANHOLES AND CATCH BASINS.
- 2. TEMPORARY SILT FENCE AND STRAW BALES TO BE INSTALLED AS DIRECTED BY THE OWNERS FIELD REPRESENTATIVE. MAINTAIN UNTIL VEGATATION IS ESTABLISHED AND PAVEMENT IS INSTALLED.
- 3. FOR THOSE STRUCTURES TO BE DEMOLISHED, ALL EXISTING UTILITY SERVICES SHALL BE ABANDONED IN ACCORDANCE WITH LOCAL REGULATIONS, ALL METERS SHALL BE RETURNED TO PROPER OWNERS.
- 4. THE CONTRACTOR SHALL INSTALL STABILIZED CONSTRUCTION ENTRANCES WHERE ACCESSING THE SITE FROM PAVED
- 5. THE CONTRACTOR SHALL INSTALL TEMPORARY TRAFFIC CONTROL DEVICES IN ACCORDANCE WITH NYS M.U.T.C.D. STANDARDS PRIOR TO STARTING WORK.

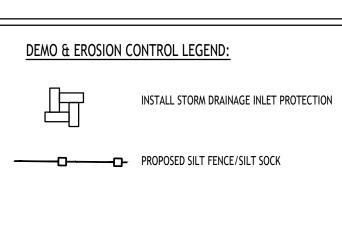

NOTE: BOUNDARY AND TOPOGRAPHIC INFORMATION PROVIDED BY OTHERS, CARMINA WOOD DESIGN ASSUMES NO RESPONSIBILITY FOR ITS ACCURACY.

DRAWING NAME: Demo & Erosion Control Plan

> Drawn By: Scale:

As Noted DRAWING NO.

6/12/25 A. Pandolfe


#### CONSTRUCTION SPECIFICATIONS

- 1. CLEAR THE AREA OF ALL DEBRIS THAT WILL HINDER EXCAVATION.
- GRADE APPROACH TO THE INLET UNIFORMLY AROUND THE BASIN.
- 3. WEEP HOLES SHALL BE PROTECTED BY GRAVEL.
- 4. UPON STABILIZATION OF CONTRIBUTING DRAINAGE AREA, SEAL WEEP HOLES, FILL BASIN WITH STABLE SOIL TO FINAL GRADE, COMPACT IT PROPERLY AND STABILIZE WITH PERMANENT SEEDING.


MAXIMUM DRAINAGE AREA 1 ACRE

#### CONSTRUCTION SPECIFICATIONS

- 1. FILTER FABRIC SHALL HAVE AN EOS OF 40-85. BURLAP MAY BE USED FOR SHORT TERM APPLICATIONS. 2. CUT FABRIC FROM A CONTINUOUS ROLL TO ELIMINATE JOINTS. IF JOINTS ARE NEEDED THEY WILL BE OVERLAPPED TO
- 3. STAKE MATERIALS WILL BE STANDARD 2" x 4" WOOD OR EQUIVALENT. METAL WITH A MINIMUM LENGTH OF 3 FEET.
- 4. SPACE STAKES EVENLY AROUND INLET 3 FEET APART AND DRIVE A MINIMUM 18 INCHES DEEP. SPANS GREATER THAN 3 FEET MAY BE BRIDGED WITH THE USE OF WIRE MESH BEHIND THE FILTER FABRIC FOR SUPPORT.
- 5. FABRIC SHALL BE EMBEDDED 1 FOOT MINIMUM BELOW GROUND AND BACKFILLED. IT SHALL BE SECURELY FASTENED TO
- 6. A 2" x 4" WOOD FRAME SHALL BE COMPLETED AROUND THE CREST OF THE FABRIC FOR OVER FLOW STABILITY. MAXIMUN DRAINAGE AREA 1 ACRE

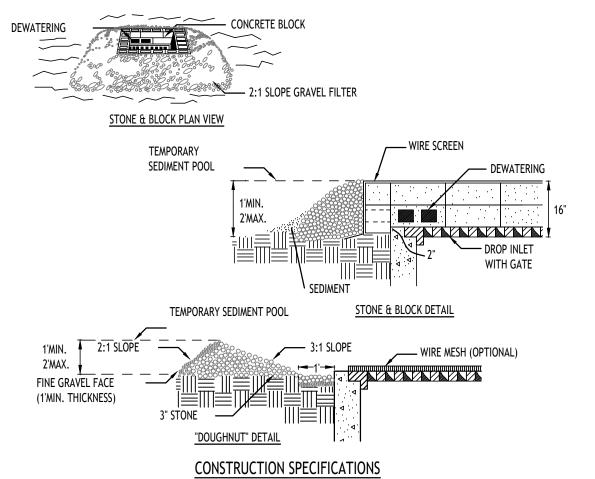

- 1. LAY ONE BLOCK ON EACH SIDE OF THE STRUCTURE ON ITS SIDE FOR DEWATERING. FOUNDATION SHALL BE 2 INCHES MINIMUM BELOW REST OF INLET AND BLOCKS SHALL BE PLACED AGAINST INLET FOR SUPPORT.
- 2. HARDWARE CLOTH OR 1/2" WIRE MESH SHALL BE PLACED OVER BLOCK OPENINGS TO SUPPORT STONE.
- 3. USE CLEAN STONE OR GRAVEL 1/2-3/4 INCH IN DIAMETER PLACED 2 INCHES BELOW TOP OF THE BLOCK ON A 2:1 SLOPE OR FLATTER.
- 4. FOR STONE STRUCTURES ONLY, A 1 FOOT THICK LAYER OF THE FILTER STONE WILL BE PLACED AGAINST THE 3 INCH STONE AS SHOWN ON THE MAXIMUM DRAINAGE AREA 1 ACRE

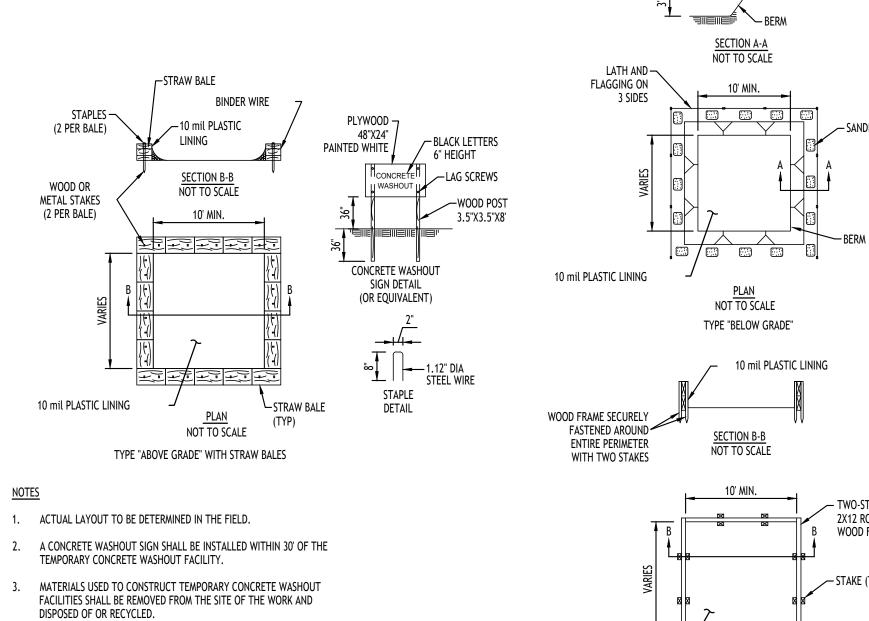

-DUMP STRAPS

(2 EACH)

**BAG DETAIL** 

-1" REBAR FOR

BAG REMOVAL

STRAP

(MANUFACTURED

INSPECT AFTER EVERY RAINFALL OR 3 WEEKS

BY ACF, OR

AND EMPTY.

FROM INLET

SILTSACK

EQUAL)

EXPANSION RESTRAINT-


(1/4" NYLON ROPE,

2" FLAT WASHERS)

SILT SACK DETAIL

NOT TO SCALE

- 4. HOLES, DEPRESSIONS OR OTHER GROUND DISTURBANCE CAUSED BY THE RÉMOVAL OF THE TEMPORARY CONCRETE WASHOUT FACILITIES SHALL BE BACKFILLED, REPAIRED, AND STABILIZED TO PREVENT

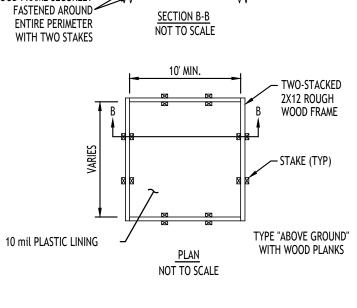

#### INLET PROTECTION DETAIL

FILTER CLOTH SHALL BE EITHER FILTER X, MIRAFI 100X, STABILINKA T140N, OR APPROVED EQUIVALENT.


3. MAINTENANCE SHALL BE PERFORMED AS NEEDED AND MATERIAL REMOVED WHEN "BULGES" DEVELOP IN THE SILT FENCE.

SILT FENCE DETAIL

NOT TO SCALE

## **INLET PROTECTION DETAIL 2**

#### NOTE: INSTALL ONE OF THE INLET PROTECTION OPTIONS SHOWN PRIOR TO CONSTRUCTION

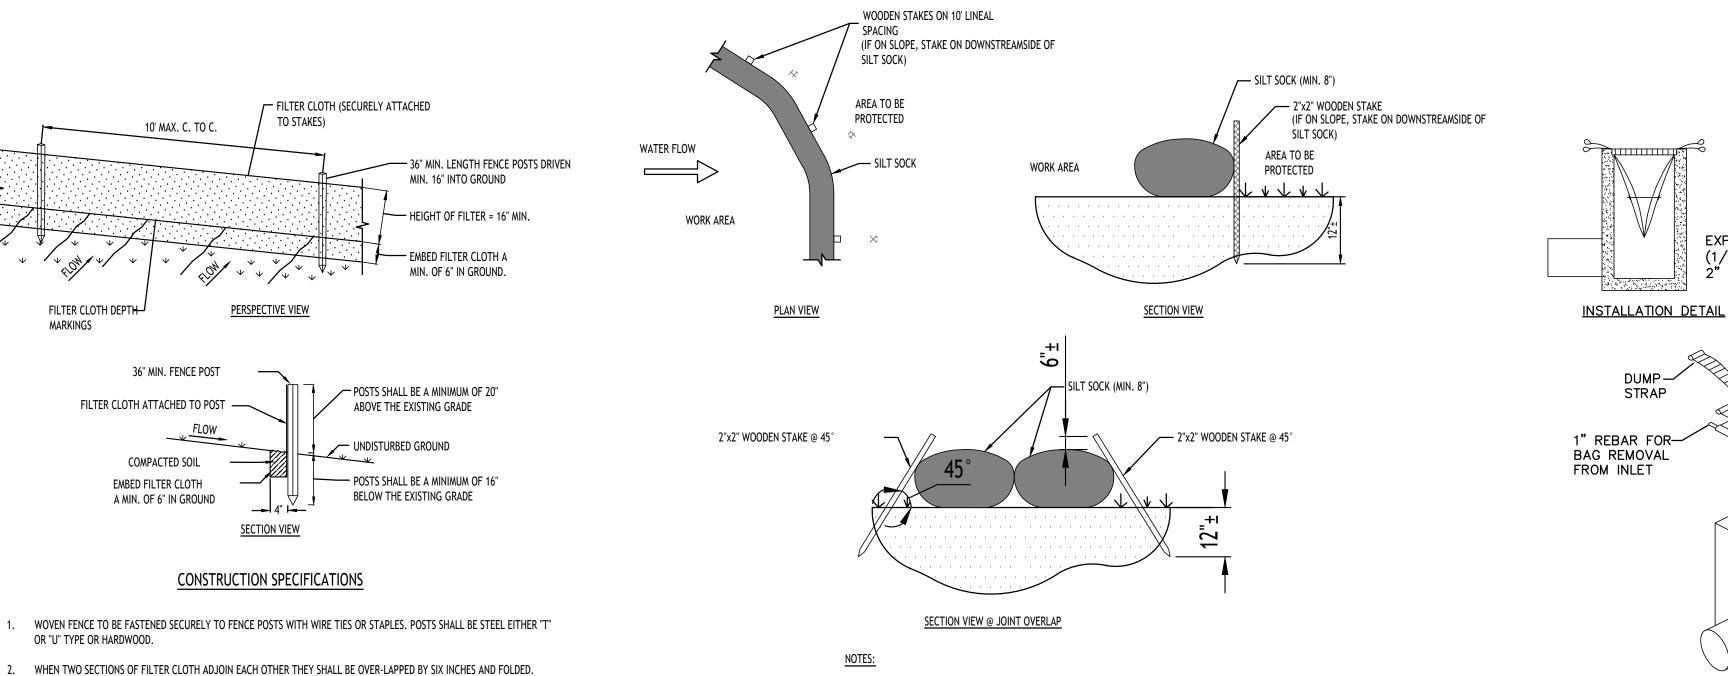


CONTRACTOR SHALL INSPECT AND MAINTAIN SILT SOCK AS NEEDED DURING THE DURATION OF

CONTRACTOR SHALL REMOVE SEDIMENT COLLECTED AT THE BASE OF THE SILT SOCK WHEN IT HAS REACHED <sup>1</sup>/<sub>2</sub> OF THE EXPOSED HEIGHT OF THE SILT SOCK. ALTERNATIVELY, RATHER THAN CREATE A SOIL DISTURBING ACTIVITY, THE ENGINEER MAY CALL FOR ADDITIONAL SILT SOCK TO BE ADDED AT AREAS OF HIGH SEDIMENTATION, PLACED IMMEDIATELY ON TOP OF THE EXISTING SEDIMENT LADEN SILT SOCK.

SILT SOCK SHALL BE OVERLAPPED 12" AT JOINTS AND STAKED ON EACH SIDE OF THE SOCK AT A 45° ANGLE

# **INLET PROTECTION DETAIL 3**

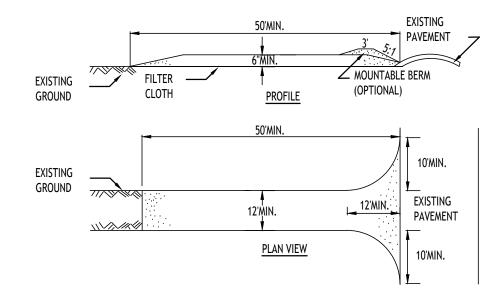

#### CONSTRUCTION SPECIFICATIONS

10 mil PLASTIC LINING

1. STONE SIZE - USE 2" STONE, OR RECLAIMED OR RECYCLED CONCRETE EQUIVALENT.

CONCRETE WASHOUT DETAIL NOT TO SCALE

- 2. LENGTH NOT LESS THAN 50 FEET (EXCEPT ON A SINGLE RESIDENCE LOT WHERE A 30 FOOT MINIMUM LENGTH WOULD
- 3. THICKNESS NOT LESS THAN SIX (6) INCHES.
- 4. WIDTH TWELVE (12) FOOT MINIMUM, BUT NOT LESS THAN THE FULL WIDTH AT POINTS WHERE INGRESS OR EGRESS OCCURS. TWENTY-FOUR (24) FOOT IF SINGLE ENTRANCE TO SITE.
- 5. FILTER CLOTH WILL BE PLACED OVER THE ENTIRE AREA PRIOR TO PLACING OF STONE.
- 6. SURFACE WATER ALL SURFACE WATER FLOWING OR DIVERTED TOWARD CONSTRUCTION ENTRANCES SHALL BE PIPED ACROSS THE ENTRANCE. IF PIPING IS IMPRACTICAL, A MOUNTABLE BERM WITH 5:1 SLOPES WILL BE PERMITTED.
- 7. MAINTENANCE THE ENTRANCE SHALL BE MAINTAINED IN A CONDITION WHICH WILL PREVENT TRACKING OR FLOWING OF SEDIMENT ONTO PUBLIC RIGHTS-OF-WAY, ALL SEDIMENT SPILLED, DROPPED, WASHED OR TRACTED ONTO PUBLIC RIGHTS-OF-WAY MUST BE REMOVED IMMEDIATELY.
- 8. WHEN WASHING IS REQUIRED, IT SHALL BE DONE ON A AREA STABILIZED WITH STONE AND WHICH DRAINS INTO AN APPROVED SEDIMENT TRAPPING DEVICE.
- 9. PERIODIC INSPECTION AND NEEDED MAINTENANCE SHALL BE PROVIDED AFTER EACH RAIN.

# STABILIZED CONSTRUCTION ENTRANCE DETAIL

#### SILT SOCK DETAIL N.T.S.

CONSTRUCTION PROJECT.

PRELIMINARY NOT FOR CONSTRUCTION

DRAWING NAME: Demo & Erosion **Control Details** 

Drawn By: Scale: DRAWING NO.

6/12/25

As Noted

A. Pandolfe

DRAWING NAME:

Site Plan and Details

Drawn By:

2/25/25 A. Pandolfe As Noted

DRAWING NO.

Project No: 24-4137

NOTE: BOUNDARY AND TOPOGRAPHIC INFORMATION PROVIDED BY OTHERS, CARMINA WOOD DESIGN ASSUMES NO RESPONSIBILITY FOR ITS ACCURACY.

\_\_\_\_


SITE LEGEND


PROPERTY LINE


PROPOSED SIDEWALK / CONCRETE PAD

NUMBER OF PARKING SPACES

PROPOSED WALL MOUNTED LIGHT

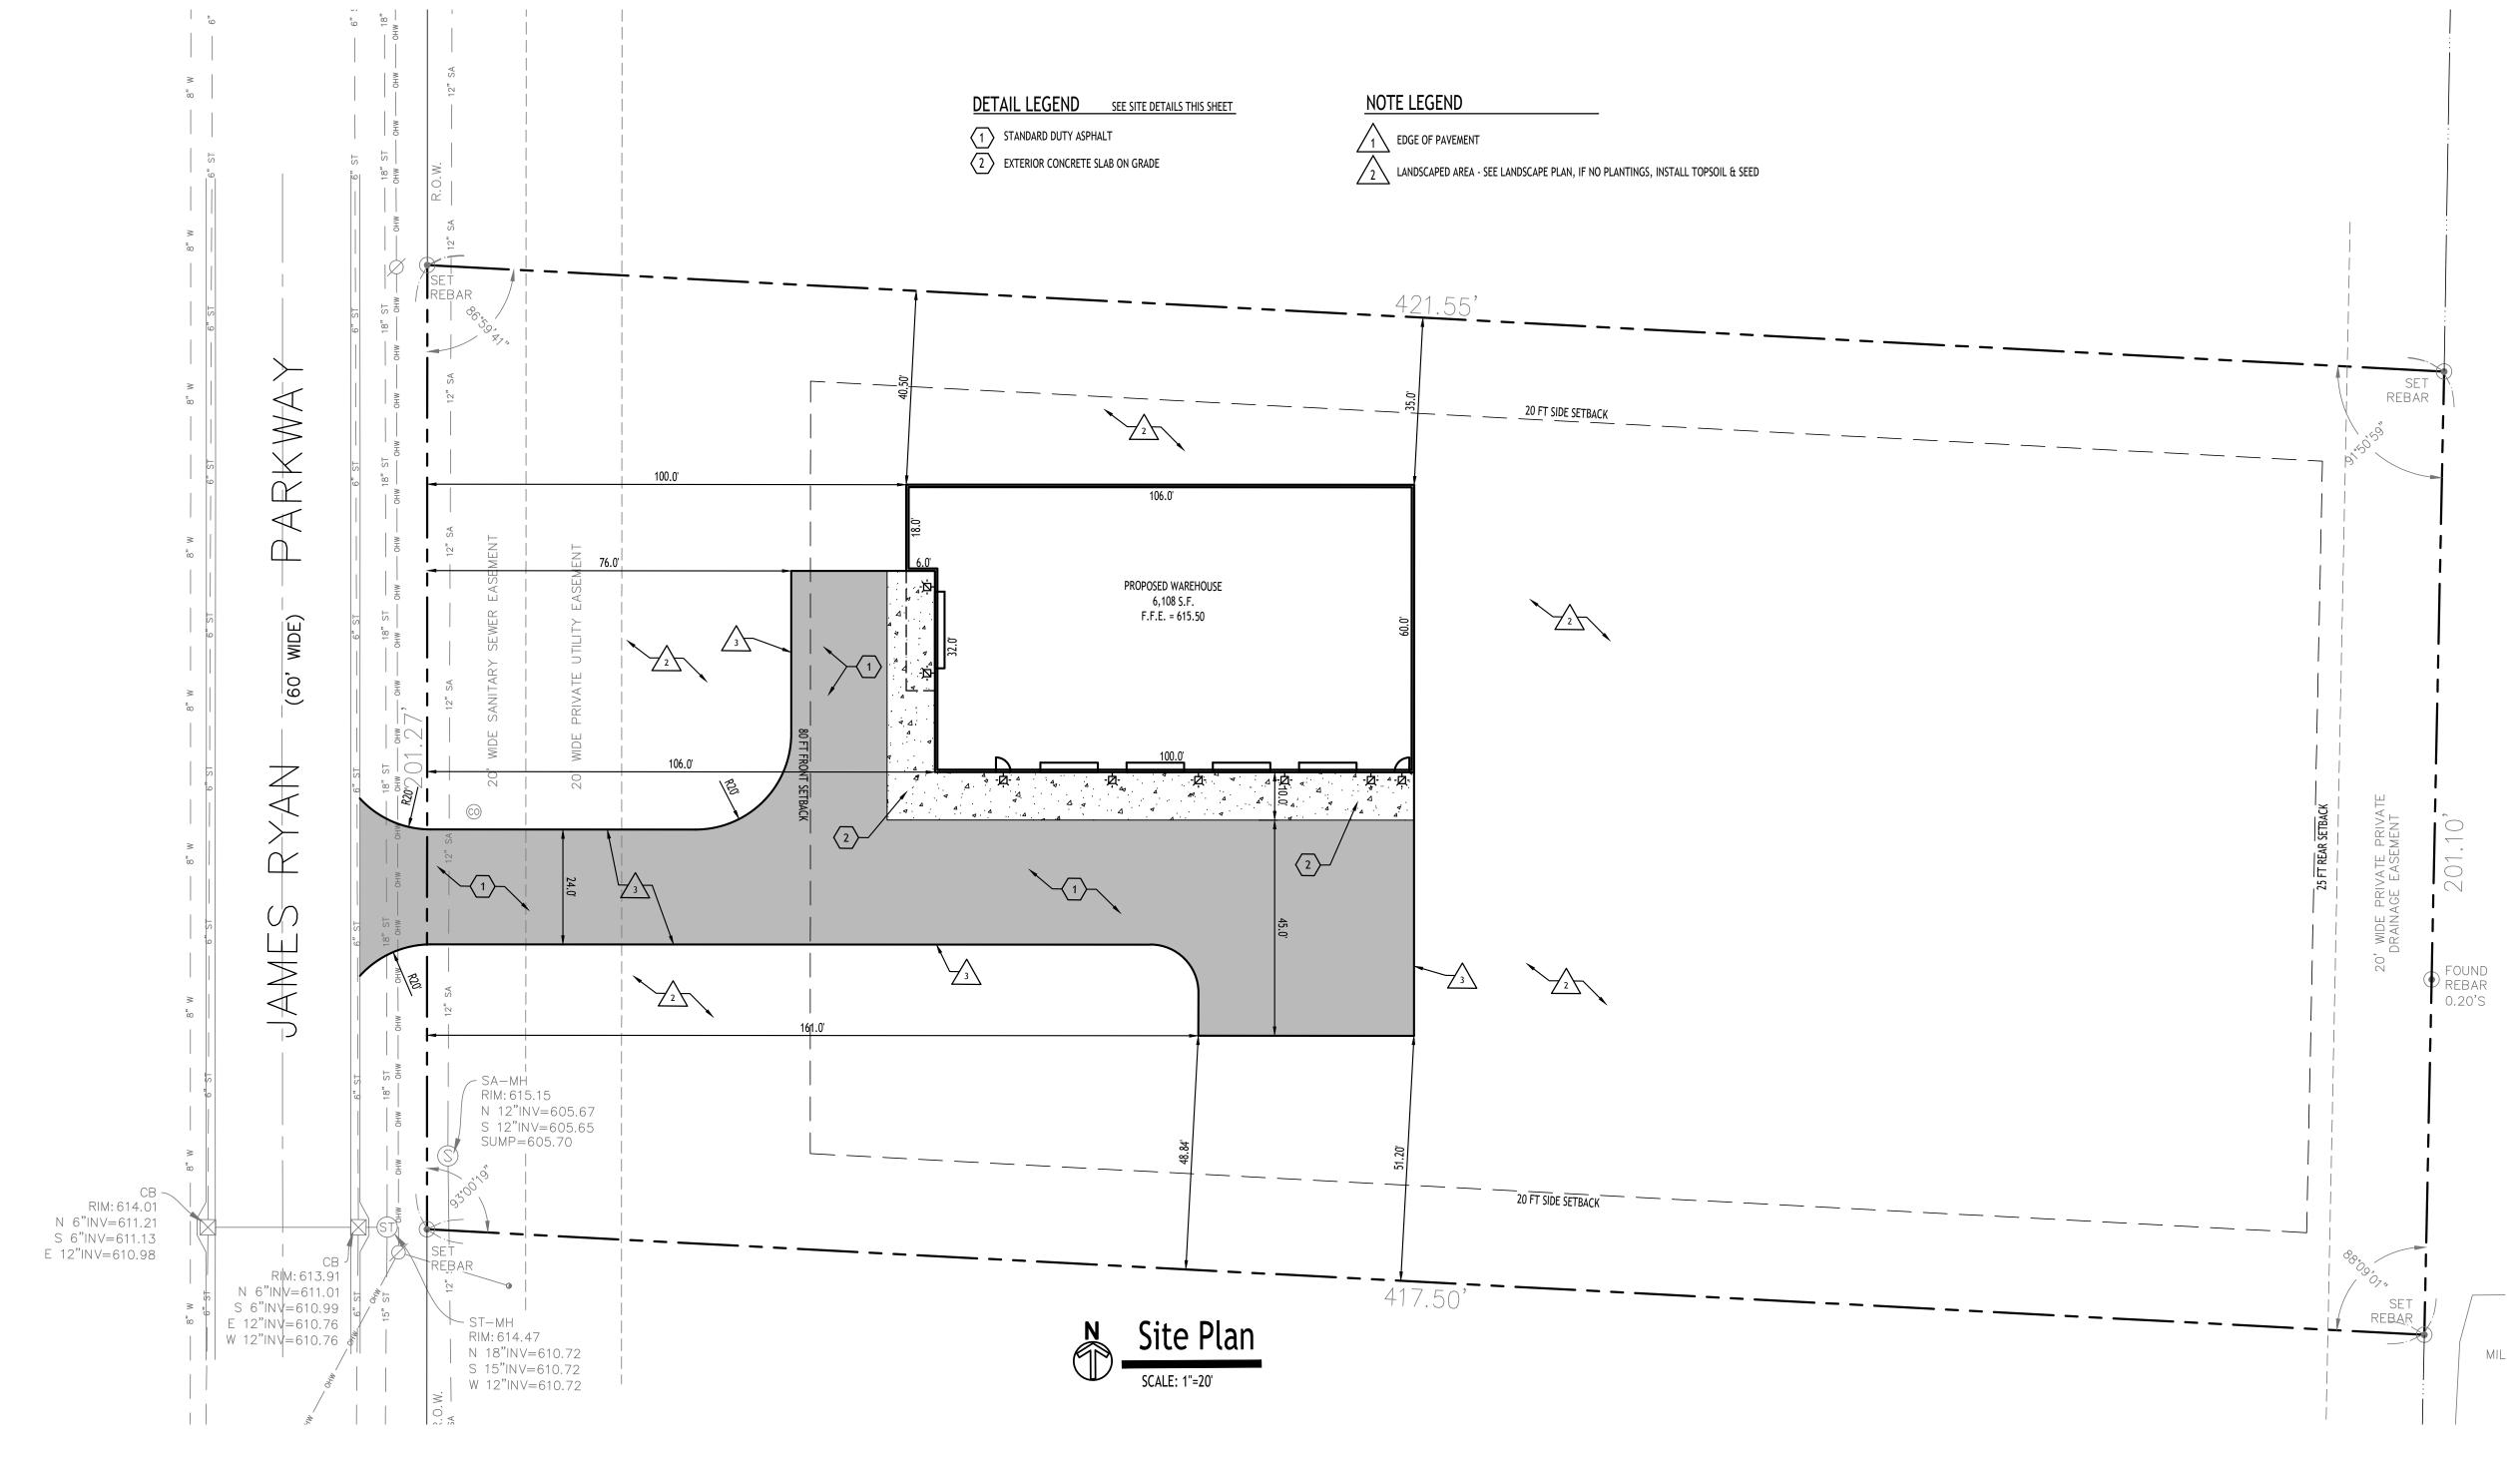

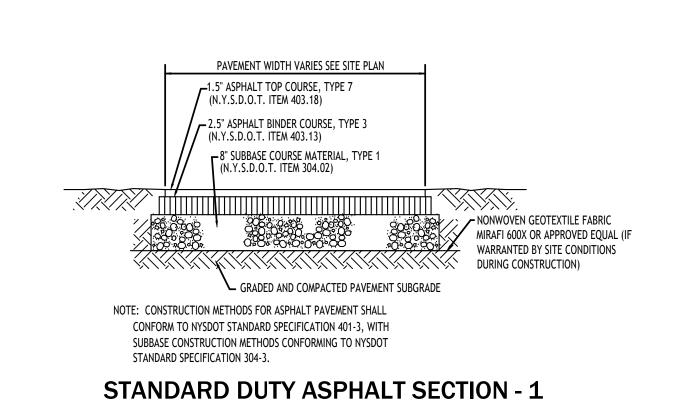

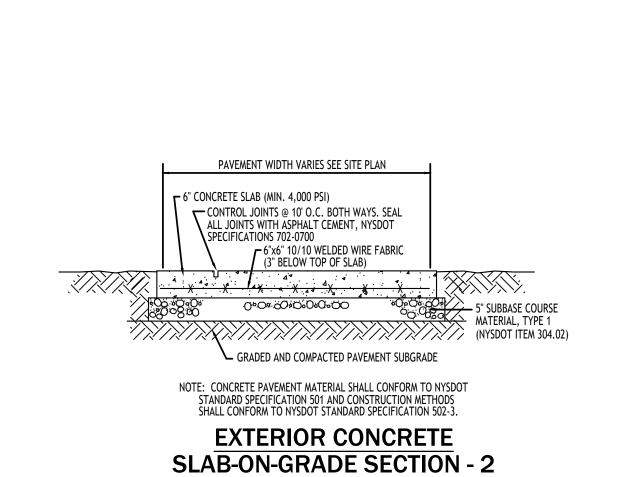

| Site Data   |          |            |  |  |
|---|----------|------------|--|--|
| SITE AREA = 1.93 AC (0.90 AC. TO BE DISTURBED)  ZONED: I - INDUSTRIAL BUSINESS PARK |          |            |  |  |
|   |          |            |  |  |
| SETBACKS - BUILDING   | REQUIRED | PROVIDED   |  |  |
| FRONT   | 80 FT    | 100 FT     |  |  |
| SIDE  | 20 FT    | 35 FT MIN. |  |  |
| REAR  | 25 FT    | > 25 FT    |  |  |
| PARKING   |          |            |  |  |
| # OF SPACES - SEE CALCULATION BELOW   | 13       | 13         |  |  |
| PARKING SPACE SIZE  | 9' x 19' | 9' x 19'   |  |  |
| MIN. LOT SIZE   | 1.0 AC.  | 1.93 AC.   |  |  |
| MIN. LOT WIDTH  | 1.0 AC.  | 1.93 AC.   |  |  |
| MIN. LOT DEPTH  | 1.0 AC.  | 1.93 AC.   |  |  |
| MAX. BUILDING HEIGHT  | 1.0 AC.  | 1.93 AC.   |  |  |

| PROVIDED              | 3.<br>4.       |
|-----------------------|----------------|
| 100 FT                | 5.             |
| 35 FT MIN.<br>> 25 FT | 6.             |
| 2011                  | 7.             |
| 13<br>9' x 19'        | 8.<br>9.       |
| 1.93 AC.              | <u>NOT</u>     |
| 1.93 AC.              | 1.<br>2.       |
| 1.93 AC.              | 3.<br>4.<br>5. |
| 1.93 AC.              |                |

GENERAL NOTES:

DRAWINGS PRIOR TO PROCEEDING WITH THE WORK.

ALL RADII SHALL BE 3'-0" UNLESS OTHERWISE NOTED.

CENTER ENTRANCE SIDEWALKS ON DOOR OPENINGS.

ALL DISTURBED AREAS: SHALL HAVE 4" MIN. OF TOPSOIL & SEED.

1. INSTALL ALL MATERIALS TO MANUFACTURER'S RECOMMENDATIONS AND BEST STANDARDS OF TRADE INVOLVED.

CONTRACTOR SHALL KEEP JOB FREE OF DEBRIS AND MAKE FINAL CLEANUP TO SATISFACTION OF OWNER.

CONTRACTOR SHALL OBTAIN AND PAY FOR ALL REQUIRED PERMITS NECESSARY TO PERFORM THE WORK.

ALL DIMENSIONS FROM PROPERTY LINES SHALL BE MEASURED PERPENDICULAR TO THE PROPERTY LINE.

BUILDING DIMENSIONS ARE APPROXIMATE, REFER TO ARCHITECTURAL DRAWINGS FOR LAYOUT DIMENSIONS.

AND/OR INSTALLATIONS. COORDINATE ALL WORK WITH THE APPLICABLE UTILITY COMPANIES.

SUBSTITUTIONS SHALL BE MADE ONLY WITH OWNER'S APPROVAL AND BE OF EQUIVALENT QUALITY TO WHAT IS SPECIFIED. WORK SHALL BE COMPLETED IN STRICT ACCORDANCE WITH ALL LOCAL CODES AND OSHA SAFETY RULES AND REGULATIONS.

VERIFY ALL EXISTING CONDITIONS AND DIMENSIONS AT THE SITE. NOTIFY OWNER & ENGINEER OF DISCREPANCIES IN CONDITIONS SHOWN ON

CONTRACTOR SHALL BE RESPONSIBLE FOR PROTECTION OF ANY EXISTING STRUCTURES TO REMAIN AND ANY FINISH MATERIAL INSTALLED WHILE

CONTRACTOR SHALL ASCERTAIN THE LOCATION OF ALL UTILITIES PRIOR TO CONSTRUCTION SO THAT THIS WORK WILL NOT DISTURB EXISTING LINES


ALL REASONABLE MEASURES SHALL BE TAKEN TO PROTECT EXISTING TREES WHICH ARE TO BE PRESERVED FROM ALL POSSIBLE TYPES OF ROOT, TRUNK,

AND LIMB DAMAGE; INCLUDING BUT NOT LIMITED TO, RETAINING WALLS WHICH PREVENT FILLING ON TOP OF ROOTS OR EXCAVATING TREE ROOTS.

PARKING CALCULATION:

INDUSTRIAL: REQ'D = 1 SPACE PER 400 S.F.

5,108 S.F. / 400 = <u>13 SPACES REQ'D</u>

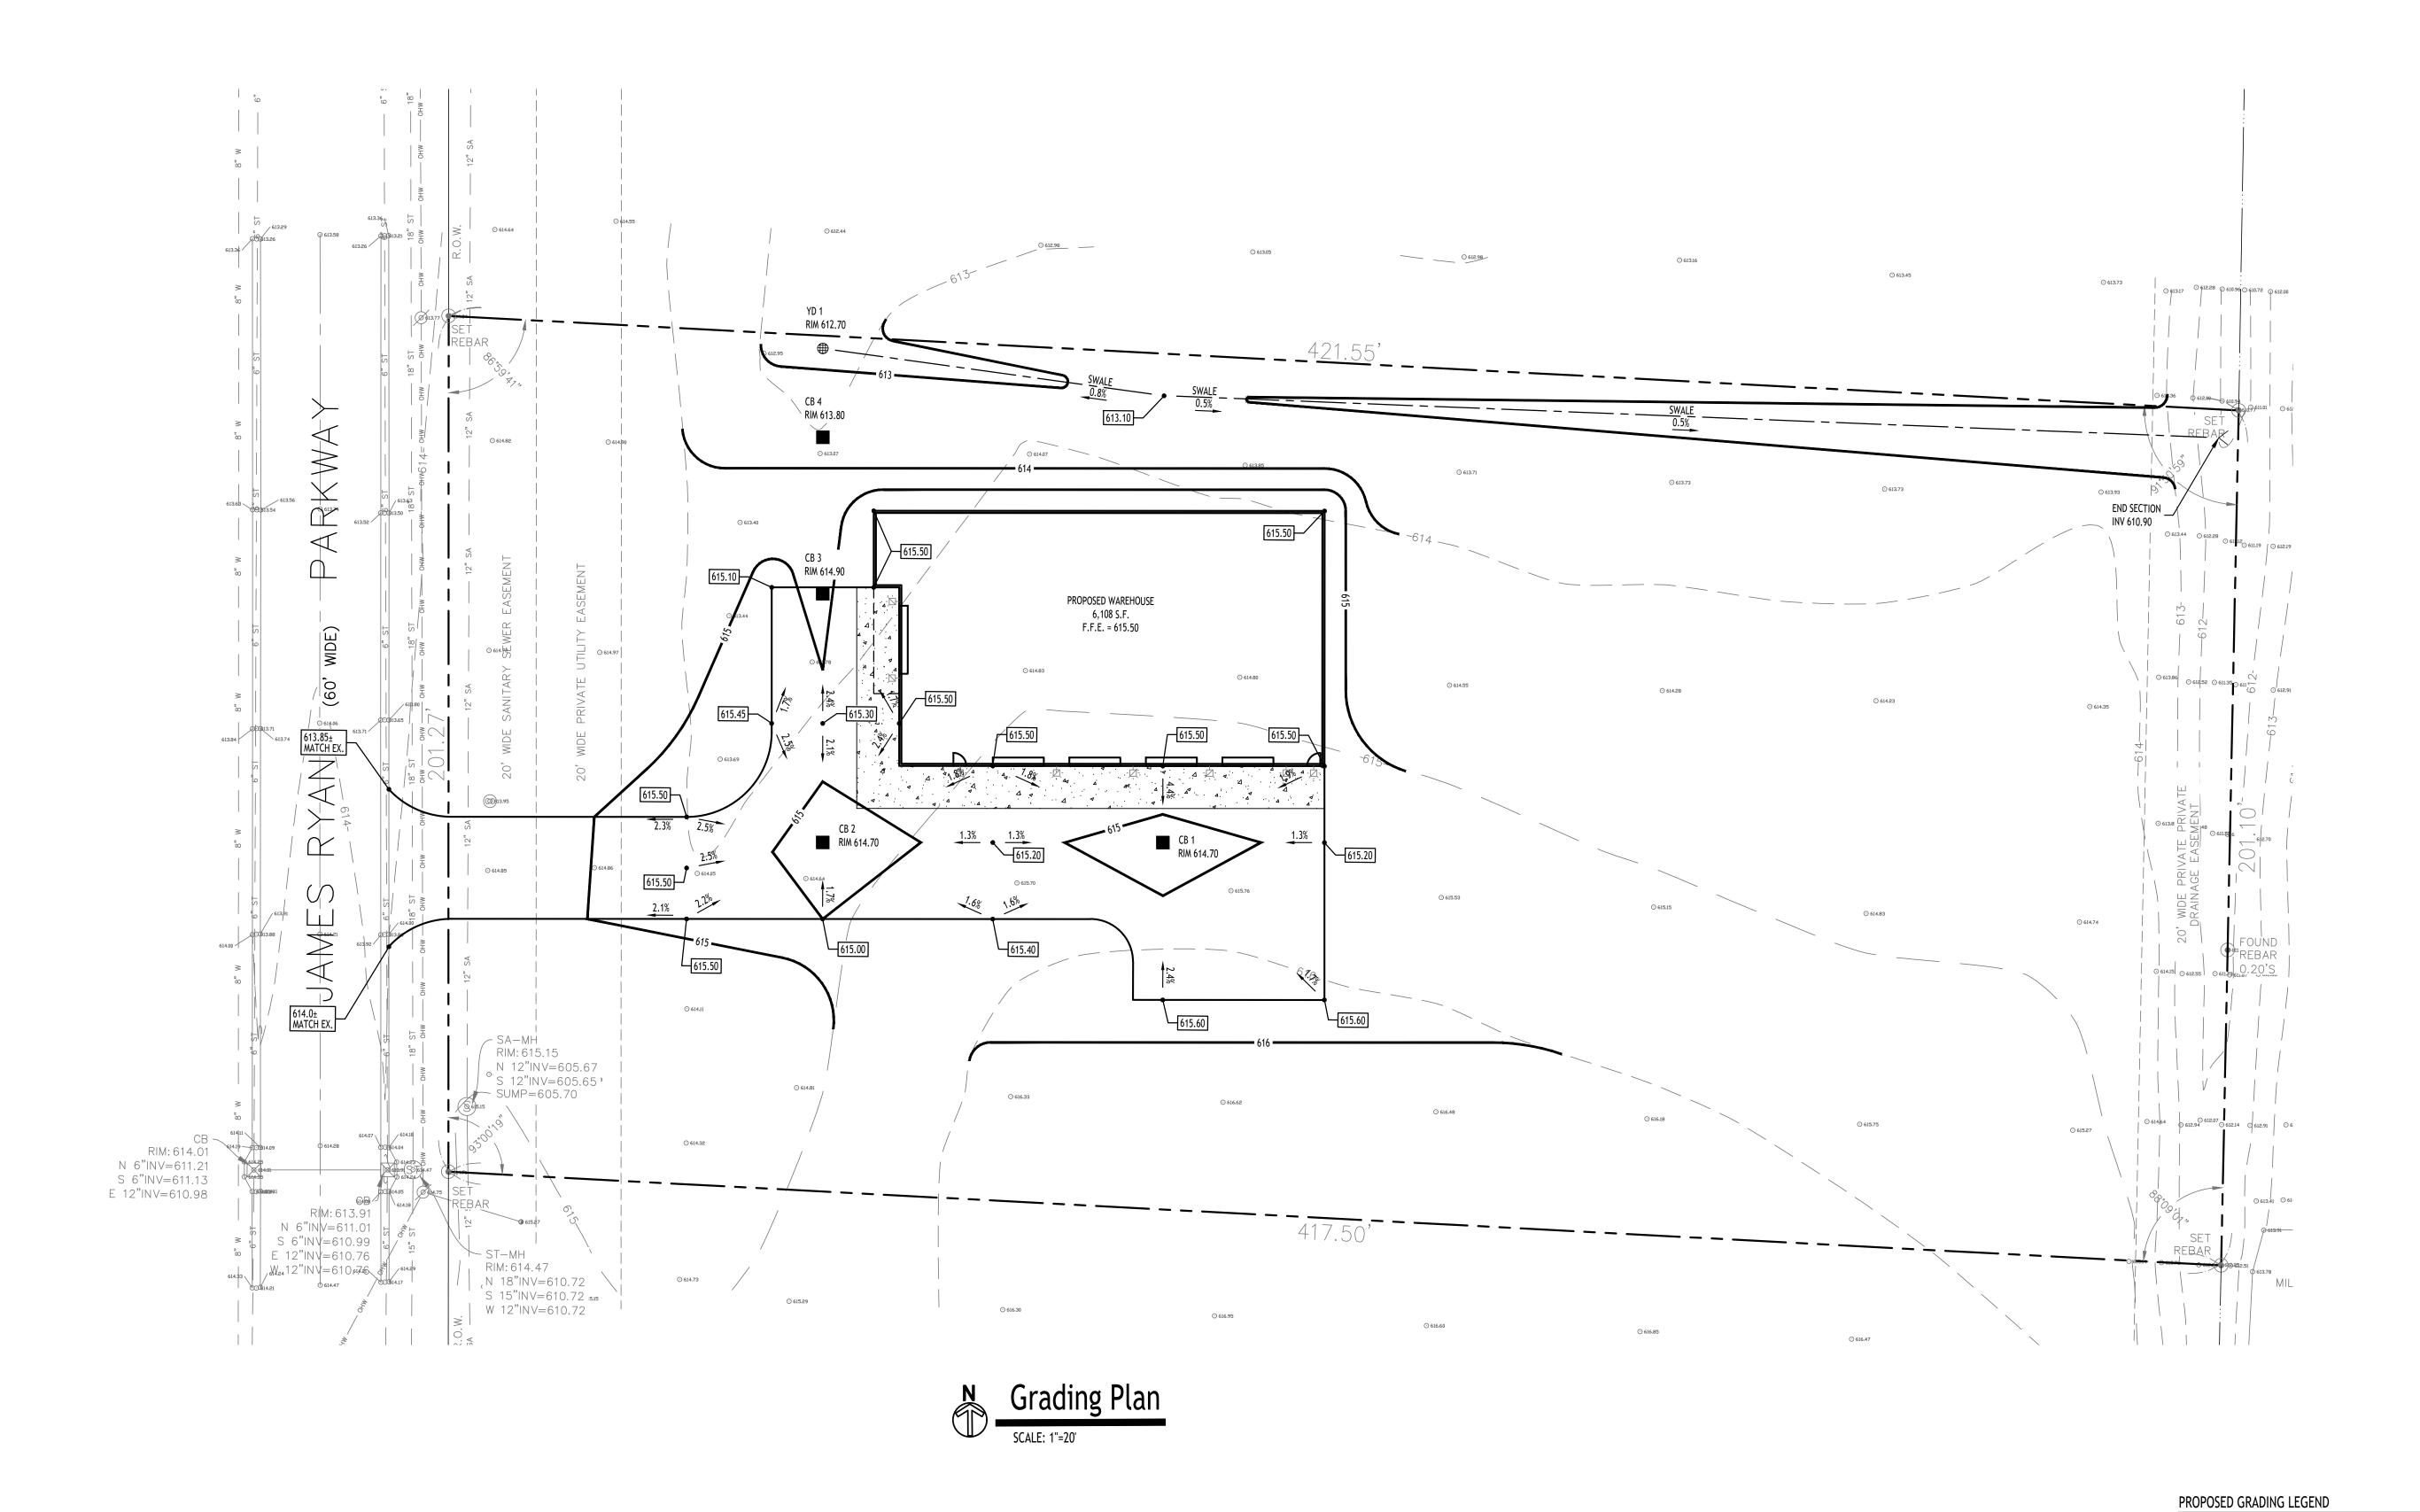



DRAWING NAME:

**——**101 **——** 

100.80

TC 100.50 BC 100.00

СВ

⊗ YD

MH

NOTE: BOUNDARY AND TOPOGRAPHIC INFORMATION PROVIDED BY OTHERS, CARMINA WOOD DESIGN ASSUMES NO RESPONSIBILITY FOR ITS ACCURACY.

PROPOSED CONTOUR

PROPOSED SPOT ELEVATION

PROPOSED CATCH BASIN

PAVEMENT/GROUND SLOPE

PROPOSED YARD DRAIN


PROPOSED MANHOLE

PROPOSED TOP/BOTTOM OF CURB ELEV.

**Grading Plan** 

2/25/25 A. Pandolfe As Noted Date: Drawn By: Scale:

DRAWING NO. <u>Project No:</u> 24-4137

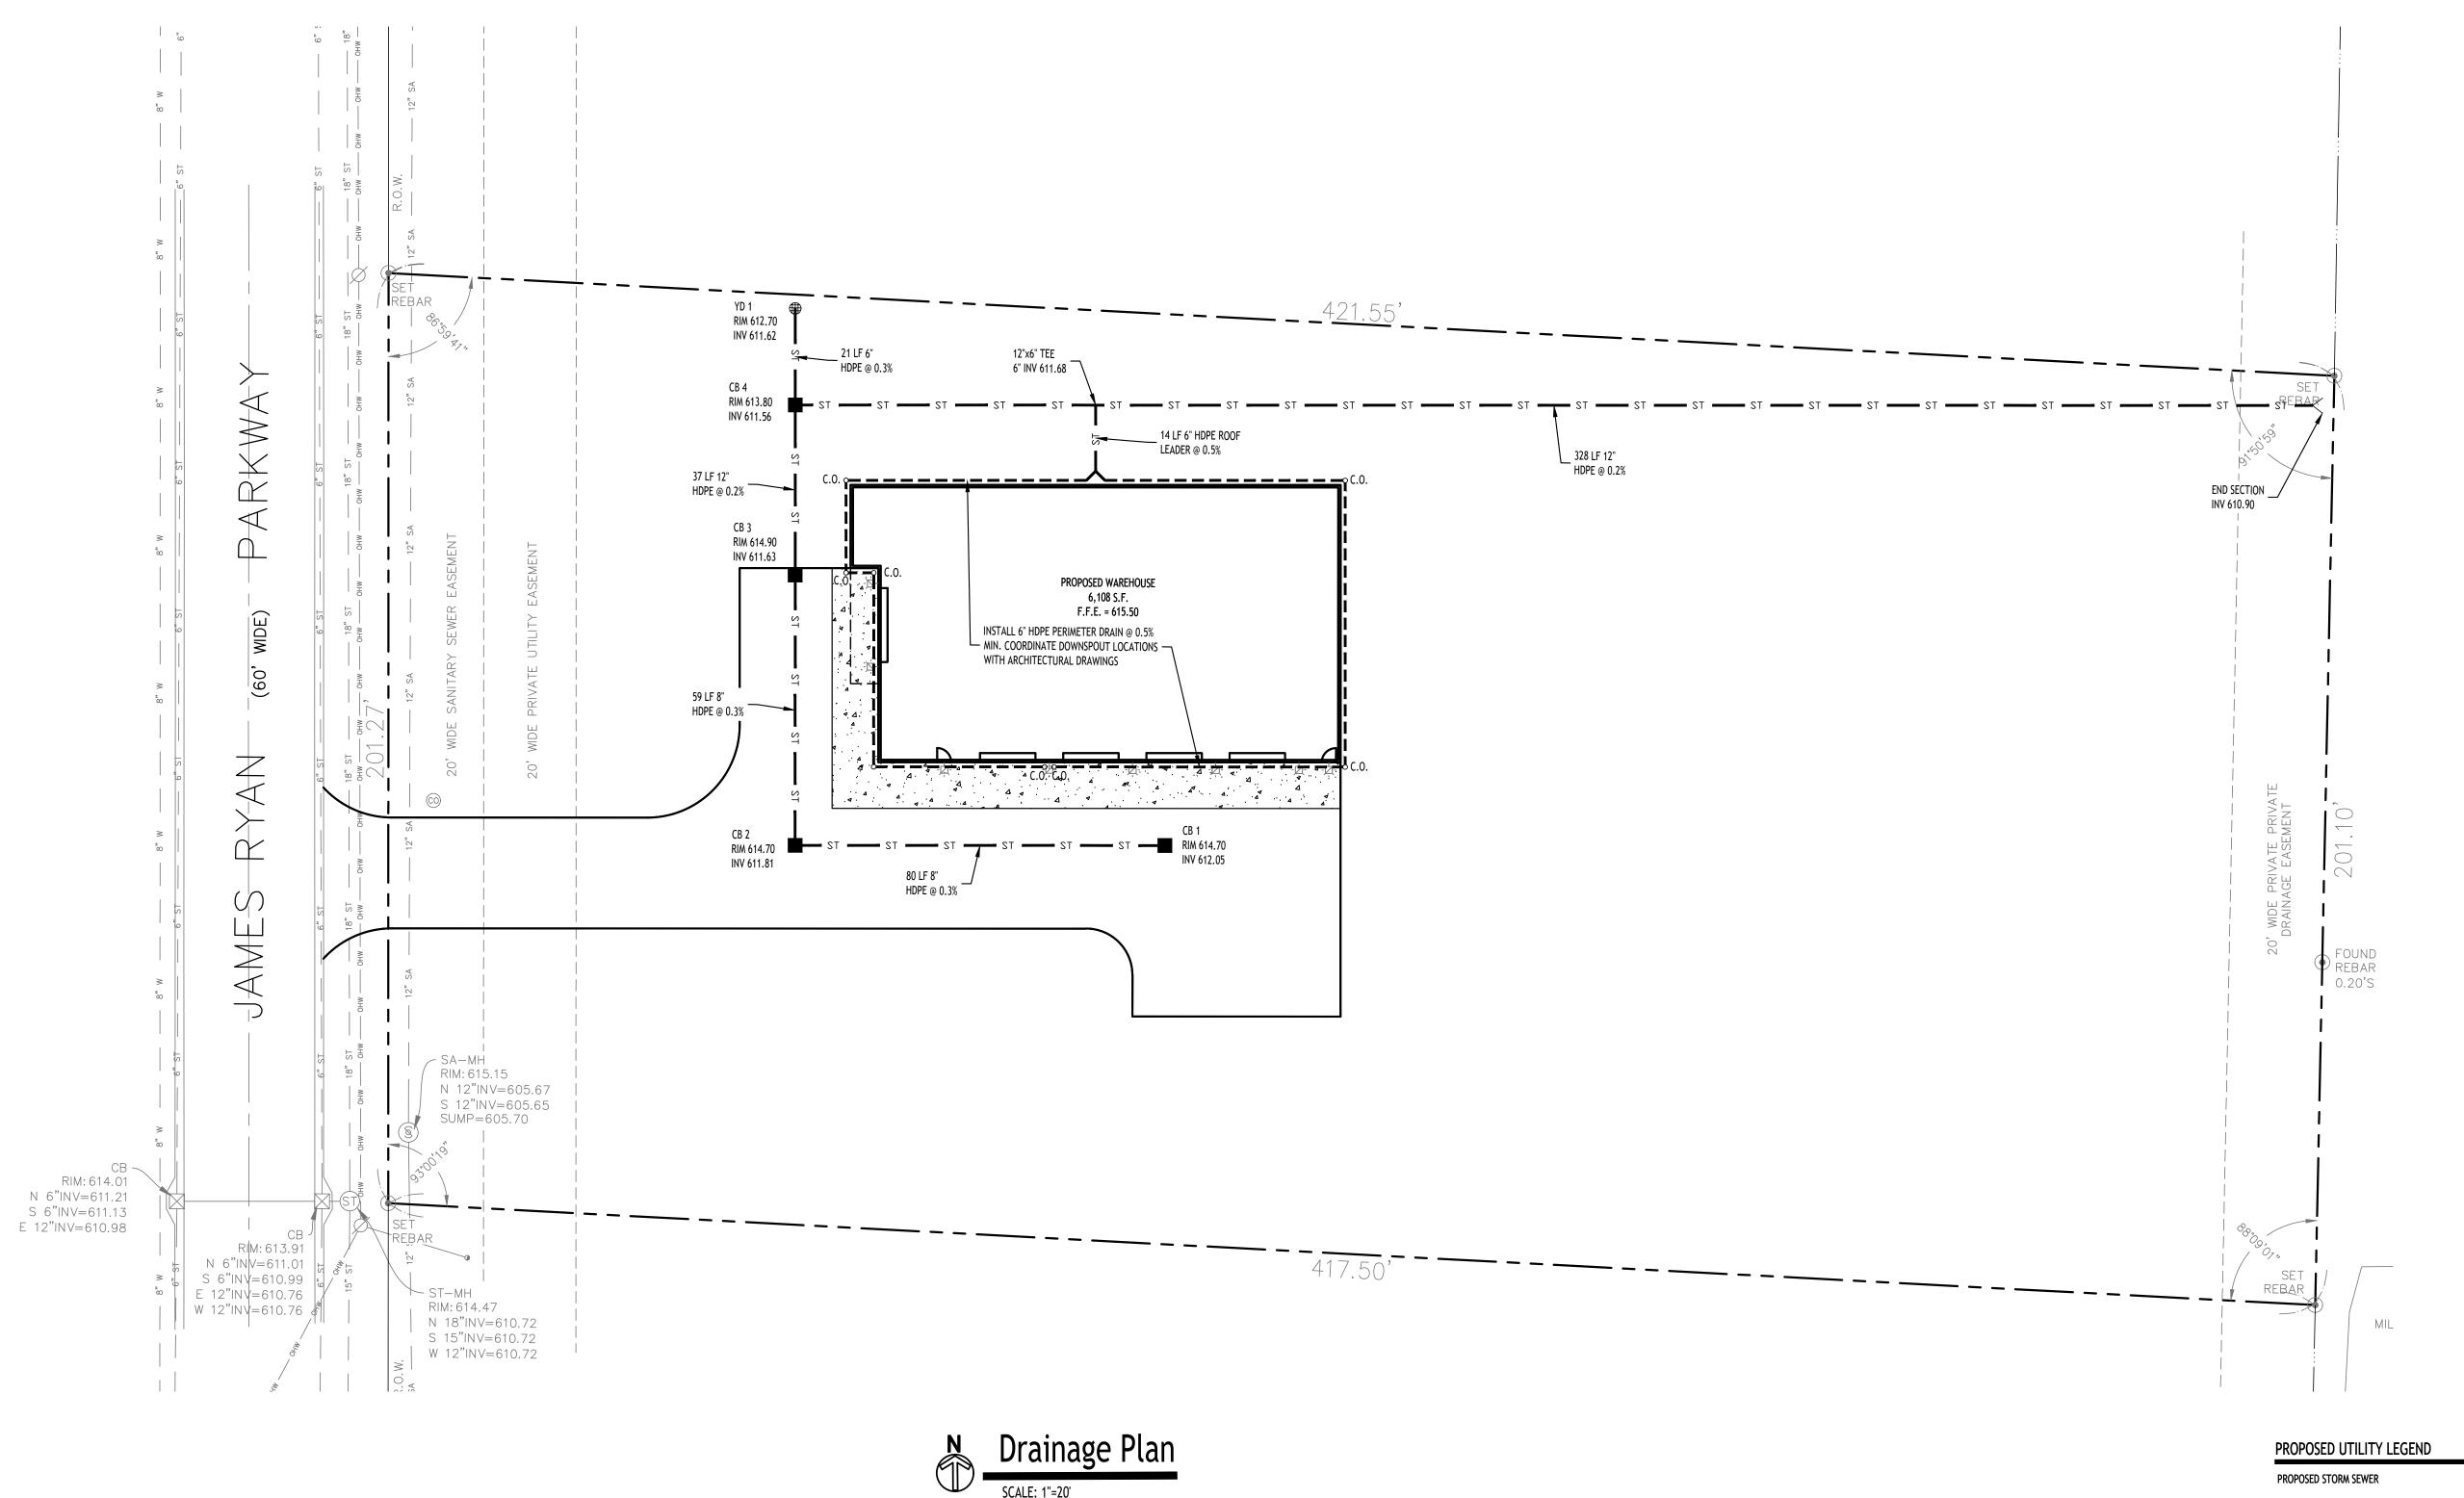

\_\_\_\_ ST \_\_\_\_ — 6" SA — PROPOSED SANITARY SEWER —\_1" W —\_ PROPOSED WATERLINE

■ CB PROPOSED CATCH BASIN PROPOSED YARD DRAIN ⊗ YD PROPOSED MANHOLE MH

PROPOSED HYDRANT ASSEMBLY PROPOSED GATE VALVE NOTE: FOR PROPOSED VALVE BOXES, CLEANOUTS, ETC., INSTALL A 3,000 PSI CONCRETE COLLAR AROUND THE ITEM AT GRADE. THE COLLAR SHALL BE A MINIMUM OF 6" WIDER, ON ALL SIDES, THAN THE BOX, CLEANOUT, ETC. THE COLLAR SHALL BE A MINIMUM OF 6" THICK.

NOTE: BOUNDARY AND TOPOGRAPHIC INFORMATION PROVIDED BY OTHERS, CARMINA WOOD DESIGN ASSUMES NO RESPONSIBILITY FOR ITS ACCURACY.

PRELIMINARY NOT FOR CONSTRUCTION

DRAWING NAME: Drainage Plan


Date: Drawn By: Scale:

2/25/25

A. Pandolfe

As Noted DRAWING NO.

<u>Project No:</u> 24-4137

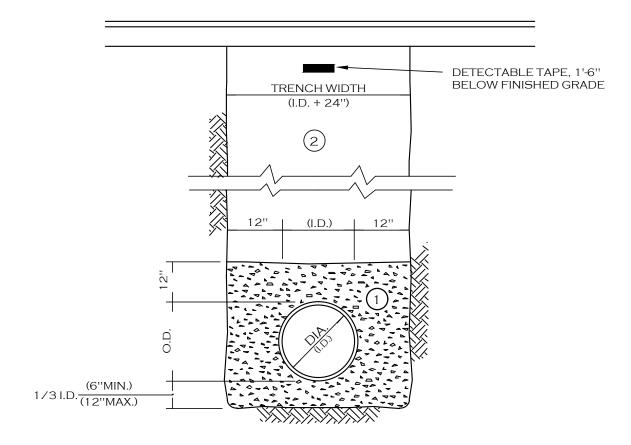

#### NOTES

- A. PIPE INSTALLATION SHALL BE IN ACCORDANCE WITH MANUFACTURERS RECOMMENDATIONS.
- B. TRENCHING OPERATIONS SHALL INCLUDE ALL NECESSARY DEWATERING.
- C. TRENCH DETAILS ARE ONLY SHOWN FOR PURPOSES OF MATERIAL PLACEMENT AND MAXIMUM PAY LIMITS.
- D. AN OSHA APPROVED MOVABLE PROTECTIVE TRENCH SHIELD SHALL BE USED IN ALL UNSHEETED TRENCH AREAS.

#### MATERIALS

#### PIPE BEDDING MATERIAL (NYSDOT 1985 EDITION)


NO. 1 CRUSHED STONE OR CRUSHED GRAVEL WITH A GRADATION CONFORMING WITH NYSDOT SECTION 703-02. THE MATERIAL SHALL BE WELL GRADED WITH NO PARTICLES LARGER THAN ONE INCH AND HAVING A MAXIMUM GRADATION MEETING THE LIMITS DESCRIBED IN THE SPECIFICATIONS. THE BEDDING SHALL BE COMPACTED IN 6" LIFTS WITH EQUIPMENT ACCEPTABLE TO THE PIPE MANUFACTURER.

#### NO SLAG SHALL BE ALLOWED FOR MATERIAL (1)

TYPE 2 CRUSHED STONE OR CRUSHED GRAVEL WITH A GRADATION CONFORMING WITH NYSDOT SECTION 304-2.02 TYPE 2. THE MATERAIL SHALL BE WELL GRADED WITH NO PARTICLES LARGER THAN TWO INCHES AND HAVING A MAXIMUM GRADATION MEETING THE LIMITS DESCRIBED IN THE SPECIFICATIONS. THE BEDDING SHALL BE COMPACTED IN 6" LIFTS WITH EQUIPMENT ACCEPTABLE TO THE PIPE MANUFACTURER.

NO SLAG SHALL BE ALLOWED FOR MATERIAL 2

# STORM SEWER TRENCH SECTION IN PAVED AREAS

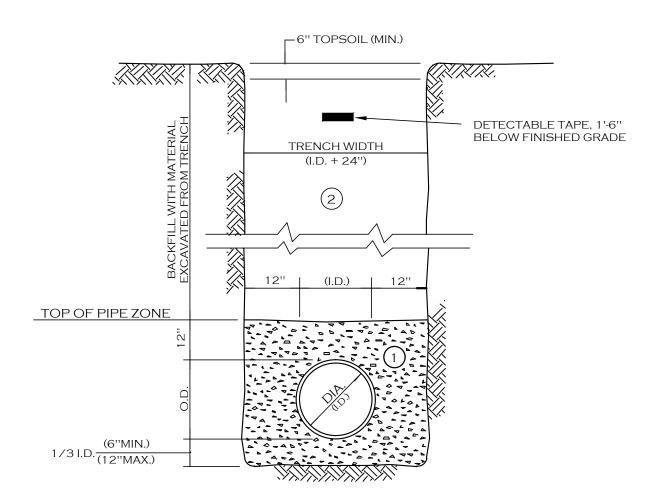

#### NOTES:

- A. PIPE INSTALLATION SHALL BE IN ACCORDANCE WITH MANUFACTURERS RECOMMENDATIONS.
- B. TRENCHING OPERATIONS SHALL INCLUDE ALL NECESSARY DEWATERING.
- C. TRENCH DETAILS ARE ONLY SHOWN FOR PURPOSES OF MATERIAL PLACEMENT AND MAXIMUM PAY LIMITS.
- D. AN OSHA APPROVED MOVABLE PROTECTIVE TRENCH SHIELD SHALL BE USED IN ALL UNSHEETED TRENCH AREAS.

#### <u>MATERIALS</u>


#### PIPE BEDDING MATERIAL (NYSDOT 1985 EDITION)

NO. 1 CRUSHED STONE OR CRUSHED GRAVEL WITH A GRADATION CONFORMING WITH NYSDOT SECTION 703-02. THE MATERIAL SHALL BE WELL GRADED WITH NO PARTICLES LARGER THAN ONE INCH AND HAVING A MAXIMUM GRADATION MEETING THE LIMITS DESCRIBED IN THE SPECIFICATIONS. THE BEDDING SHALL BE COMPACTED IN 6" LIFTS WITH EQUIPMENT ACCEPTABLE TO THE PIPE MANUFACTURER.


NO SLAG SHALL BE ALLOWED FOR MATERIAL 1

BACKFILL MATERIAL SHALL BE NATIVE SOIL CONTAINING NO UNSUITABLE MATERIAL COMPACTED IN 6" LIFTS.

# STORM SEWER TRENCH SECTION IN UNPAVED AREAS

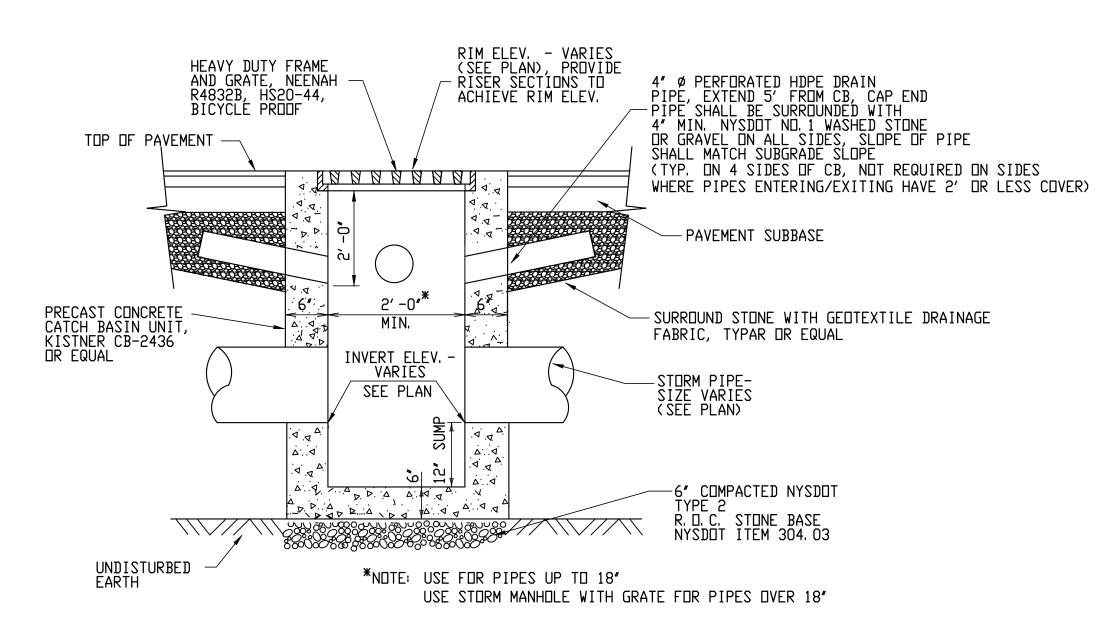


TYPICAL PRECAST CATCH BASIN

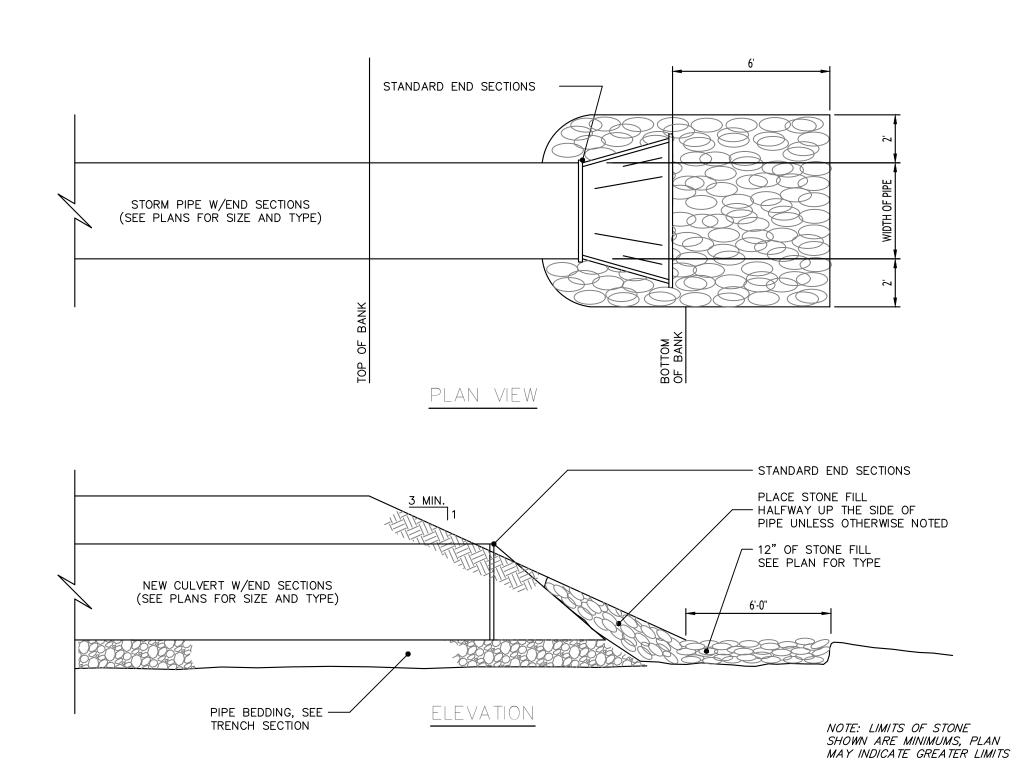


TYPICAL PIPE OUTLET W/END SECTION & RIP RAP

NOT TO SCALE

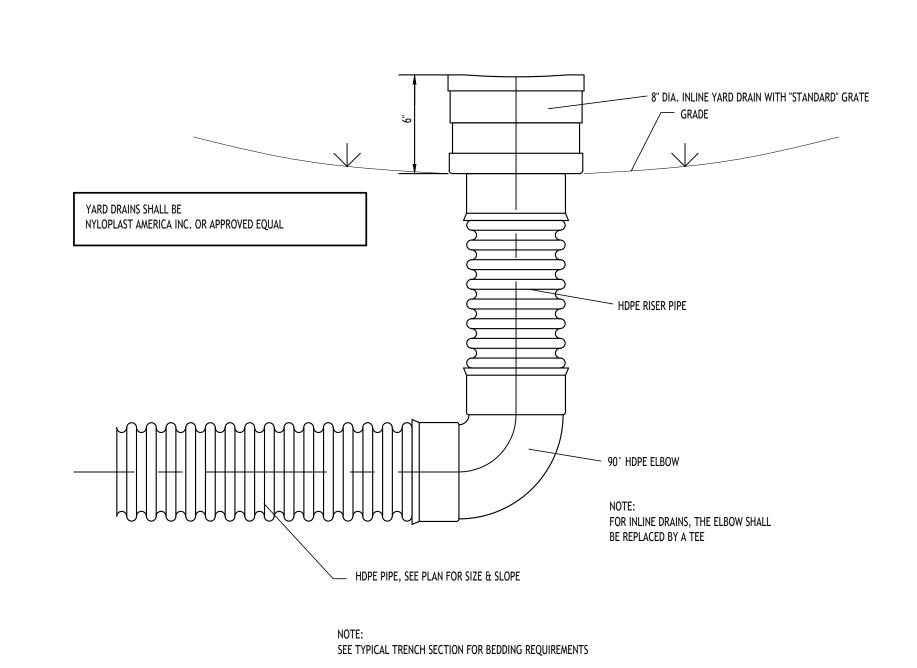

TYPICAL BIORETENTION YARD DRAIN DETAIL



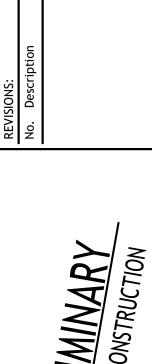

DRAWING NAME:


Drainage Details


Date:
Drawn By:
Scale:
DRAWING NO.


C-301

6/11/25

A. Pandolfe
As Noted

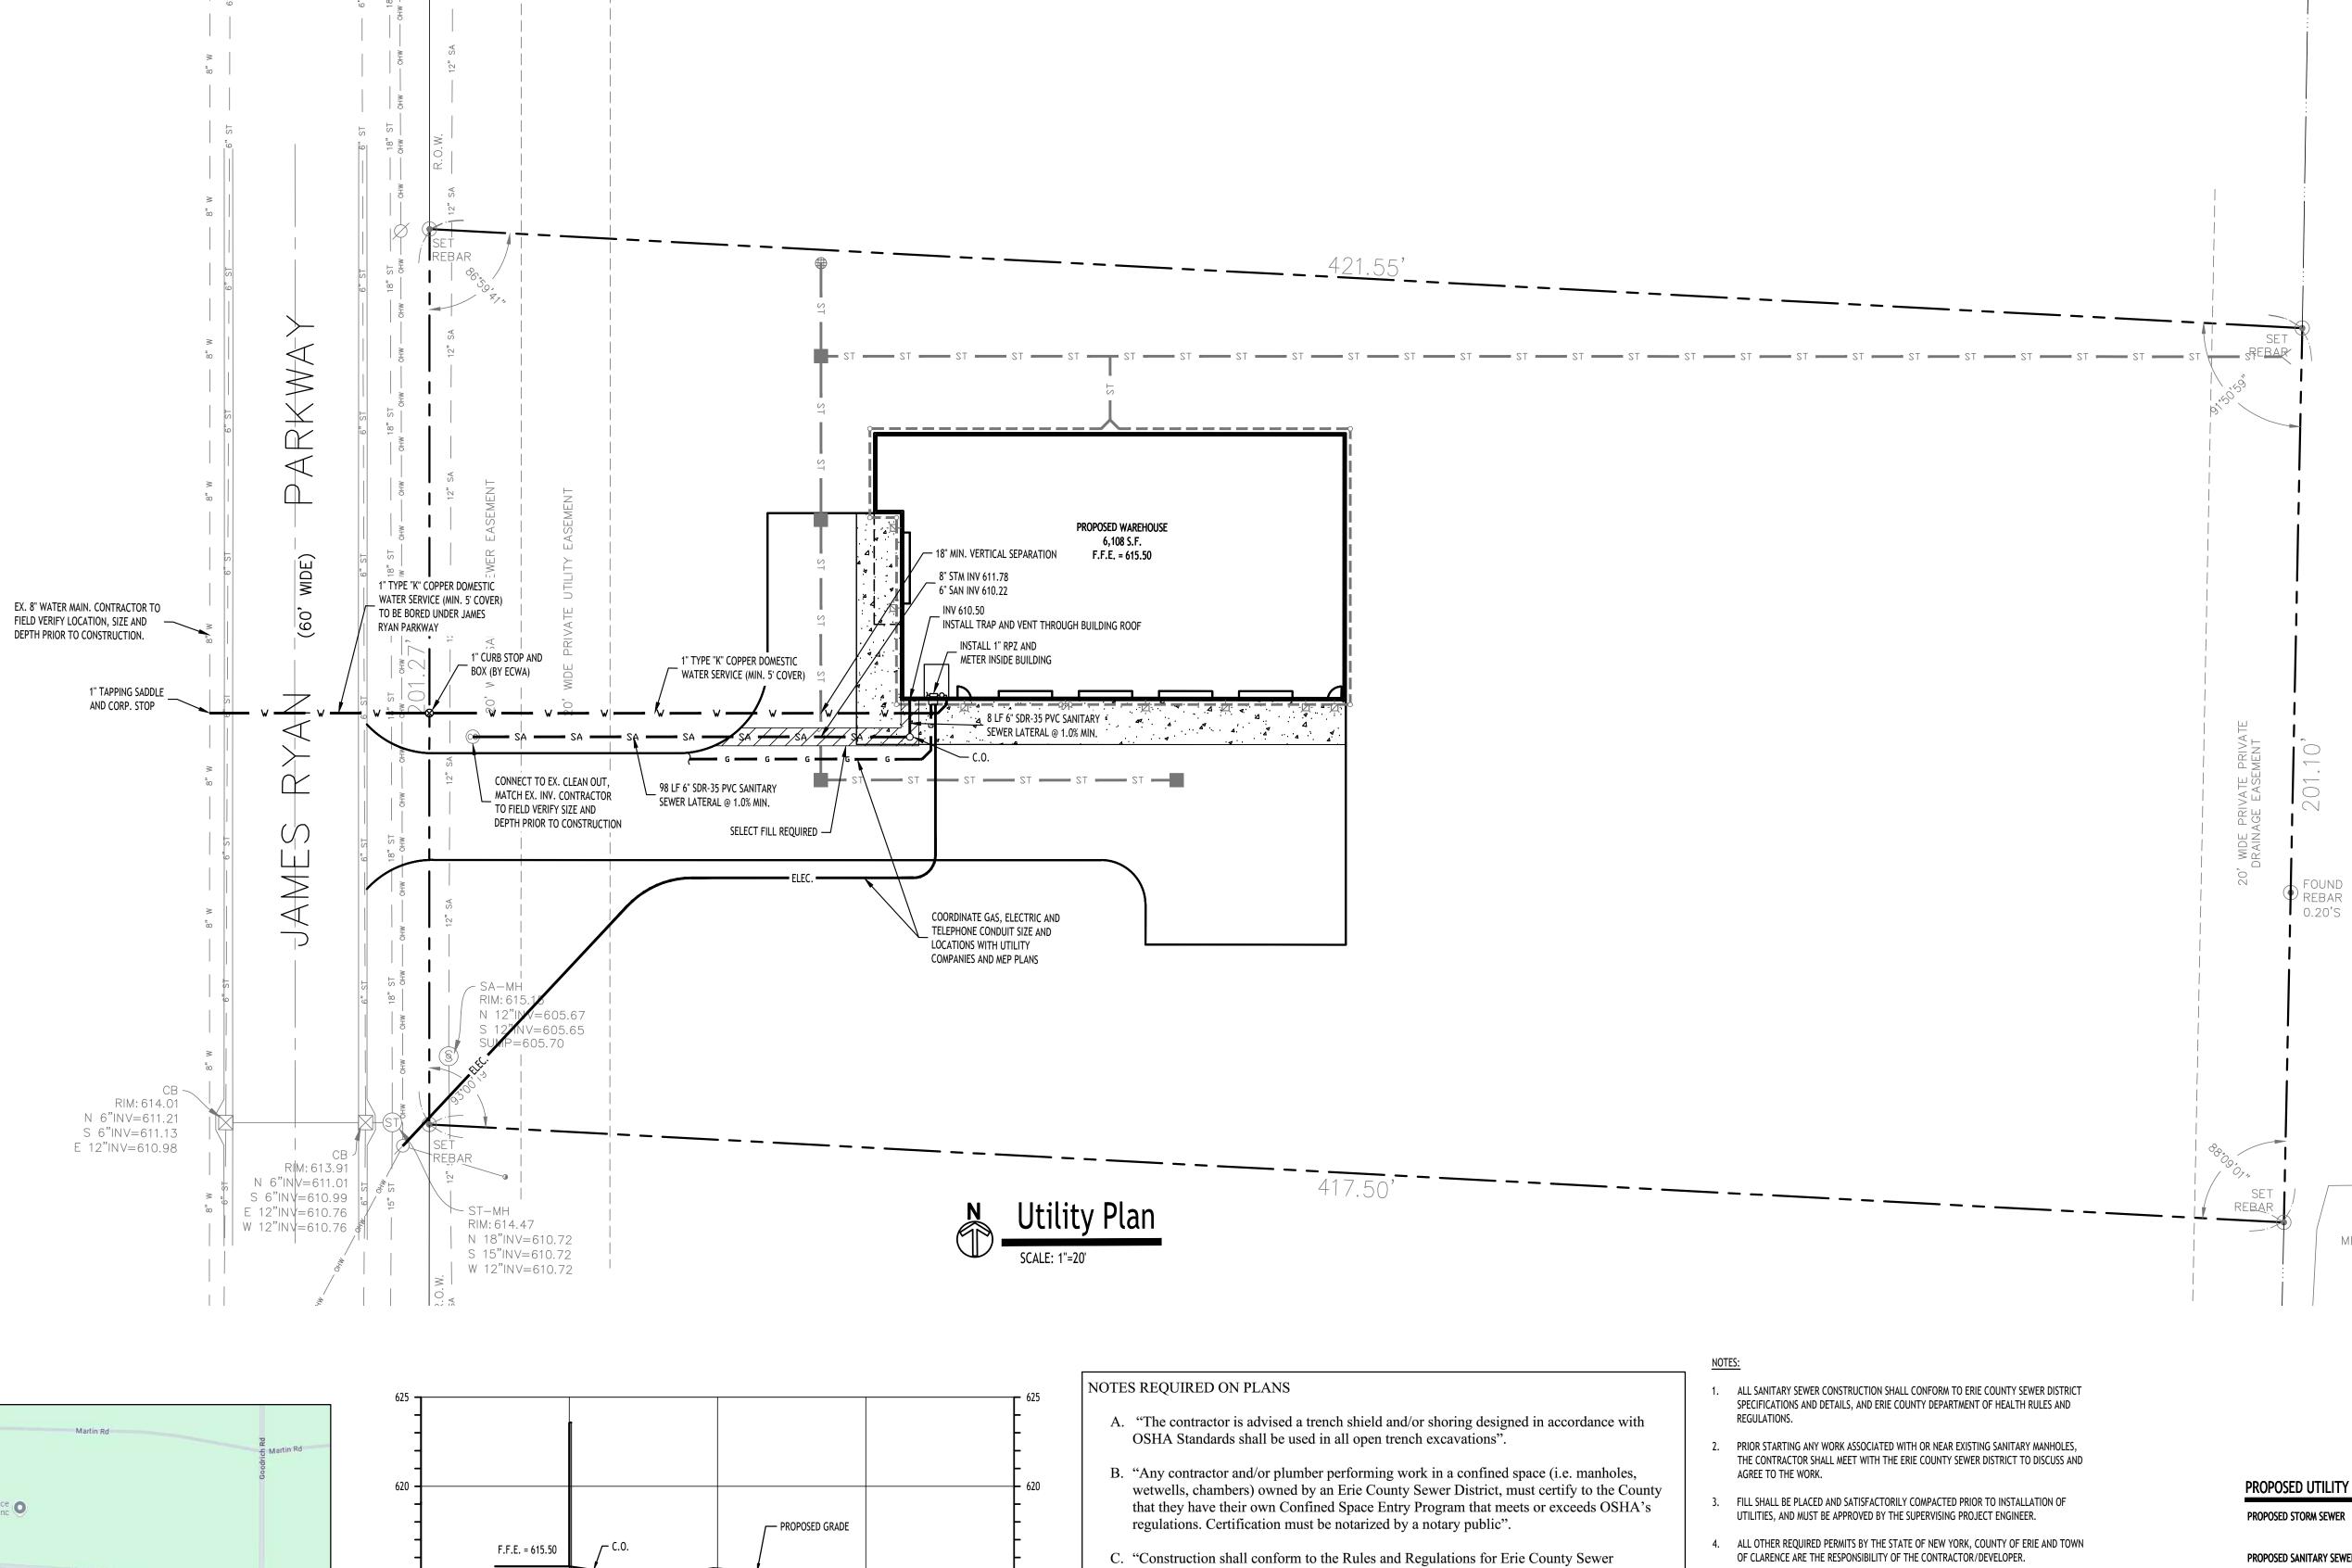

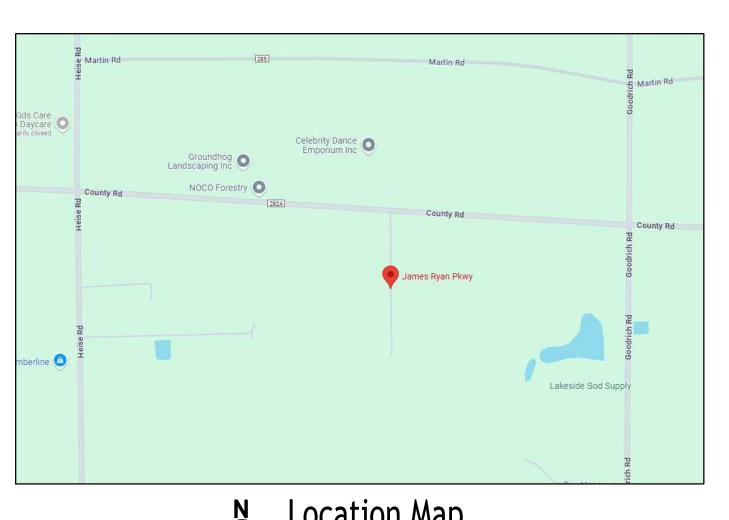

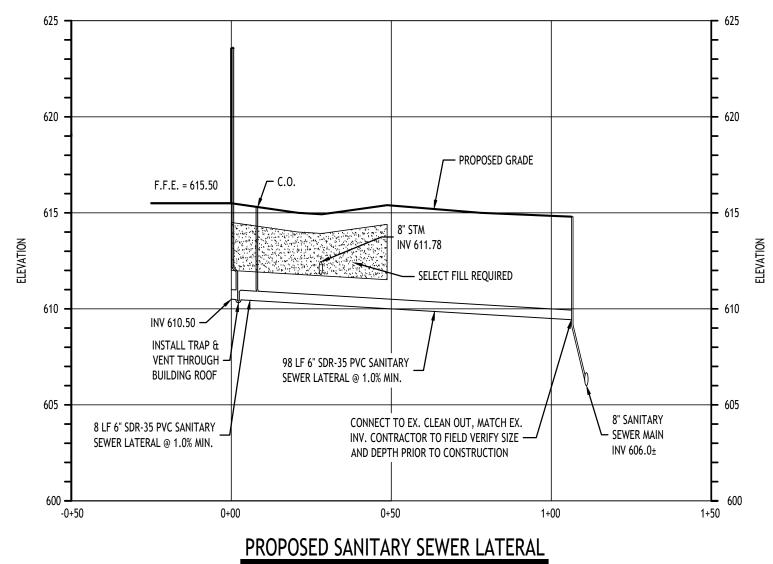

SCALE: HORIZ. 1"=30'

- D. If any proposed sewer lateral runs under paved area and has **less** than four (4) feet of cover, then concrete encasement is required. Attach Detail No. 6 to plans. On site plan and profile hatchmark and/or label "concrete encasement" in affected areas.

If any proposed sewer lateral runs under paved area and has more than four (4) feet of cover, then on site plan and profile hatchmark and label, "select fill required" in affected

- E. The contractor must contact the District Office 48 hours in advance of construction.
- F. Vents must be installed six (6) inches above grade, in a grassy area with a mushroom cap. If the vent is in a sidewalk or paved area, then protect with bollards (3 minimum).
- G. Cleanouts (c.o) are required every one hundred feet (100') and at change of direction.
- H. Abandoned sanitary sewer connections from the site, if any, require proof of a District Permit for Disconnection prior to the new connection being made.
- I. Reuse of existing building sewers shall conform to the Rules and Regulations for ECSD, Article III, Section 304.

#### UTILITY NOTES:

- 1. FOR ALL SANITARY SEWERS, INSTALL SELECT FILL IN PAVED AREAS, EXTEND 5' MIN. BEYOND PAVEMENT LIMITS
- 2. BUILDINGS TO HAVE A 6" HOUSE TRAP, VENT AND CLEANOUT INSTALLED AT ENTRANCE POINT. INVERT ELEVATION TO BE 5' MIN. BELOW F.F.E. OF THE BUILDING. PIPE TO BE 6" SDR-35 PVC @ 1.0% MIN WITH MIN 4' OF COVER. ADD ADDITIONAL CLEANOUTS @ 100' MAX. SPACING FOR 6" LATERALS OVER 100' IN LENGTH.
- 3. COORDINATE GAS & ELEC. METER BANK LOCATIONS ON BUILDINGS WITH M.E.P. PLANS & UTILITY CO.'S.
- 4. COORDINATE LOCATION OF CTV & TELEPHONE SERVICE TO BUILDINGS WITH M.E.P. PLANS AND UTILITY CO.'S.
- 5. ANY EXISTING UTILITIES WHICH ARE TO BE ABANDONED AND FALL UNDER PAVEMENT OR BUILDINGS SHALL BE REMOVED VS. BEING ABANDONED UNLESS THOSE UTILITIES ARE FILLED WITH FLOWABLE FILL.
- 6. EXISTING GAS SERVICES TO REMAIN UNLESS OTHERWISE NOTED. ANY PORTIONS TO BE RELOCATED SHALL BE COORDINATED WITH NATIONAL FUEL GAS.
- 7. ALL UNDERGROUND TELEPHONE SERVICES SHALL REMAIN AND BE PROTECTED DURING CONSTRUCTION.
- 8. A MINIMUM OF 10 FEET HORIZONTAL AND 18 INCHES OF VERTICAL SEPARATION MUST BE MAINTAINED BETWEEN ALL SANITARY SEWER AND WATER SERVICES.
- 9. ERIE COUNTY WATER AUTHORITY (ECWA) IS TO BE NOTIFIED A MINIMUM OF 48-HOURS PRIOR TO STARTING THE CONNECTION TO THE NEW WATER SERVICE.
- 10. SELECT BACKFILL IS REQUIRED FOR ALL UTILITIES (GAS, WATER, STORM, SANITARY) THAT CROSS THROUGH PAVEMENT AREAS.

| PROPOSED UTILITY LEGEND   | _             |
|---------------------------|---------------|
| PROPOSED STORM SEWER      | <b>—</b> ST — |
| PROPOSED SANITARY SEWER   | —— 6" SA ——   |
| PROPOSED WATERLINE        | —1" W —       |
| PROPOSED CATCH BASIN      | ■ СВ          |
| PROPOSED YARD DRAIN       | ⊗ YD          |
| PROPOSED MANHOLE          | ● MH          |
| PROPOSED HYDRANT ASSEMBLY |               |

NOTE: FOR PROPOSED VALVE BOXES, CLEANOUTS, ETC., INSTALL A 3,000 PSI CONCRETE COLLAR AROUND THE ITEM AT GRADE. THE COLLAR SHALL BE A MINIMUM OF 6" WIDER, ON ALL SIDES, THAN THE BOX, CLEANOUT, ETC. THE COLLAR SHALL BE A MINIMUM OF 6" THICK.

PROPOSED GATE VALVE

NOTE: BOUNDARY AND TOPOGRAPHIC INFORMATION PROVIDED BY OTHERS,

CARMINA WOOD DESIGN ASSUMES NO RESPONSIBILITY FOR ITS ACCURACY.

PRELIMINARY NOT FOR CONSTRUCTION

DRAWING NAME: **Utility Plan** 

Drawn By:

6/11/25

A. Pandolfe

Scale: As Noted DRAWING NO.

**−**6" TOPSOIL (MIN.)

A. PIPE INSTALLATION SHALL BE IN ACCORDANCE WITH MANUFACTURERS

- B. TRENCHING OPERATIONS SHALL INCLUDE ALL NECESSARY DEWATERING.
- C. TRENCH DETAILS ARE ONLY SHOWN FOR PURPOSES OF MATERIAL PLACEMENT AND MAXIMUM PAY LIMITS.
- D. AN OSHA APPROVED MOVABLE PROTECTIVE TRENCH SHIELD SHALL BE USED IN ALL UNSHEETED TRENCH AREAS.


#### **MATERIALS**

PIPE BEDDING MATERIAL (NYSDOT LATEST EDITION) NO.1 CRUSHED STONE WITH A GRADATION CONFORMING WITH NYSDOT SECTION 703-02. THE CRUSHED STONE SHALL BE WELL GRADED WITH NO PARTICLES LARGER THAN 1" AND HAVING A MAXIMUM GRADATION MEETING THE LIMITS DESCRIBED IN THE SPECIFICATIONS. THE BEDDING SHALL BE COMPACTED IN 6" LIFTS WITH EQUIPMENT ACCEPTABLE TO THE PIPE MANUFACTURER.

#### SELECT MATERIAL BACKFILL (NYSDOT LATEST EDITION)

NO.2 RUN OF CRUSHER STONE OR NO.2 RUN OF CRUSHER GRAVEL WITH A GRADATION CONFORMING WITH NYSDOT SECTION 304-2.02 TYPE 4 AND NYSDOT SECTION 703-02. (COMPACTED IN 6"LIFTS TO 90% NOTE: SLAG SHALL NOT BE ALLOWED FOR MATERIALS (1) AND (2)

> **UTILITY TRENCH SECTION IN UNPAVED AREAS**

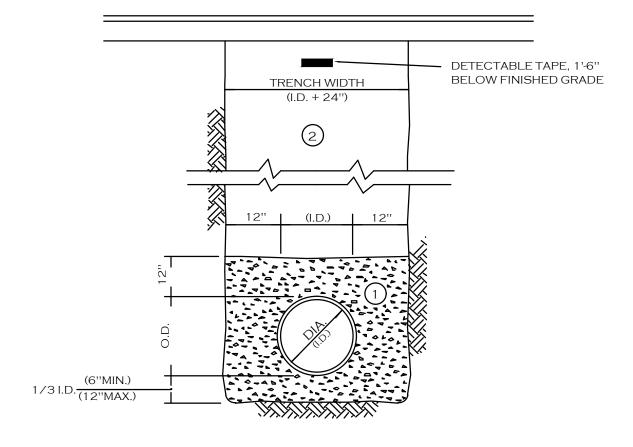

A. PIPE INSTALLATION SHALL BE IN ACCORDANCE WITH MANUFACTURERS RECOMMENDATIONS

- B, TRENCHING OPERATIONS SHALL INCLUDE ALL NECESSARY DEWATERING. C. TRENCH DETAILS ARE ONLY SHOWN FOR PURPOSES OF MATERIAL PLACEMENT AND MAXIMUM PAY LIMITS.
- D. AN OSHA APPROVED MOVABLE PROTECTIVE TRENCH SHIELD SHALL BE USED IN ALL UNSHEETED TRENCH AREAS.


#### **MATERIALS**


PIPE BEDDING MATERIAL (NYSDOT LATEST EDITION) 1 NO.1 CRUSHED STONE WITH A GRADATION CONFORMING WITH NYSDOT SECTION 703-02. THE CRUSHED STONE SHALL BE WELL GRADED WITH NO PARTICLES LARGER THAN 1" AND HAVING A MAXIMUM GRADATION MEETING THE LIMITS DESCRIBED IN THE SPECIFICATIONS. THE BEDDING SHALL BE COMPACTED IN 6" LIFTS WITH EQUIPMENT ACCEPTABLE TO THE PIPE MANUFACTURER.


NO.2 RUN OF CRUSHER STONE OR NO.2 RUN OF CRUSHER GRAVEL WITH A GRADATION CONFORMING WITH NYSDOT SECTION 304-2.02 TYPE 4 AND NYSDOT SECTION 703-02. (COMPACTED IN 6"LIFTS TO 90% DENSITY)


NOTE: SLAG SHALL NOT BE ALLOWED FOR MATERIALS 1 AND 2

**UTILITY TRENCH SECTION IN PAVED AREAS** 

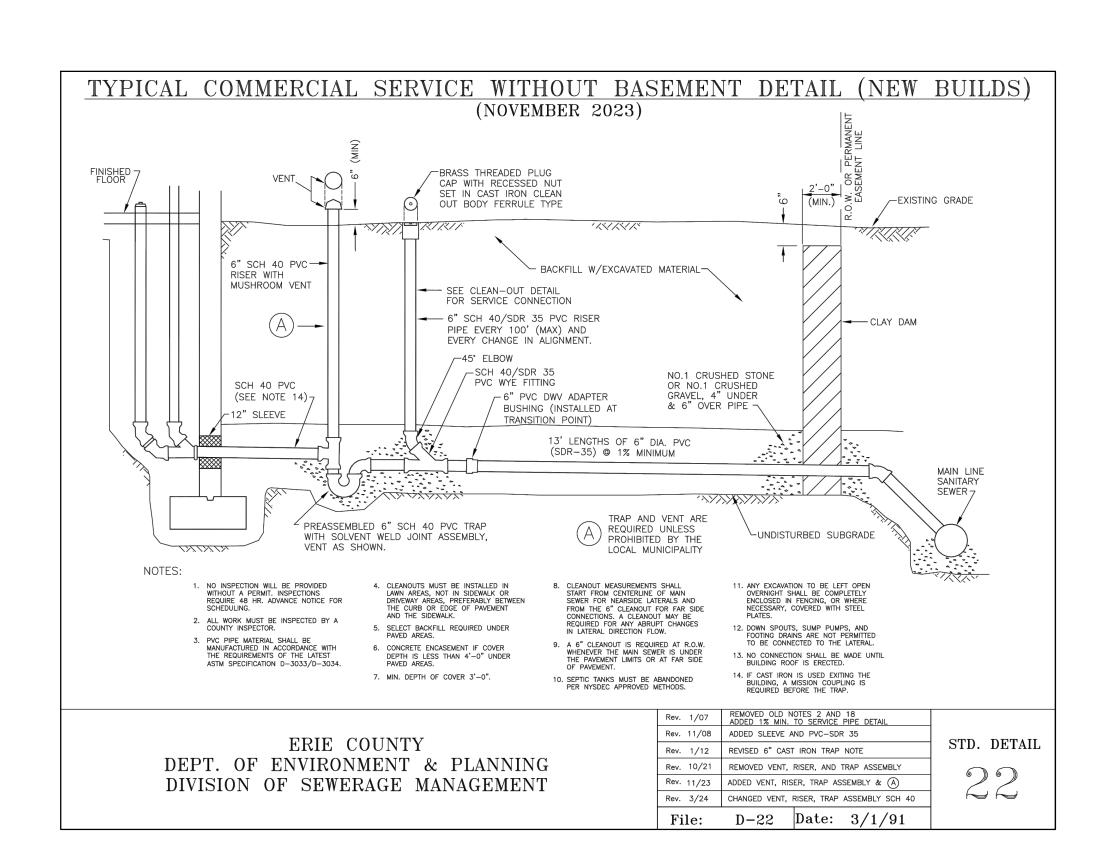


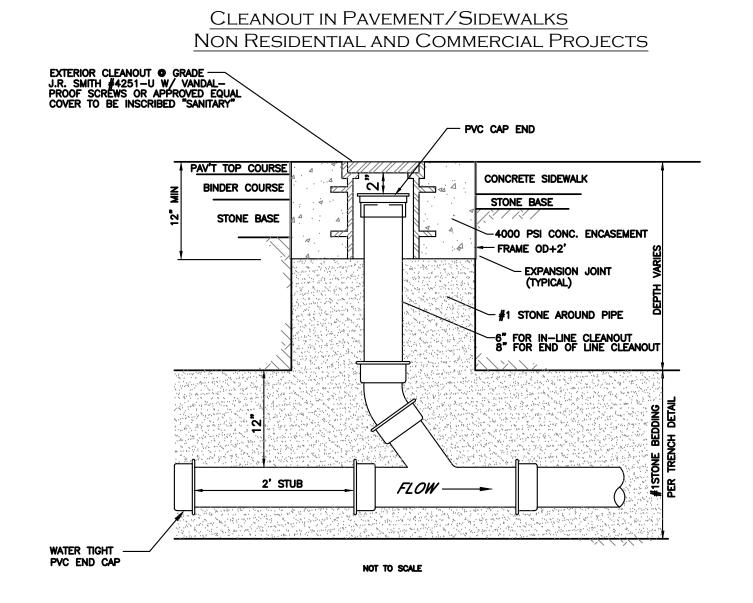

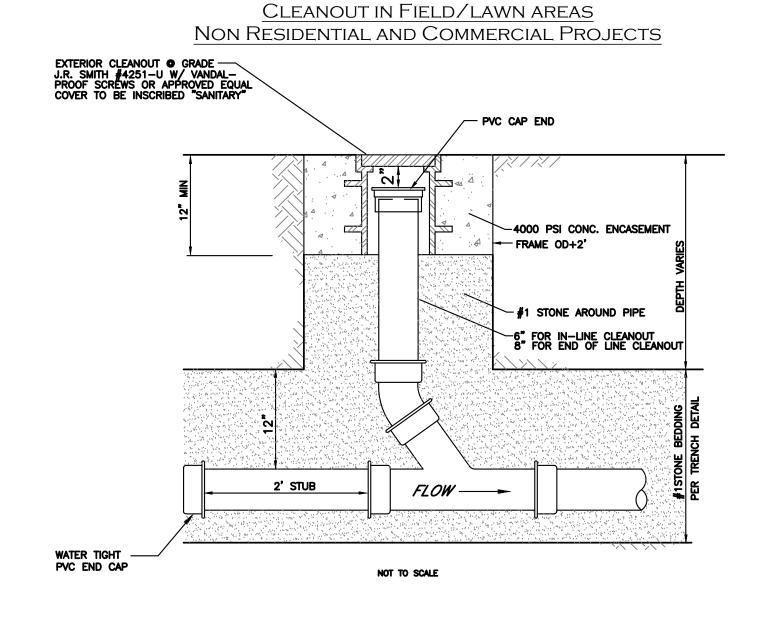

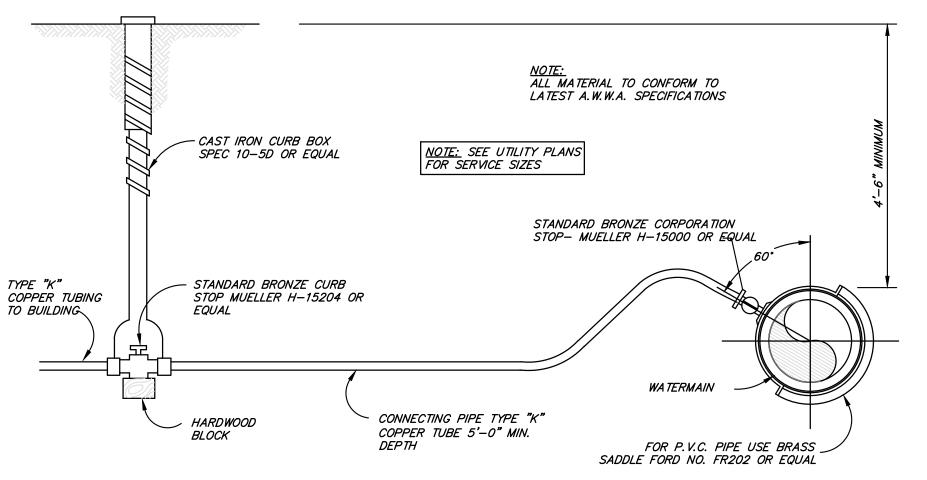

TYPICAL WATER SERVICE LINE INSTALLATION

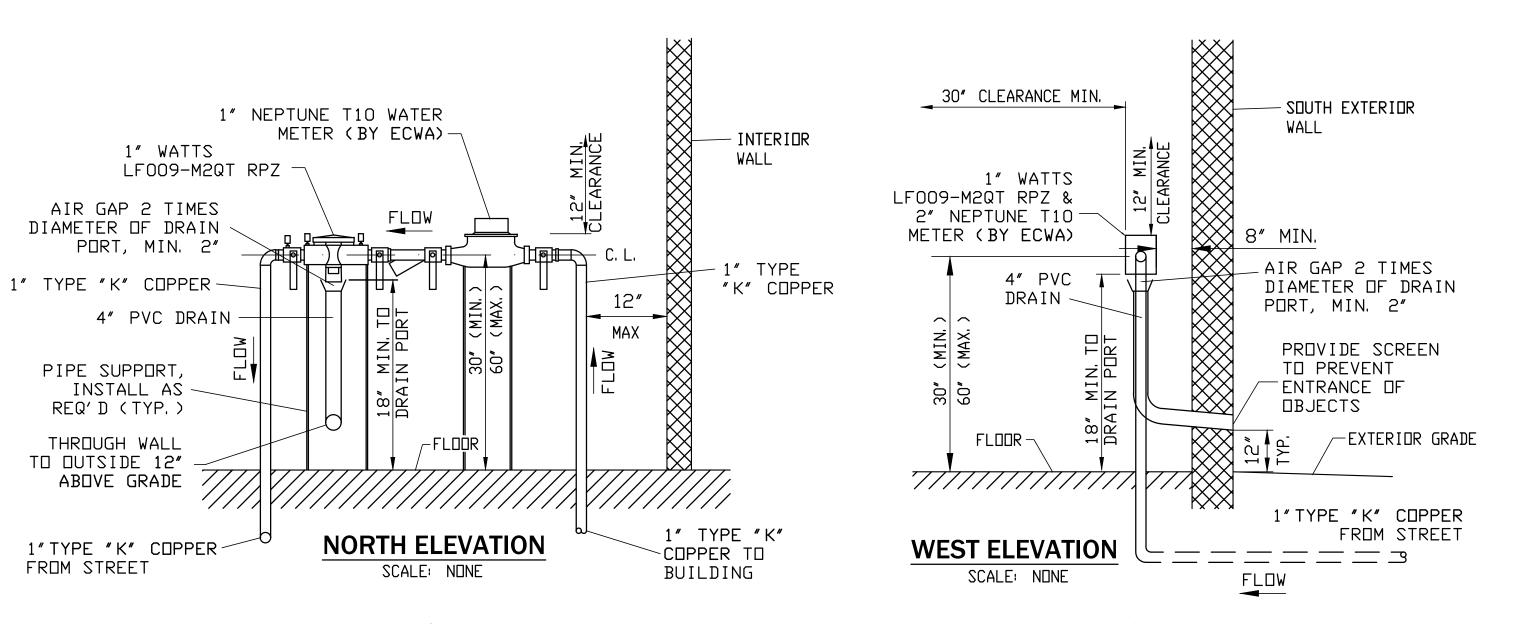

#### 1" DOMESTIC SERVICE BACKFLOW PREVENTER INSTALLATION

SCALE: NONE

1. NO TAPS TO BE MADE UPSTREAM OF RPZ & METER.

2. HEAT, LIGHT AND ELECTRIC TO BE PROVIDED AT RPZ LOCATION. 3. COORDINATE LOCATION WITH ARCHITECTURAL PLANS.

**Utility Details** 

DRAWING NAME:


PRELIMINARY NOT FOR CONSTRUCTION

Date: Drawn By: A. Pandolfe Scale: DRAWING NO.

6/11/25

As Noted

Project No: 24-4137

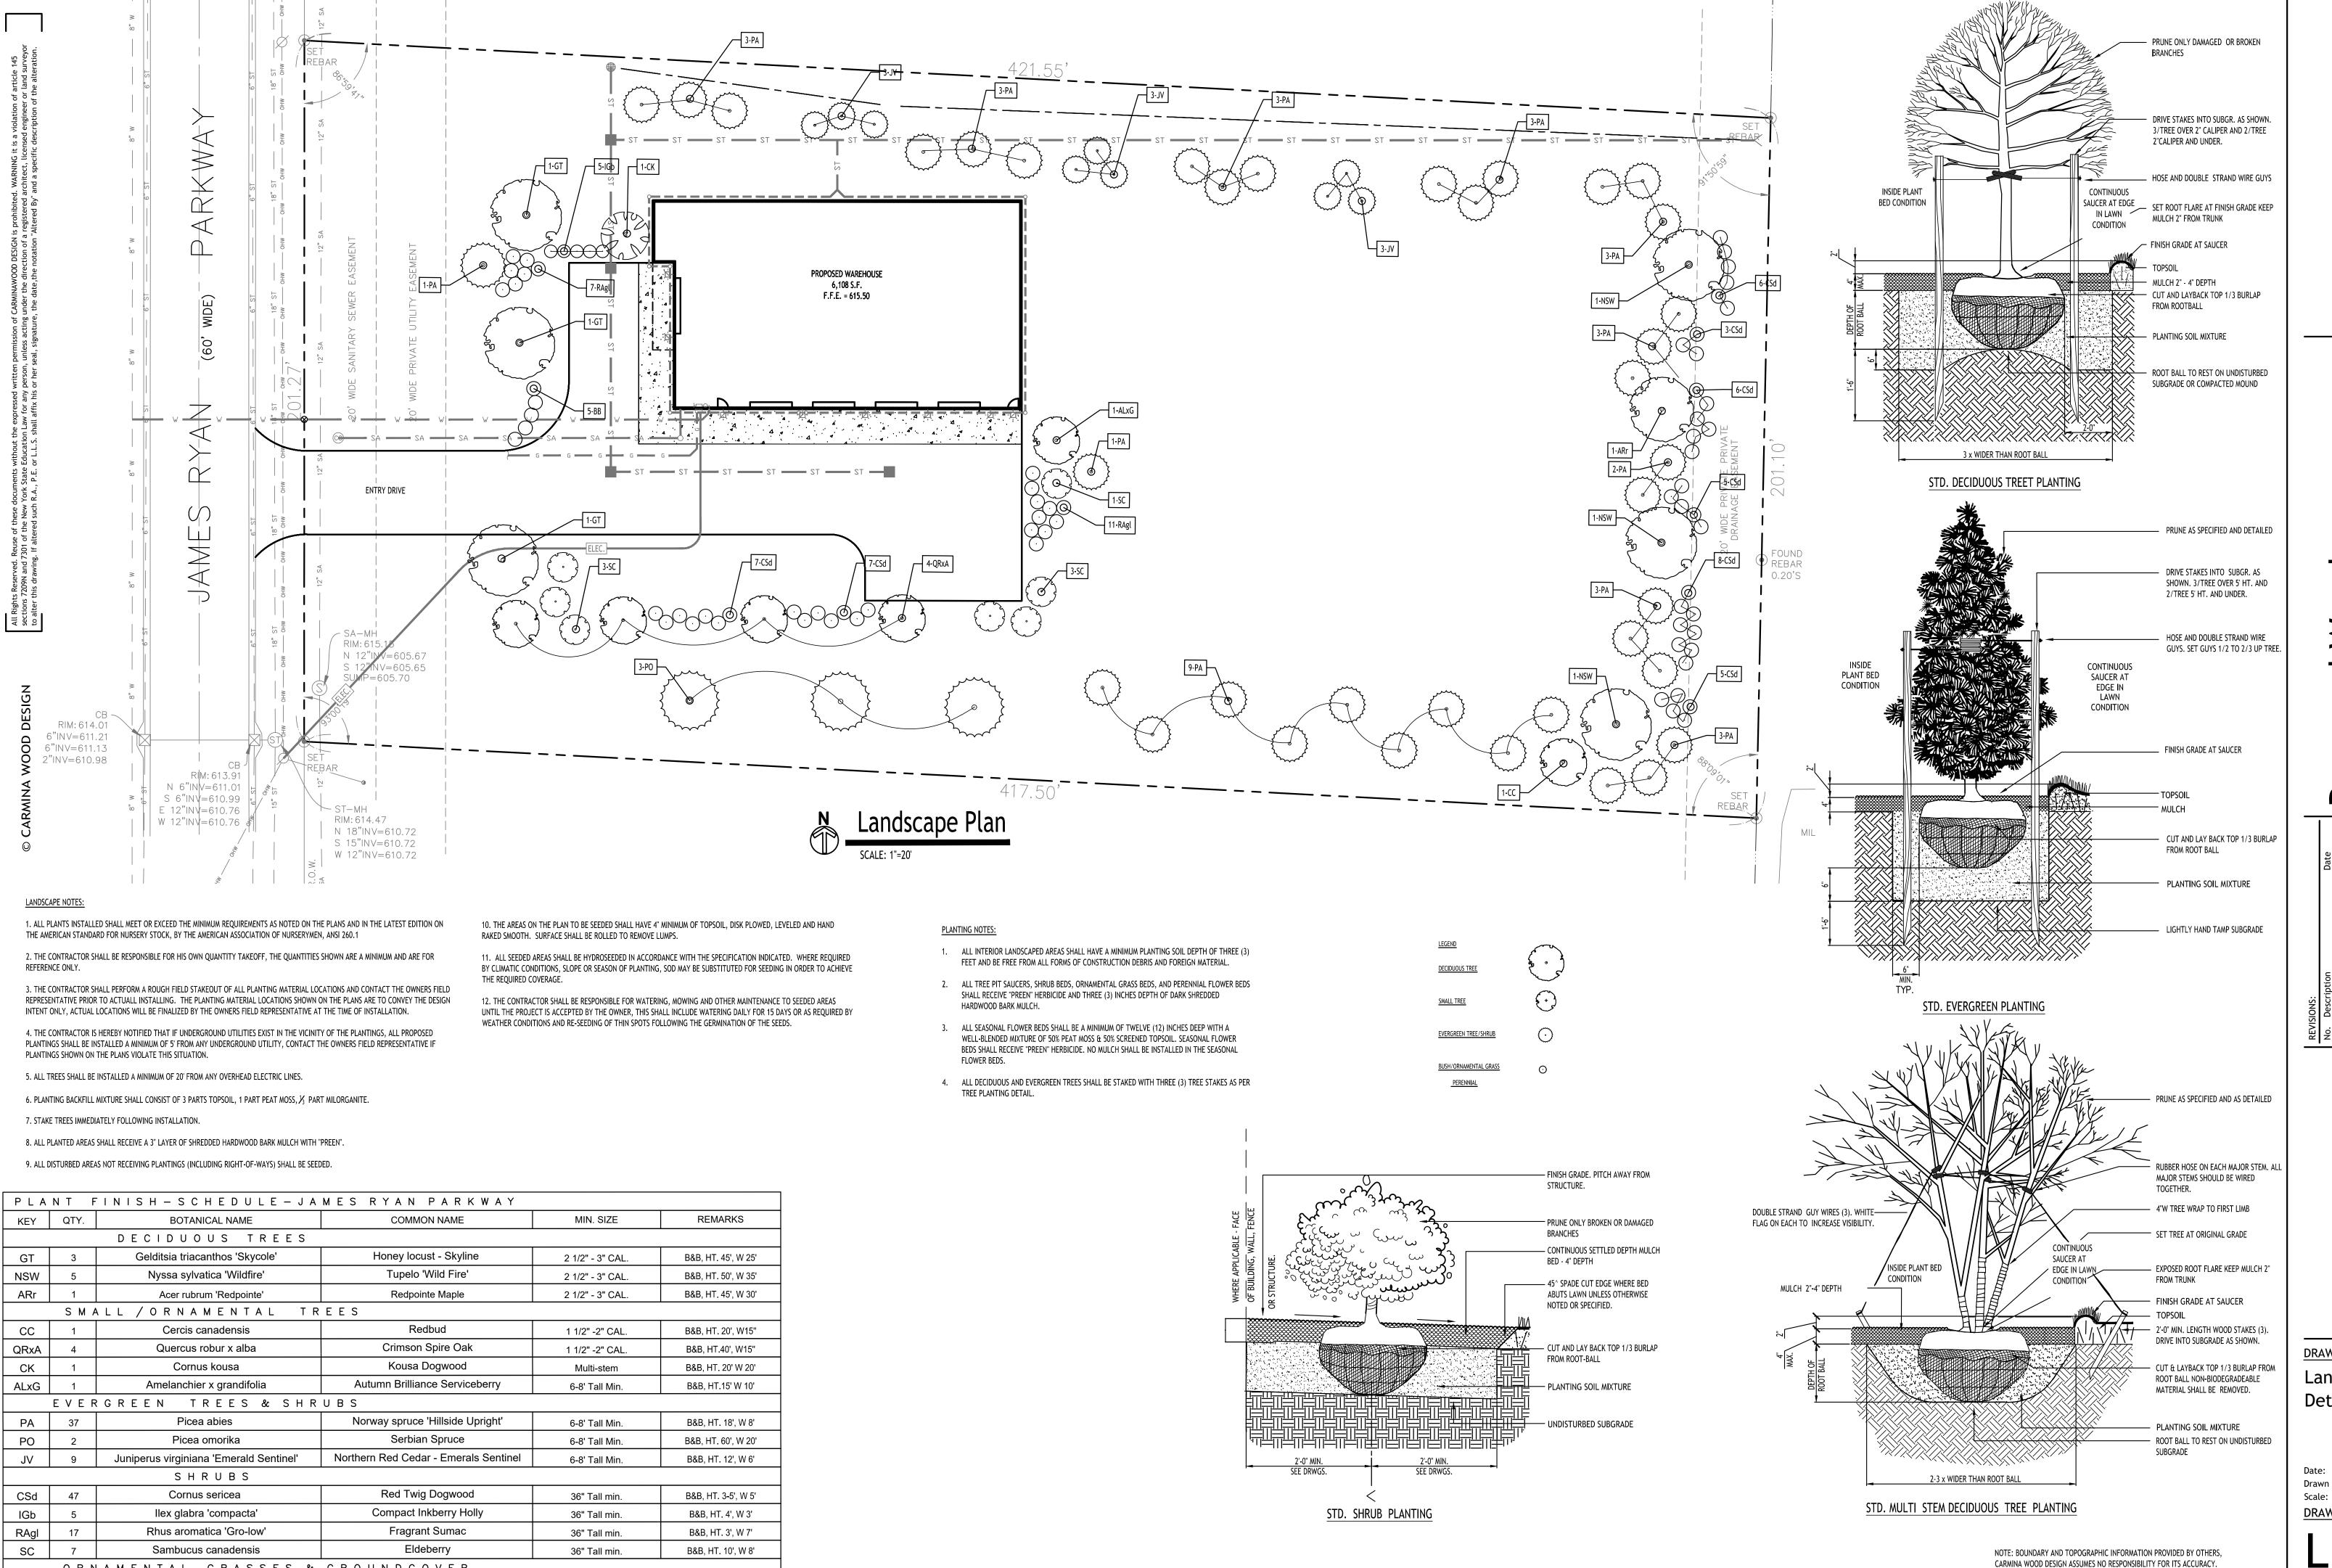

ORNAMENTAL GRASSES & GROUNDCOVER

Andropogon gerardii

BB 5

Big Blue Stem andropogon

Cont. no.3, HT. 4, W 3'

36" Tall min.

**DRAWING NAME:** Landscape Plan Details/Schedule

Drawn By: DRAWING NO.


PRELIMINARY NOT FOR CONSTRUCTION

DRAWING NAME: **Lighting Plan** 

NOTE: BOUNDARY AND TOPOGRAPHIC INFORMATION PROVIDED BY OTHERS, CARMINA WOOD DESIGN ASSUMES NO RESPONSIBILITY FOR ITS ACCURACY.

DRAWING NO. <u>Project No:</u> 24-4137

6/12/25 A. Pandolfe As Noted Date: Drawn By: Scale:

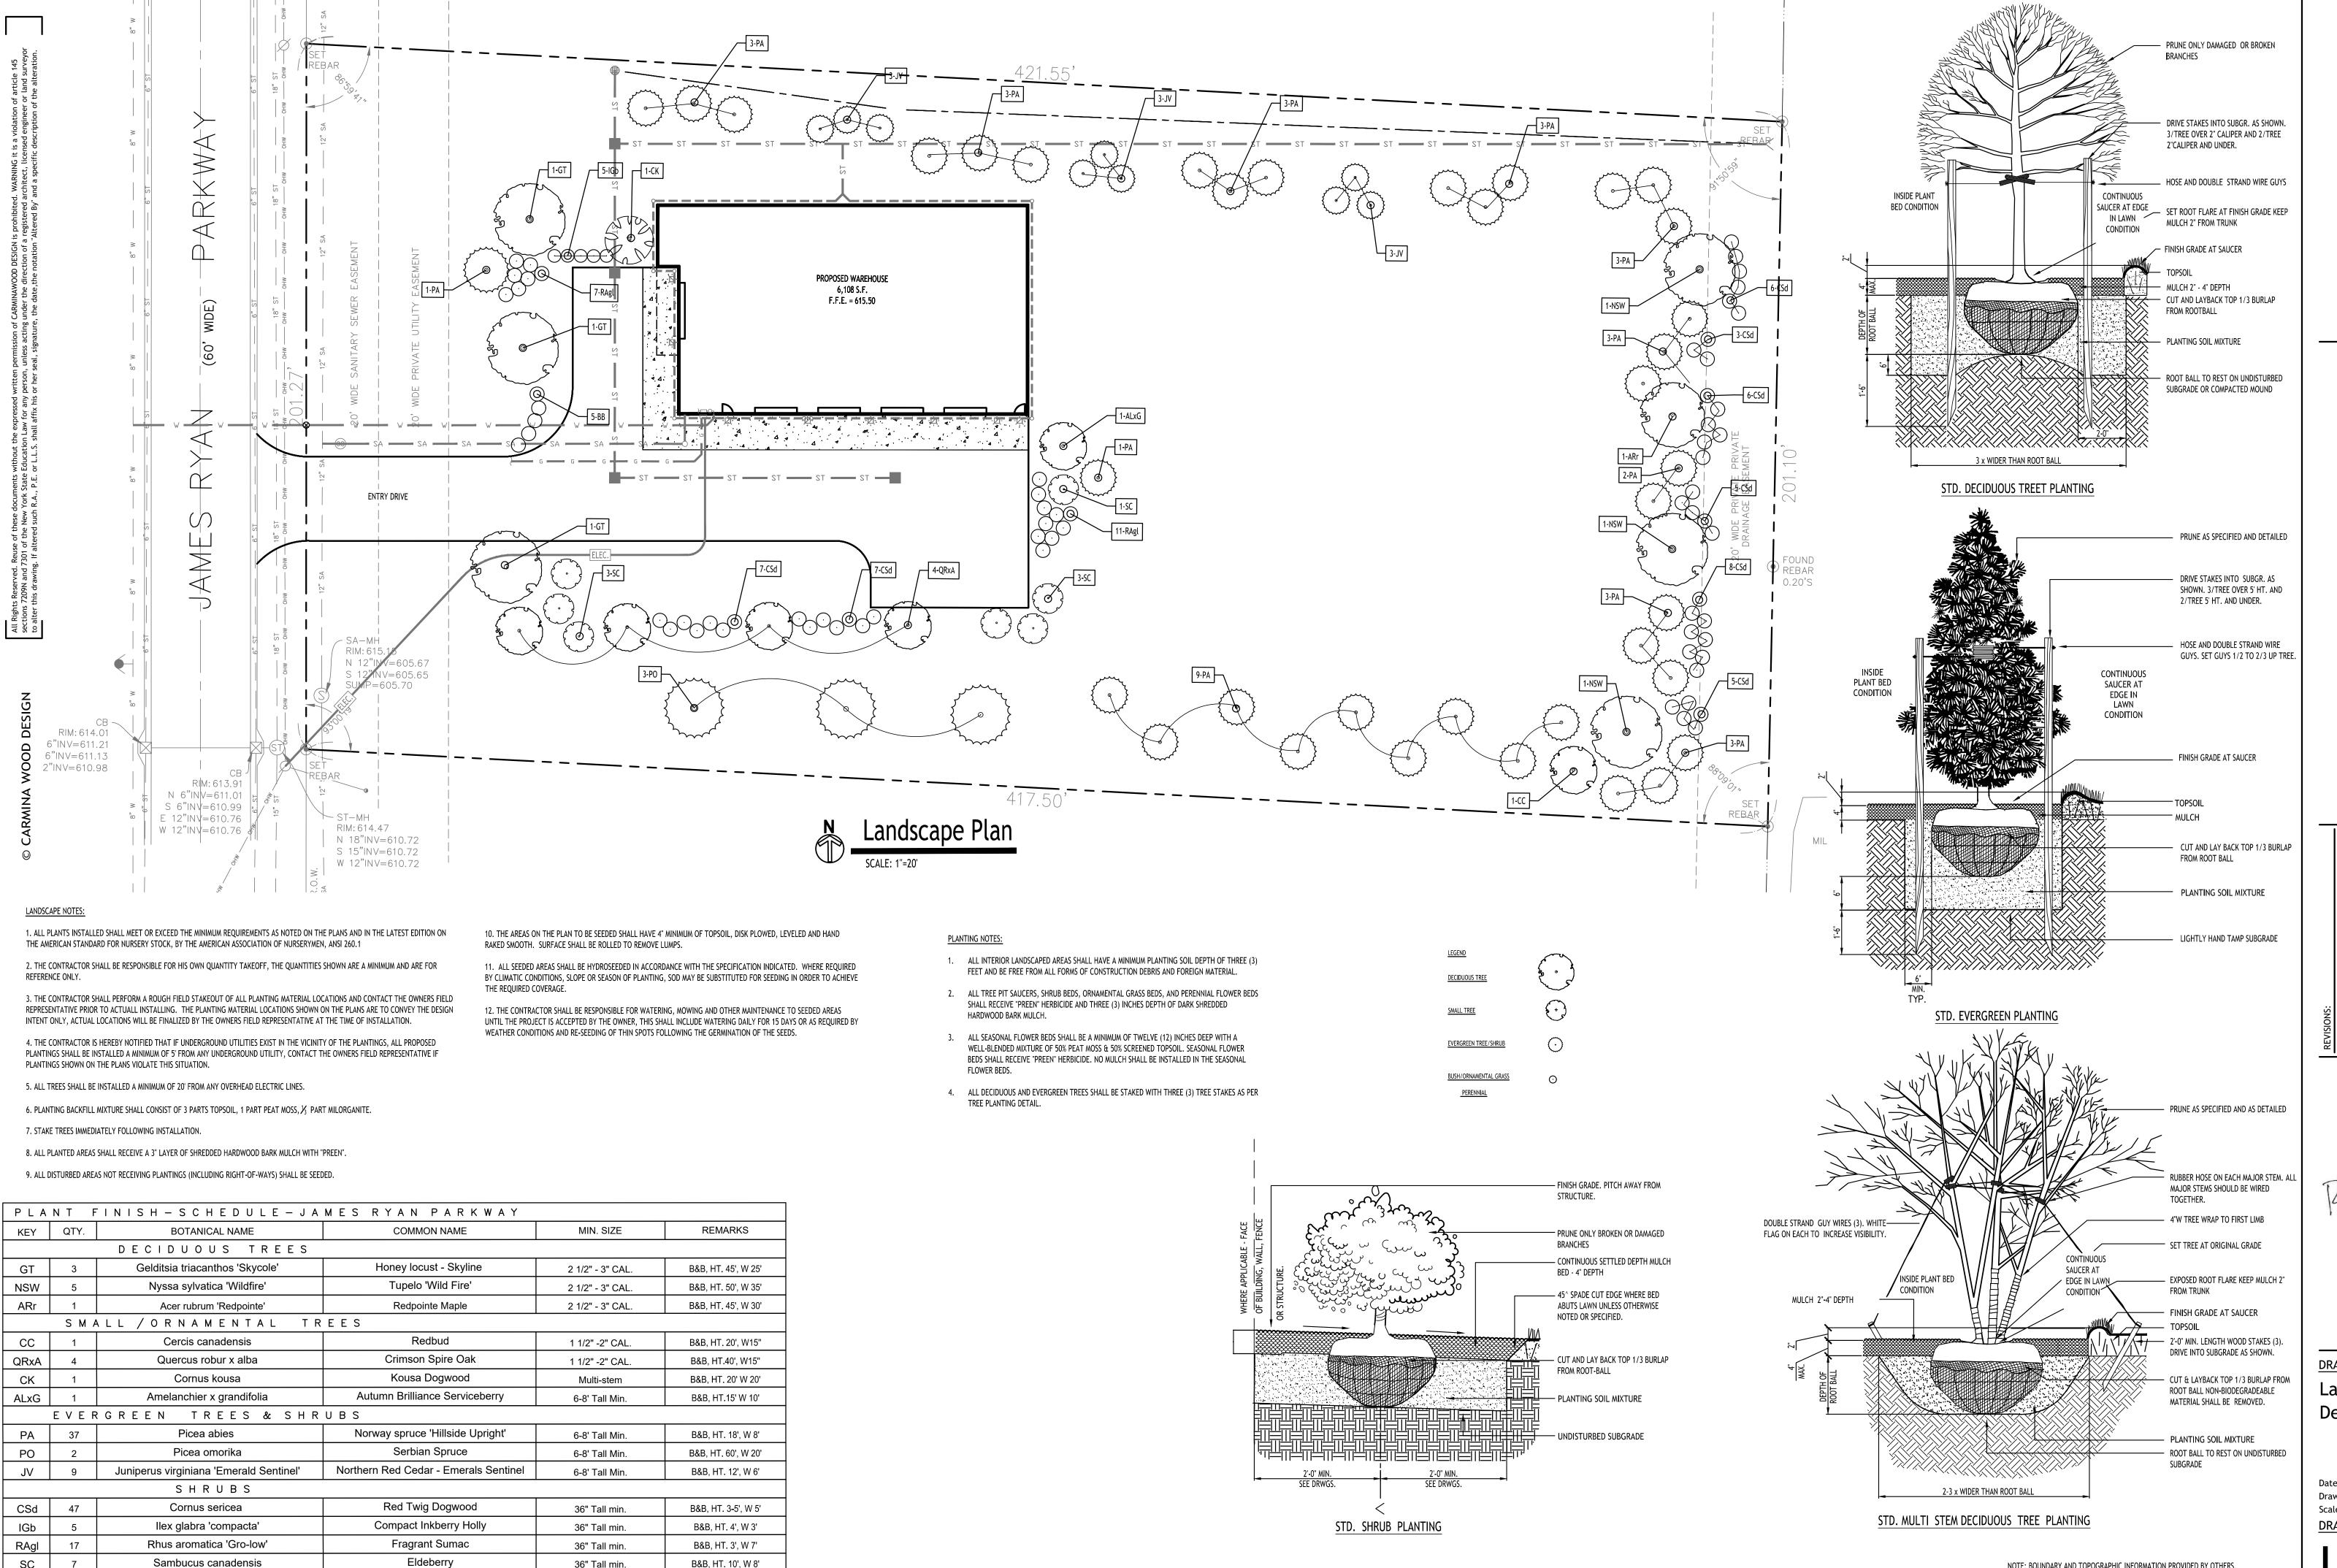

Sambucus canadensis

Andropogon gerardii

BB 5

ORNAMENTAL GRASSES & GROUNDCOVER

Big Blue Stem andropogon

B&B, HT. 10', W 8'

Cont. no.3, HT. 4, W 3'


36" Tall min.


36" Tall min.

**DRAWING NAME:** Landscape Plan Details/Schedule

Drawn By: DRAWING NO.

NOTE: BOUNDARY AND TOPOGRAPHIC INFORMATION PROVIDED BY OTHERS, CARMINA WOOD DESIGN ASSUMES NO RESPONSIBILITY FOR ITS ACCURACY.

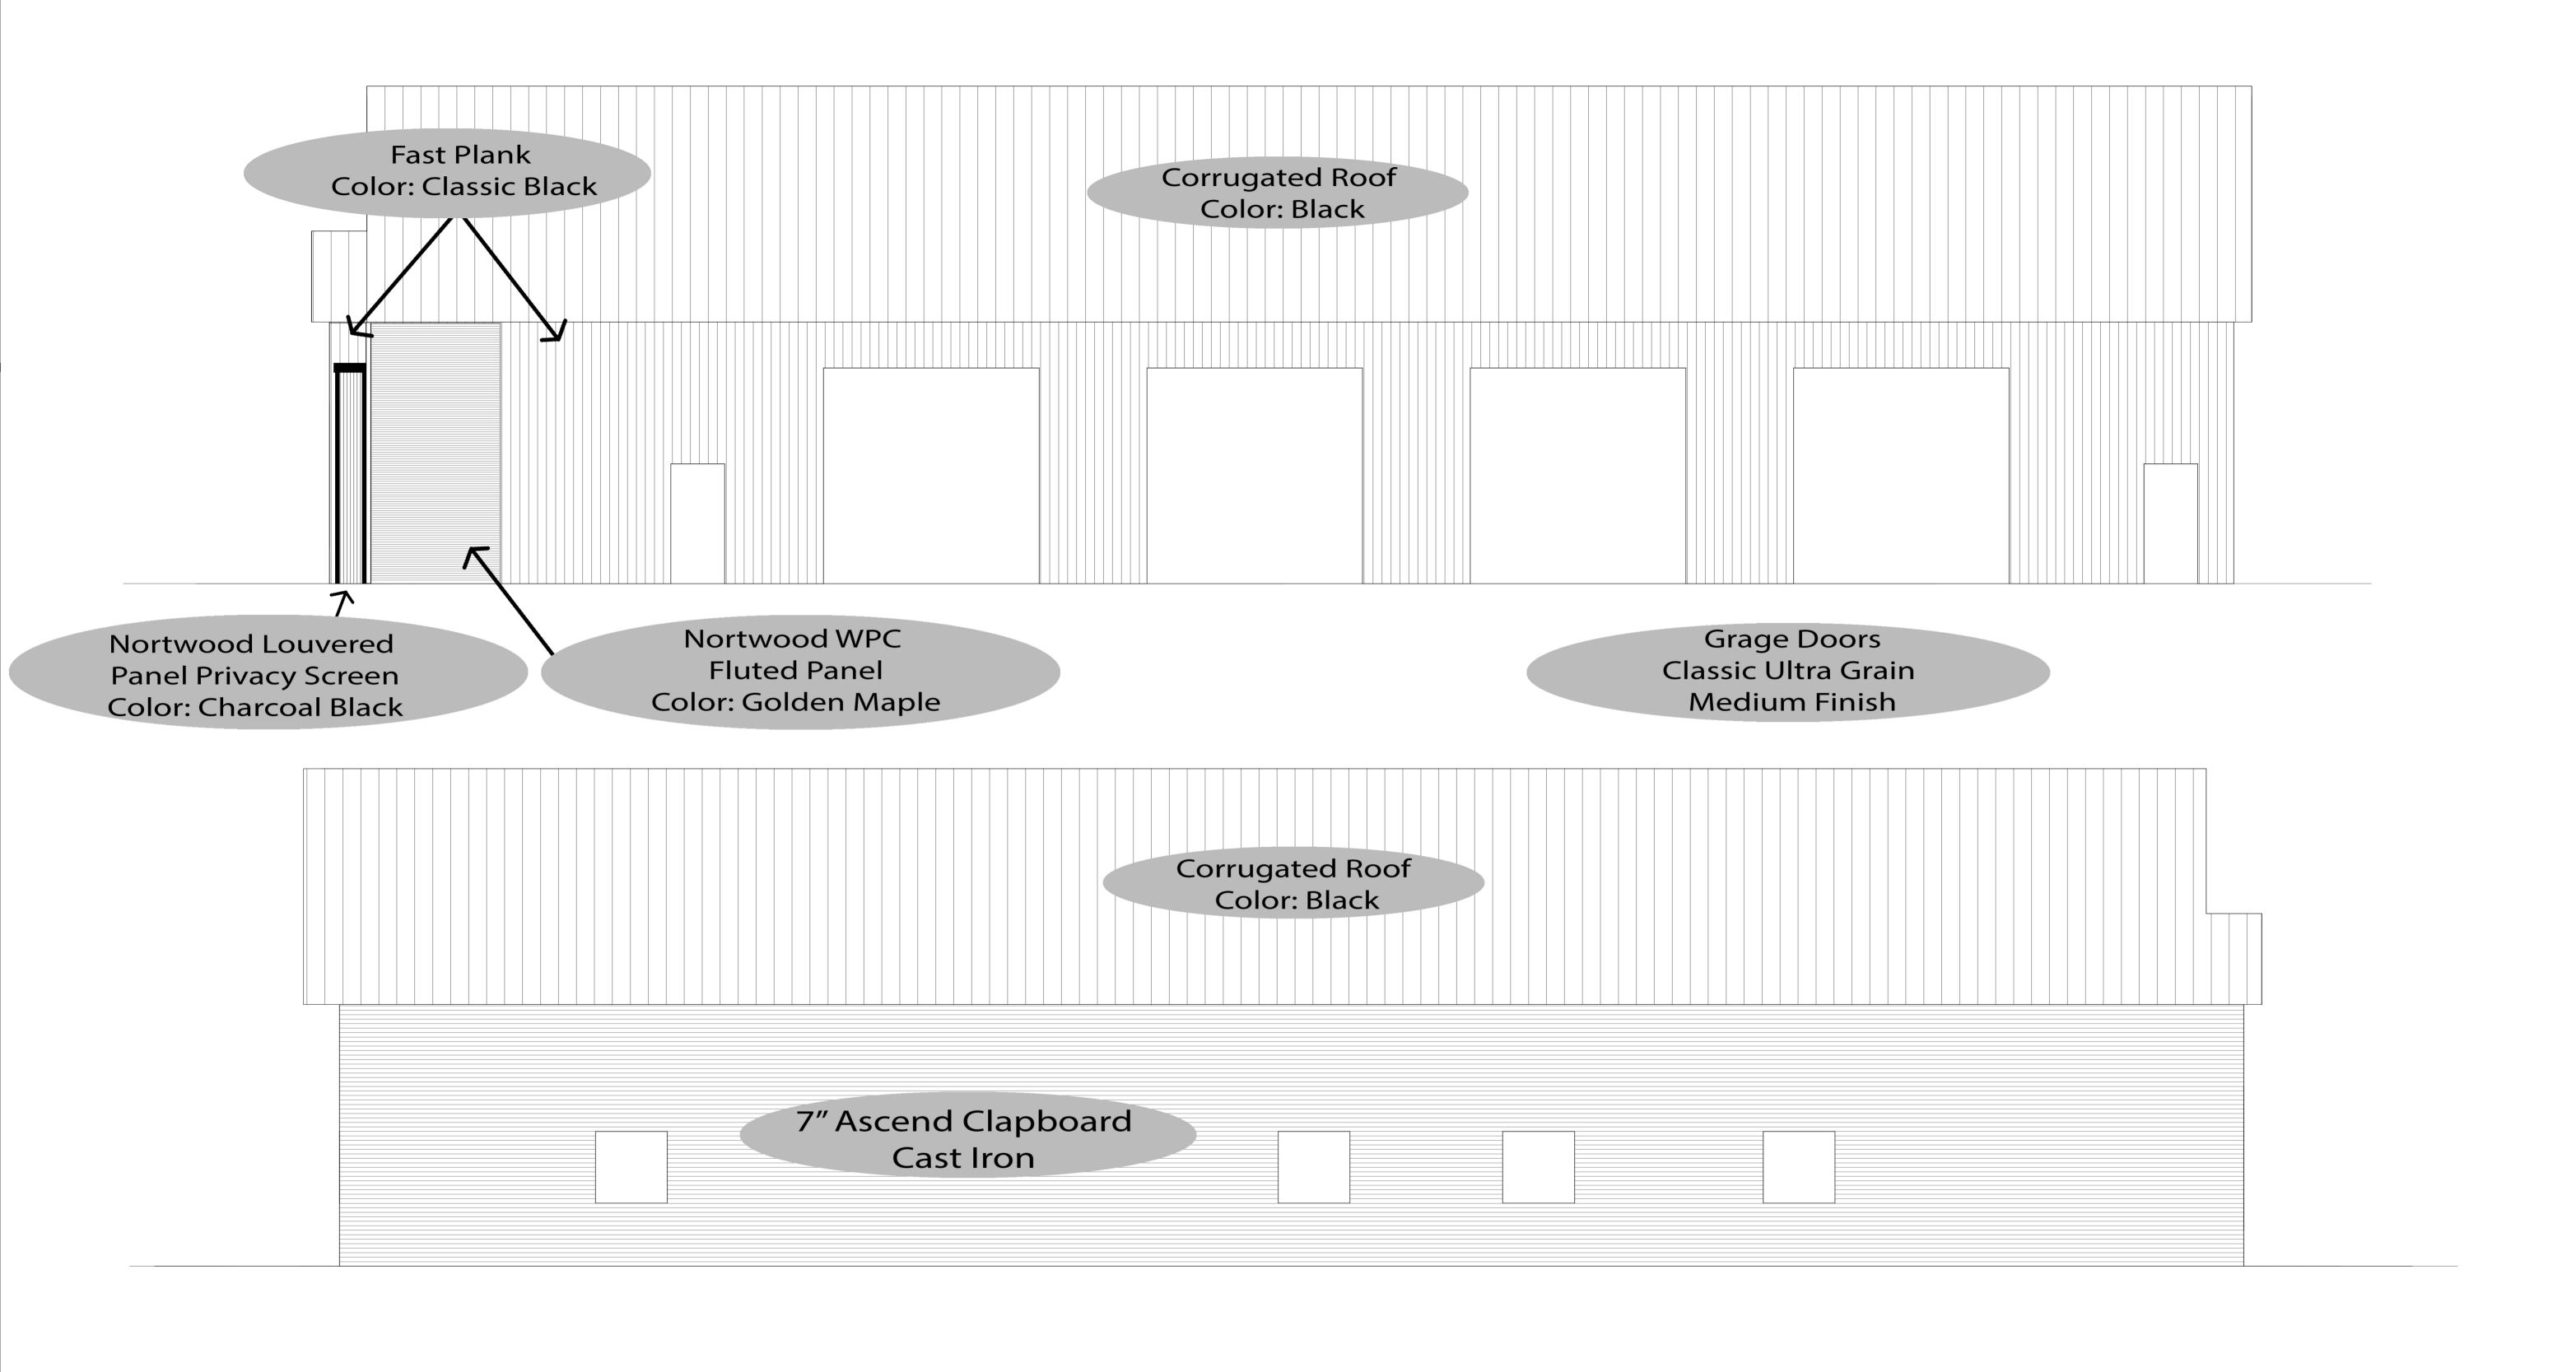

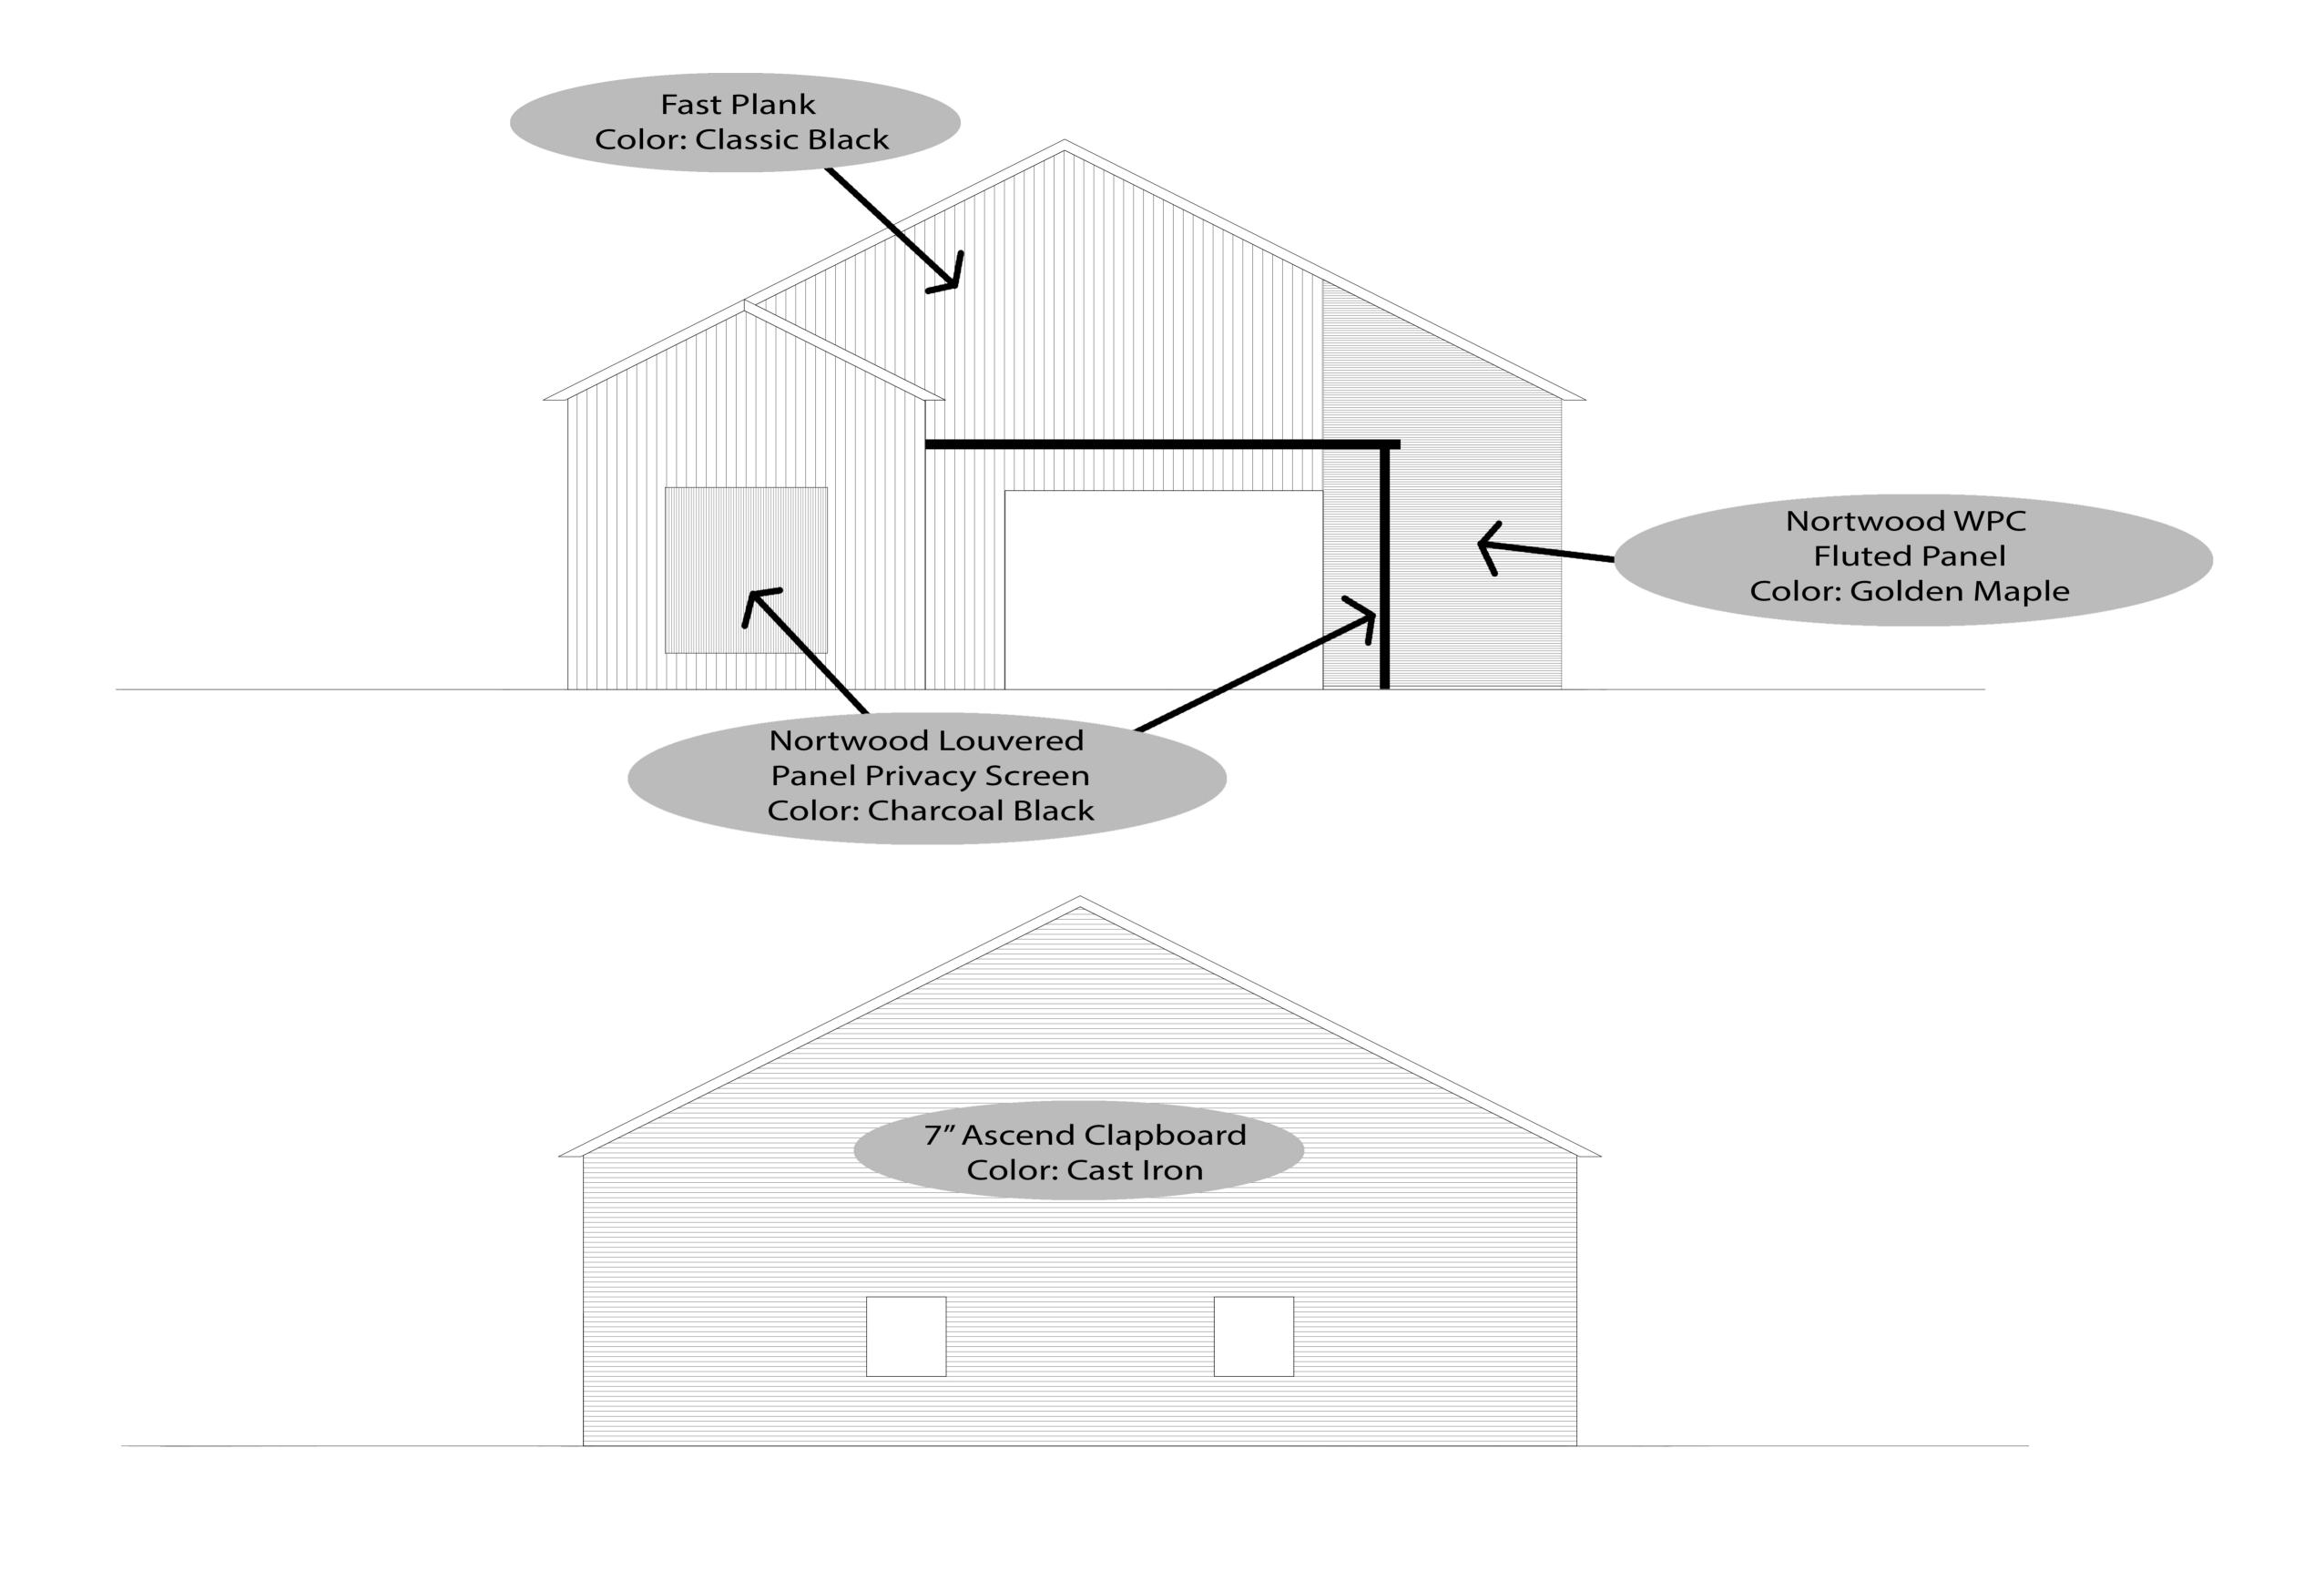

#### Jonathan Bleuer

From: Matthew Dubois <mdubois@blockandlongo.com>

Sent: Tuesday, November 12, 2024 12:17 PM

To: Jonathan Bleuer
Cc: Jeff Palumbo

**Subject:** Materials for car storage garage - Lot 8, James Ryan Parkway

Categories: Incomplete

Hi John,

It was good to see you today. As we discussed with Jeff, we're sending over the list of material selections for the garage, along with the plans in digital format. We'll also send over the rendering with the materials called out, the 5 sets of as well as samples as soon as we have them. Also forthcoming will be:

- The 5 sets of full-size (24 x 36") plans
- Short EAF Part I

#### **Material Selections:**

- 1. Front Elevation Fast Plank "Classic Black" Vertical Install, Please see link below:
- 2. Sides and Rear Alside Odyssey 7" Ascend Composite Cladding "Cast Iron" Horizontal Install
- 3. Black Windows
- 4. Garage Doors Clopay Modern Steel Collection "Classic Ultra Grain Medium Finish" I just want to triple check on the color with Mike from Hamburg Overhead Door I have a call out to him, I am just waiting to hear back.
- 5. For the Service Doors, I would first want to check with Big L (if that's who we are going through for windows), to see if they can get a Clopay factory finish match for the doors. This way, it will be an exact match to the garage doors, and would come with a warranty.
- 6. Horizontal Accent on Right Corner Nortwood "Golden Maple" I believe I sent you the link earlier, if not, please see below:
- 7. Vertical Slat Wall and Louvered Privacy Screen on Front Elevation Window Nortwood "Black" (Recommended 4" Apart from Rep)

#### Links:

https://engagebp.com/fastplank/color-

<u>options/?</u> gl=1\*mcjyad\* up\*MQ..&gclid=CjwKCAjwpbi4BhByEiwAMC8JneTDAlaDn82WLFevLvDoPg4tNchwShc366Q5dYpLfTSt7P0ZZc JPhoC6O4QAvD BwE

https://www.alside.com/product-catalog/siding/ascend-composite-cladding/

https://nortwood.com/residential/

Thanks, and talk to you soon.

Matthew T. Dubois, Esq.

**Attorney** 



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ALBANY OFFICE: 43 British American Blvd., Latham, NY 12110 Phone (518) 313-7111; Fax: (518) 313-7115 BATAVIA OFFICE: 39 Jackson Street, Batavia, NY 14020, Phone: (585) 310-7442; Fax: (585) 310-7599 BUFFALO: One Niagara Square, Buffalo, NY 14202, Phone (716) 854-4080; Fax: (716) 854-0059 CLARENCE OFFICE: 9276 Main St Ste 3, Clarence 14031, Phone: (716)854-4080; Fax: (716) 854-0059 GREECE OFFICE:550 Latona Road, Building C, Suite 301, Rochester, NY 14626 Phone: (585) 310-7442; Fax (585) 310-*7599* 

DANSVILLE OFFICE: 172 Main Street, 1st Floor, Dansville, NY 14437, Phone: (585) 310-7442; Fax (585) 310-7599 NEWARK OFFICE: 506 W. Union Street, Newark, NY 14513, Phone: (585) 310-7442; Fax (585) 310-7599 NYC OFFICE: 150 West 30th Street, Suite 705, New York, NY 10001; Phone: (332) 910-5440 ROCHESTER OFFICE:1173 Pittsford-Victor Road, Suite 220, Pittsford, NY 14534, Phone: (585)310-7442; Fax: (585)310-*7599* 

SARATOGA OFFICE: 550 Maple Avenue, Saratoga Springs, NY 12866 Phone (518) 313-7111; Fax: (518) 313-7115 SYRACUSE OFFICE: 6739 Myers Road, East Syracuse, NY 13057, Phone: (315) 457-1000; Fax: (315) 457-1001 WILLIAMSVILLE OFFICE: 5900 Main Street, Williamsville, NY 14221-5714 Phone (716) 633-1444 Fax: (716) 633-1446 FLORIDA OFFICE: 824 W. Indiantown Rd., Jupiter, FL 33458, Phone: (561) 768-0304, Fax: (561) 768-0366

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#### TOWN OF CLARENCE

ENGINEERING and BUILDING DEPARTMENTS
6221 Goodrich Road
Clarence Center, NY 14032
716-741-8952
FAX: 716-407-8915



September 24, 2025

Timothy M. Lavocat, P.E., CFM Town Engineer

Anthony Pandolfe, P.E. Carmina Wood Design 80 Silo City Row, Suite 100 Buffalo, NY 14203

Re:

Capretto Proposed Warehouse 6699 James Ryan Parkway Development Plan Review #3

Dear Mr. Pandolfe:

The Town of Clarence Engineering Department has performed a review of the development plan information for the above referenced project dated July 7, 2025 and received by this department July 28, 2025. The Development Plan meets the technical requirements of the Engineering Department and is subject to the conditions below. Additional Town Committee/Board approvals are required for final Development Plan approval.

- 1. Private Improvement Permits (PIP's) are required for pavement and curbing, storm drainage and grading and fire protection main prior to any site work.
- 2. All sheets of the PIP plans are to be wet stamped and signed. Four (4) sets of plans are required to be submitted with the PIP applications to the Engineering Department. Other departments may require additional plans.
- 3. All conditions of approval by the Engineering Department and the Planning Board Resolution for Development Plan approval shall be clearly presented on the cover sheet of the PIP Plans.
- 4. Only approved plan sets bearing the signature of the Town Engineer shall be considered valid plans to be used on site. All sheets of PIP plans to be clearly labeled "ISSUED FOR CONSTRUCTION".
- 5. Provide a PDF PIP plan set and Engineer's Report to the Engineering Department.

Should you have any questions or require further clarification regarding the review of the above referenced project please feel free to contact me.

Very truly yours,

Joseph Lancellotti

Asst. Municipal Engineer

Cc:

Timothy Lavocat, P.E., Town Engineer Jonathan Bleuer, Director of Community Development Paul Gross, Senior Code Enforcement Officer David Capretto, 470 Cayuga Road, Buffalo, NY 14225