SITE AREA = 0.6 AC± ZONED: RESTRICTED BUSINESS		
USE: VEHICLE DETAIL/WASH BUSINESS		
SETBACKS - PARKING	REQUIRED	PROVIDED
FRONT	N/A	30.9 FT
SIDE	N/A	12.3 FT MIN.
REAR	N/A	11.0 FT MIN.
PARKING STALLS		
STALL SIZE	9'x19'	9'x19'
REQUIRED SPACES	15	15
GREENSPACE		
OVERALL SITE GREENSPACE	25% (0.15 AC)	28.3% (0.17 AC
INTERIOR GREENSPACE	8% (1,180 SF)	8.8% (1,300 SF

PARKING CALCULATION:

"ALL OTHER COMMERICAL"

1 SPACE PER 200 GSF OF FLOOR AREA
3,000 GSF / 200 = 15 SPACES

TOTAL SPACES REQUIRED = 15 SPACES

## SITE NOTES:

- 1. ALL RADII SHALL BE 3'-0" UNLESS OTHERWISE NOTED.
- 2. ALL DISTURBED AREAS: SHALL HAVE 4" MIN. OF TOPSOIL AND SEED.
- 3. ALL DIMENSIONS FROM PROPERTY LINES SHALL BE MEASURED PERPENDICULAR
- 4. PROPERTY LINES AND EXISTING SITE FEATURES ARE APPROXIMATE, EXACT LOCATION TO BE VERIFIED IN FIELD PRIOR TO CONSTRUCTION.
- 5. ALL PROPOSED PAVEMENT TO BE INSTALLED TO HAVE POSITIVE DRAINAGE TOWARD, NO RUNOFF SHALL BE DIRECTED TO THE NEIGHBORING PROPERTIES.

## **GENERAL NOTES:**

- 1. INSTALL ALL MATERIALS TO MANUFACTURER'S RECOMMENDATIONS AND BEST STANDARDS OF TRADE INVOLVED.
- 2. SUBSTITUTIONS SHALL BE MADE ONLY WITH OWNER'S APPROVAL AND BE OF EQUIVALENT QUALITY TO WHAT IS SPECIFIED.
- 3. WORK SHALL BE COMPLETED IN STRICT ACCORDANCE WITH ALL LOCAL CODES AND OSHA SAFETY RULES AND REGULATIONS.
- 4. VERIFY ALL EXISTING CONDITIONS AND DIMENSIONS AT THE SITE. NOTIFY OWNER & ENGINEER OF DISCREPANCIES IN CONDITIONS SHOWN ON DRAWINGS PRIOR TO PROCEEDING WITH THE WORK.
- 5. CONTRACTOR SHALL BE RESPONSIBLE FOR PROTECTION OF ANY EXISTING STRUCTURES TO REMAIN AND ANY FINISH MATERIAL INSTALLED WHILE WORKING ON OTHER COMPONENTS.
- 6. CONTRACTOR SHALL KEEP JOB FREE OF DEBRIS AND MAKE FINAL CLEANUP TO SATISFACTION OF OWNER.
- CONTRACTOR SHALL ASCERTAIN THE LOCATION OF ALL UTILITIES PRIOR TO CONSTRUCTION SO THAT THIS WORK WILL NOT DISTURB EXISTING LINES AND/OR INSTALLATIONS. COORDINATE ALL WORK WITH THE APPLICABLE UTILITY COMPANIES.
- 8. ALL OTHER PERMITS REQUIRED BY STATE OF NEW YORK, COUNTY OF ERIE, AND TOWN OF CLARENCE ARE THE RESPONSIBILITY OF THE CONTRACTOR/DEVELOPER/OWNER.
- 9. REFER TO NYSDOT STANDARD SHEET 608-03 FOR DRIVEWAY ENTRANCE AND LAYOUT INFORMATION ALONG SHERIDAN DRIVE.

SITE LEGEND

10. ALL DISTURBED AREAS WITHIN NYSDOT R.O.W. TO BE RESTORED USING ITEM 610.1402 TOPSOIL - ROADSIDE AND ITEM 610.1602 TURF ESTABLISHMENT - LAWNS AND COMPLY WITH NYSDOT STANDARDS AND SPECIFICATIONS SECTION 713 - LANDSCAPE DEVELOPMENT MATERIALS.

## PLANTING SCHEDULE - 8870 SHERIDAN DRIVE, TOWN OF CLARENCE, NEW YORK

KEY	QTY.	BOTANICAL NAME	COMMON NAME	MIN. SIZE	REMARKS
		DECIDUOUS TREES			
GD	3	GYMNOCLADUS DIOICUS 'J.C. MCDANIEL'	PRAIRIE TITAN KENTUCKY COFFEETREE	2-1/2" - 3" CAL.	B&B, HT. 60', WIDTH 30'
		SHRUBS			
CP	7	CHAMAECYPARIS PISIFERA 'FARROWCGMS'	SOFT SERVE GOLD FALSE CYPRESS	NO. 7 CONT.	GROWS TO 10 FT. HIGH, 6 FT. WIDE

NOTES:

1. ALL PLANT MATERIALS SHALL BE INSPECTED TWICE ANNUALLY, ONCE IN THE SPRING AND AGAIN IN THE FALL. TREES & SHRUBS THAT ARE DEAD OR ARE IN POOR CONDITION/DISEASED (LESS THAN 50% LEAF COVER) SHALL BE REPLACED BEFORE THE NEXT GROWING SEASON. TREES AND SHRUBS THAT DO NOT EXHIBIT THE CONDITIONS FOR REPLACEMENT SHALL BE PRUNED AT THE TIME OF INSPECTION TO REMOVE DEAD TWIGS & BRANCHES.

2. ALL NURSERY TAGS TO REMAIN ON PLANTS UNTIL AFTER FINAL INSPECTION AND APPROVAL OF THE LANDSCAPING.

1 NYSDOT CURB 2 90° PARKING STALL 2 LANDSCAPED AREA - IF NOT PLANTINGS INSTALL 4" TOPSOIL & SEED 3 STANDARD DUTY ASPHALT 4 HANDICAP PAVEMENT MARKINGS 5 HANDICAPPED PARKING SIGN

6 EXTERIOR CONCRETE SLAB ON GRADE

7 DUMPSTER ENCLOSURE

3 MATCH INTO EXISTING PAVEMENT

/4\ INFILL AREA W/4" WIDE YELLOW PAVEMENT STRIPES @ 2' O.C. & 45° RUNOUT CURB 2' OR MATCH EX.

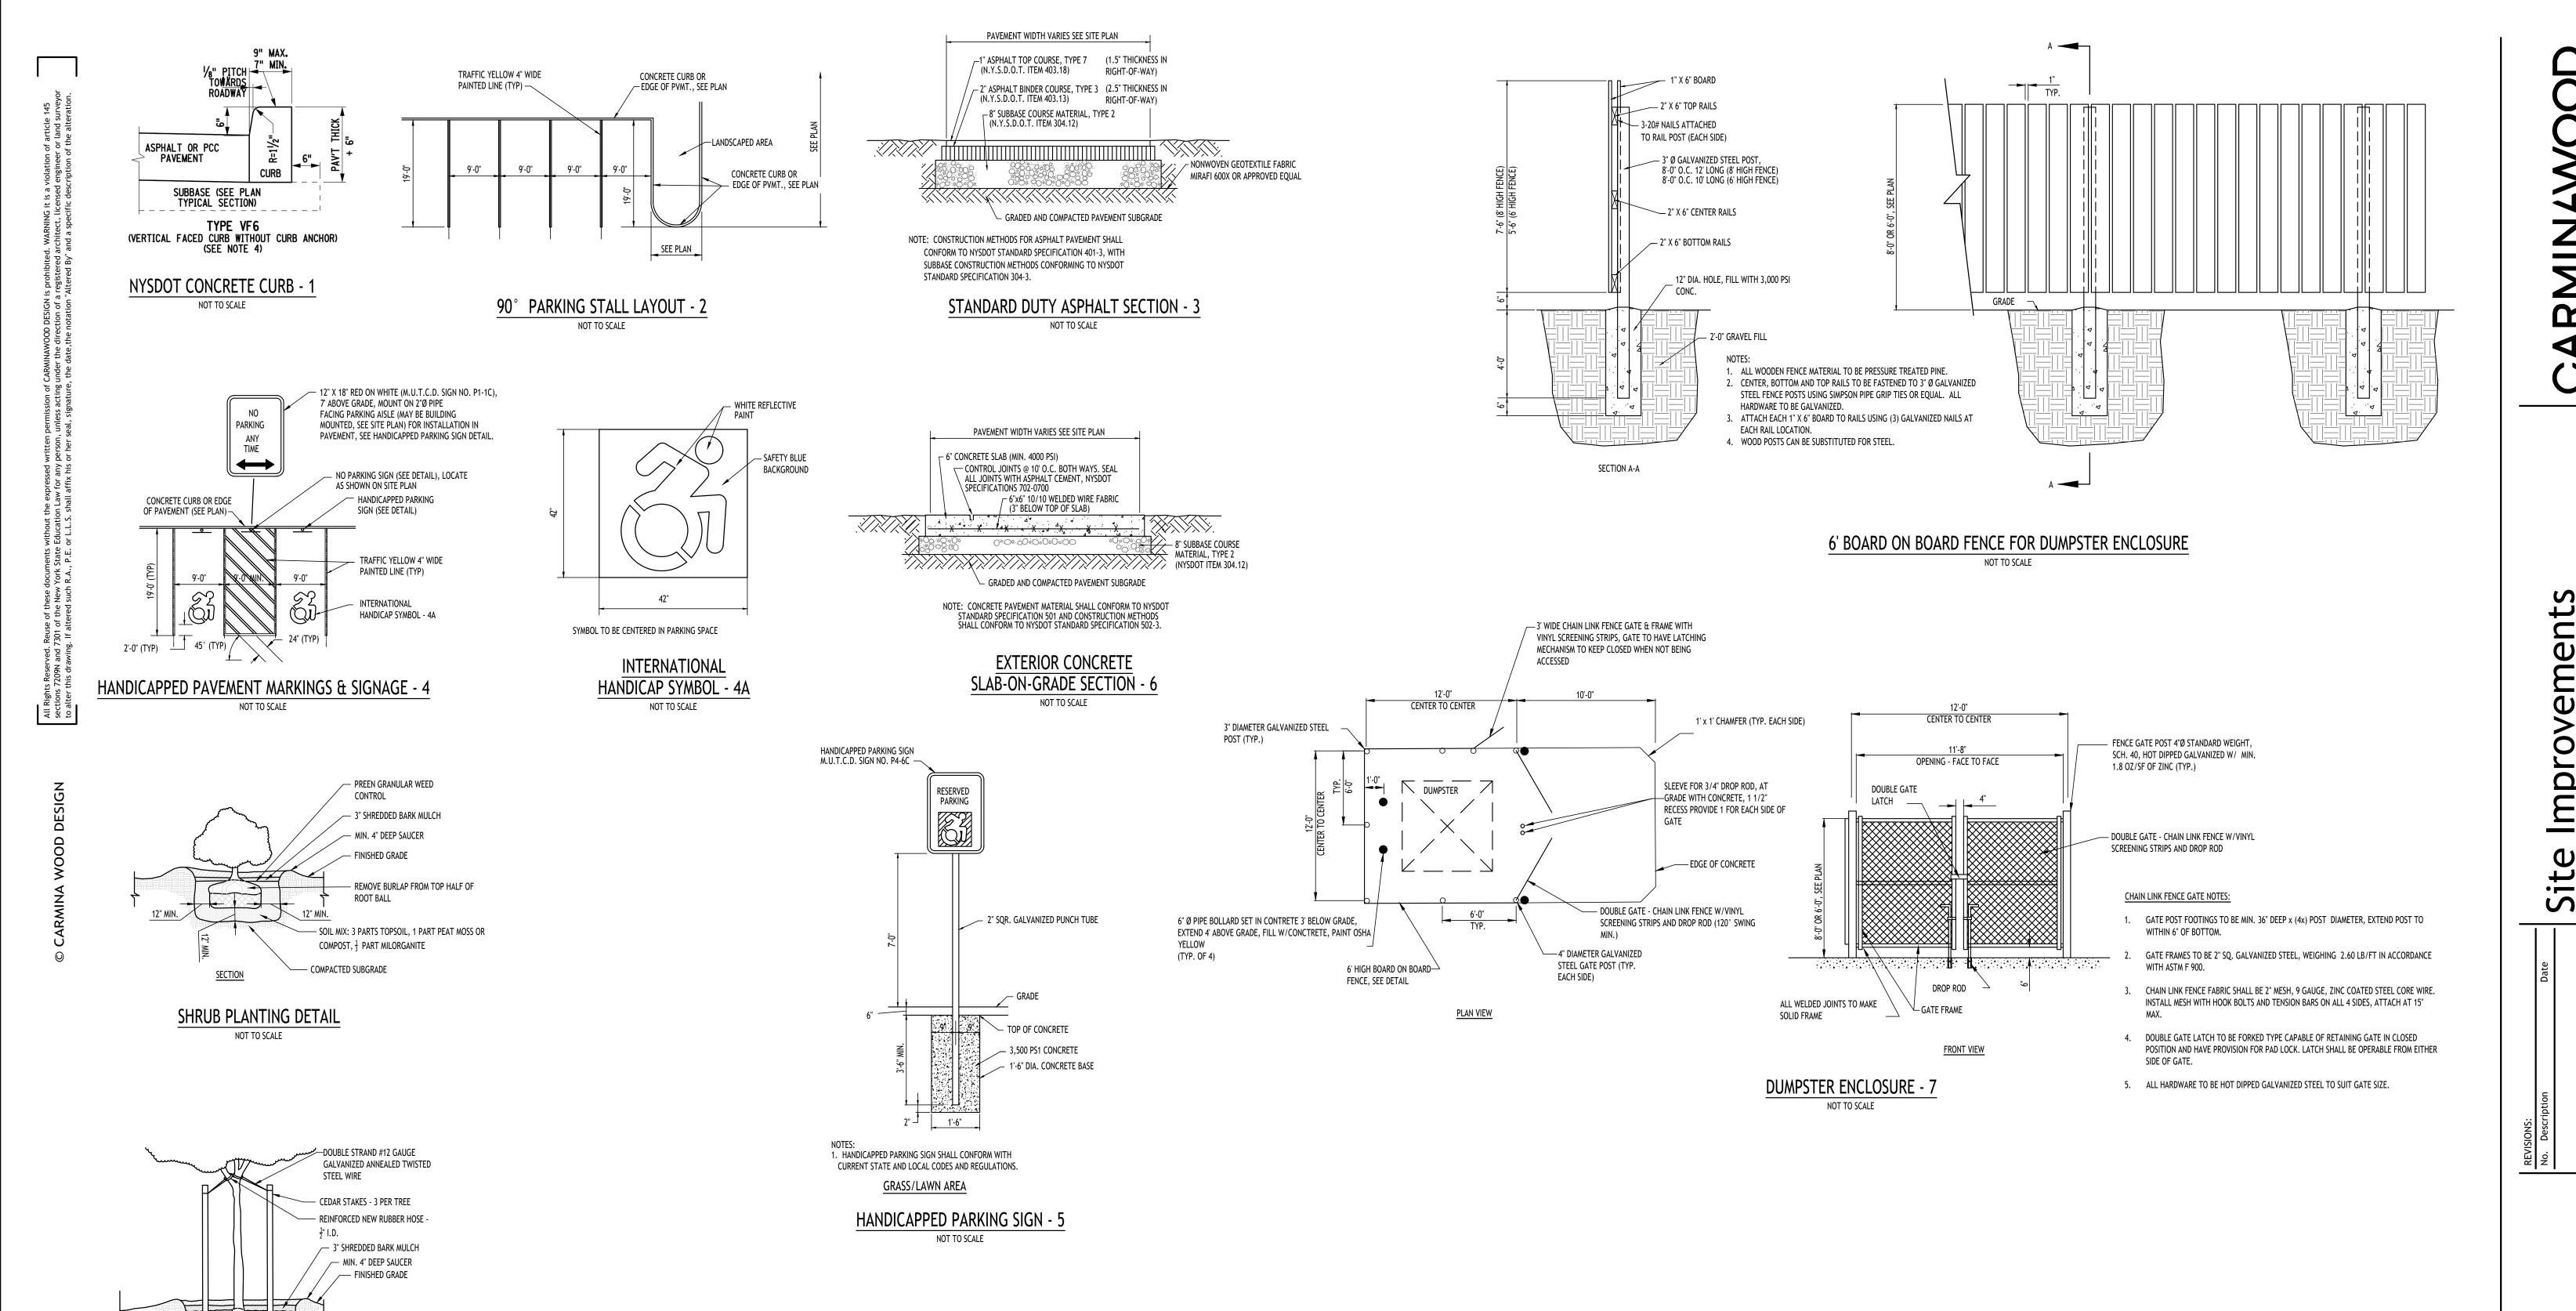
PROPERTY LINE \_---PROPOSED CURBING PROPOSED SIDEWALK / CONCRETE PAD 27 NUMBER OF PARKING SPACES PROPOSED SIGN PROPOSED STANDARD DUTY ASPHALT PAVEMENT

NOTE: BOUNDARY AND TOPOGRAPHIC INFORMATION PROVIDED BY OTHERS, CARMINA WOOD DESIGN ASSUMES NO RESPONSIBILITY FOR ITS ACCURACY.

DRAWING NAME: Site Plan

DRAWING NO.

1/6/25 P. Sheedy As Noted



- REMOVE BURLAP FROM TOP HALF OF

SOIL MIX: 3 PARTS TOPSOIL, 1 PART PEAT MOSS OR

ROOT BALL

COMPOST,  $\frac{1}{3}$  PART MILORGANITE

— COMPACTED SUBGRADE

<u>SECTION</u>

TREE PLANTING DETAIL

NOT TO SCALE



DRAWING NAME:
Site Details

Date:
Drawn By:
Scale:
DRAWING NO.

C-101

1/6/25

P. Sheedy

As Noted

<u>Project No:</u> 24-4172



January 8, 2025

Jonathan Bleuer
Director of Community Development
Town of Clarence Office of Planning and Zoning
One Town Place
Clarence, NY 14031

Re: Site Improvements

8870 Sheridan Drive

Clarence, NY

Mr. Bleuer:

On behalf of our client, Nash Kraft, please find enclosed the following documents for processing and review:

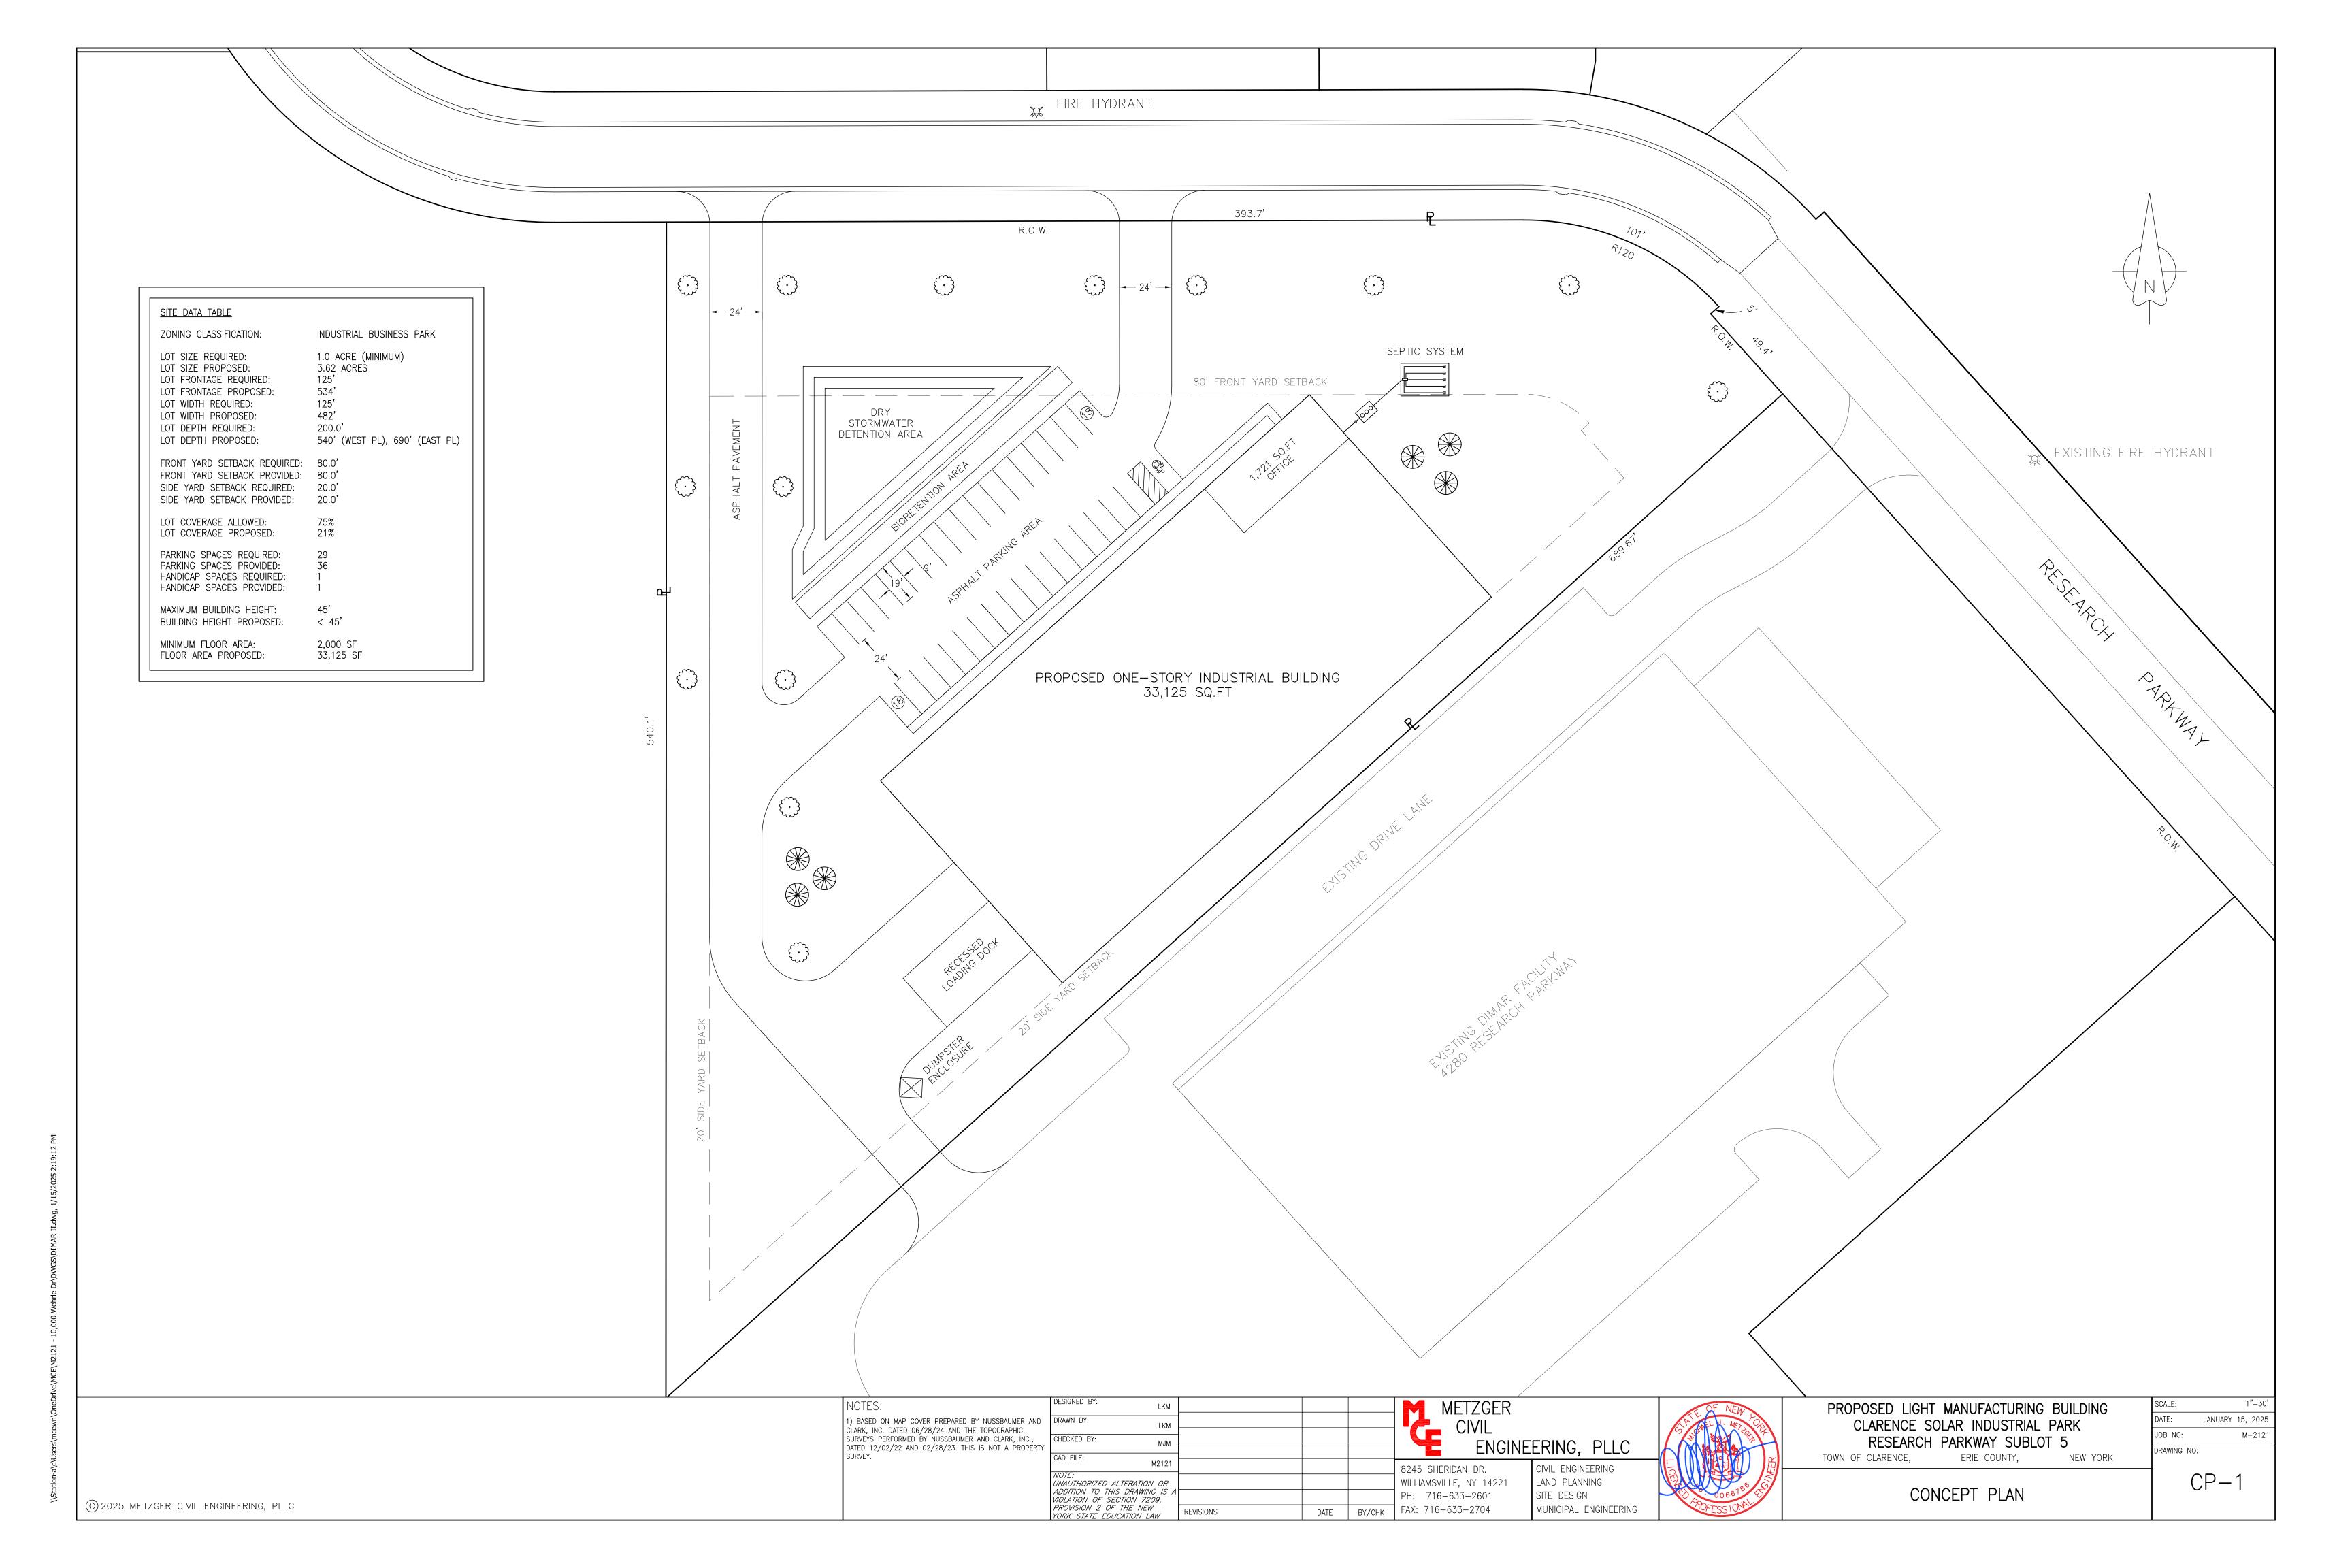
(5) Site Plan and Details [Drawing C-100 & C-101]

In response to the comment from the Town requesting improvements to the existing canopy, the applicant proposes the bottom 2'-3' of the six columns will be finished with a stone material complimentary to the stone material on the existing building at the storefront entrance. Additionally the structure will be freshly painted.

If you should have any questions regarding this letter, please contact me at (716) 842-3165 x123. Thank you.

Sincerely,

Patrick Sheedy Jr, PE | Senior Associate



## METZGER CIVIL ENGINEERING, PLLC

January 15, 2025

Mr. Jonathan Bleuer Director of Community Development Planning Department Town of Clarence One Town Place Clarence, NY 14031

Re:

Dimar Manufacturing Corporation Proposed Industrial Building Research Parkway Sublot 5

#### Dear Jonathan:

On behalf of our client, please find the following materials for a concept plan review for a new proposed industrial building on Lot 5 of the Clarence Solar Industrial Park, directly adjacent to (northwest of) the previously completed Dimar building at 4280 Research Parkway:

- Concept Plan CP-1 dated 01.15.25 (5 copies)
- Short Environmental Assessment Form (EAF) (2 copies)
- Request for Action Form (RFA) (2 copies)
- Building Renderings (2 copies)
- Building Floor Plan (2 copies)
- Office Floor Plan (2 copies)
- Building Elevations (2 copies)

It would be appreciated if you would place this on the next available Town Board work session agenda for referral to the Planning Board. Should you have any questions please don't hesitate to contact the undersigned at 716-633-2601 or via email at <a href="mailto:meteng@roadrunner.com">meteng@roadrunner.com</a>.

Yours truly,

Michael J Metzger, P.E.

enc.

CC.

Noel Dill Paul Stephen

## Short Environmental Assessment Form Part 1 - Project Information

## **Instructions for Completing**

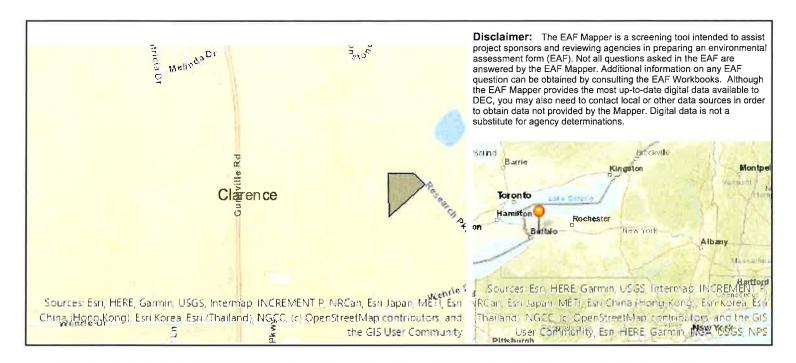
Part 1 – Project Information. The applicant or project sponsor is responsible for the completion of Part 1. Responses become part of the application for approval or funding, are subject to public review, and may be subject to further verification. Complete Part 1 based on information currently available. If additional research or investigation would be needed to fully respond to any item, please answer as thoroughly as possible based on current information.

Complete all items in Part 1. You may also provide any additional information which you believe will be needed by or useful to the lead agency; attach additional pages as necessary to supplement any item.

Part 1 – Project and Sponsor Information		
Name of Action or Project:		
DIMAR II - New Light Manufacturing Building - Research Parkway Sublot 5		
Project Location (describe, and attach a location map):		
Research Parkway, Clarence, NY 14031		
Brief Description of Proposed Action:		
Construction of a 33,125 square foot light manufacturing and storage facility.		
Name of Applicant or Sponsor:	Telephone: 716-633-260	1
Metzger Civil Engineering on behalf of Stephen Development	E-Mail: meteng@roadrur	nner.com
Address:		
8245 Sheridan Drive		
City/PO:	State:	Zip Code:
Williamsville	NY	14221
1. Does the proposed action only involve the legislative adoption of a plan, loca administrative rule, or regulation?	l law, ordinance,	NO YES
If Yes, attach a narrative description of the intent of the proposed action and the e	nvironmental resources th	nat 🗔 🖂
may be affected in the municipality and proceed to Part 2. If no, continue to ques	tion 2.	iat   🗸   🗌
2. Does the proposed action require a permit, approval or funding from any other	er government Agency?	NO YES
If Yes, list agency(s) name and permit or approval: Clarence PB Concept & Developm NYSDEC Stormwater SPDES Permit; ECHD Septic Approval; ECWA F	nent Plan Approval; RPZ Approval;	
3. a. Total acreage of the site of the proposed action?	3.62 acres	
b. Total acreage to be physically disturbed?	3.40 acres	
c. Total acreage (project site and any contiguous properties) owned or controlled by the applicant or project sponsor?	314± acres	
er controlled by the applicant of project sponsor?	314± acres	
4. Check all land uses that occur on, are adjoining or near the proposed action:		
5. Urban 🗹 Rural (non-agriculture) 🔽 Industrial 🗌 Commercia	al 🔲 Residential (subur	·ban)
Forest Agriculture Aquatic Other(Spec	eify):	
☐ Parkland	• /	

5. Is the proposed action,	NO	YES	N/A
a. A permitted use under the zoning regulations?		<b>√</b>	
b. Consistent with the adopted comprehensive plan?		<b>√</b>	
		NO	YES
6. Is the proposed action consistent with the predominant character of the existing built or natural landscape	)e?		V
7. Is the site of the proposed action located in, or does it adjoin, a state listed Critical Environmental Area?	,	NO	YES
If Yes, identify:			
		V	Ш
8. a. Will the proposed action result in a substantial increase in traffic above present levels?		NO	YES
		<b>✓</b>	
b. Are public transportation services available at or near the site of the proposed action?		<b>V</b>	
c. Are any pedestrian accommodations or bicycle routes available on or near the site of the proposed action?		<b>V</b>	
9. Does the proposed action meet or exceed the state energy code requirements?		NO	YES
If the proposed action will exceed requirements, describe design features and technologies:			
	-		<b>V</b>
10. Will the proposed action connect to an existing public/private water supply?		NO	YES
If No, describe method for providing potable water:			
Tries, describe method for providing potable water.			<b>✓</b>
			2 = 3
11. Will the proposed action connect to existing wastewater utilities?		NO	YES
If No, describe method for providing wastewater treatment:			_
On-site wastewater treatment system		$\checkmark$	
12. a. Does the project site contain, or is it substantially contiguous to, a building, archaeological site, or dist	trict	NO	VEC
which is listed on the National or State Register of Historic Places, or that has been determined by the			YES
Commissioner of the NYS Office of Parks, Recreation and Historic Preservation to be eligible for listing on State Register of Historic Places?	:he	<b>✓</b>	Ш
		_	_
b. Is the project site, or any portion of it, located in or adjacent to an area designated as sensitive for			V
archaeological sites on the NY State Historic Preservation Office (SHPO) archaeological site inventory?			
13. a. Does any portion of the site of the proposed action, or lands adjoining the proposed action, contain wetlands or other waterbodies regulated by a federal, state or local agency?		NO	YES
b. Would the proposed action physically alter, or encroach into, any existing wetland or waterbody?		Щ	<u> </u>
		Ш	$\checkmark$
If Yes, identify the wetland or waterbody and extent of alterations in square feet or acres:  The wetland area on site has been determined to be unregulated.			
	-	7-47	31 -1
			-

14. Identify the typical habitat types that occur on, or are likely to be found on the project site. Check all that apply:		
Shoreline  Forest  Agricultural/grasslands  Early mid-successional		
☑ Wetland □ Urban □ Suburban		
15. Does the site of the proposed action contain any species of animal, or associated habitats, listed by the State or	NO	YES
Federal government as threatened or endangered?	<b>✓</b>	
16. Is the project site located in the 100-year flood plan?	NO	YES
	<b>✓</b>	
17. Will the proposed action create storm water discharge, either from point or non-point sources?	NO	YES
If Yes,		<b>√</b>
a. Will storm water discharges flow to adjacent properties?	$\checkmark$	
b. Will storm water discharges be directed to established conveyance systems (runoff and storm drains)? If Yes, briefly describe:		$\checkmark$
		1
The use of catch basins and down spouts will direct all stormwater from impervious areas to traditional stormwater treatment facilities and will be designed in accordance with all the applicable NYSDEC stormwater regulations. Following proper treatment, stormwater will be discharged via injection wells.		
18. Does the proposed action include construction or other activities that would result in the impoundment of water	NO	YES
or other liquids (e.g., retention pond, waste lagoon, dam)?  If Yes, explain the purpose and size of the impoundment:		
11 Tes, explain the purpose and size of the impoundment.		
	_	
19. Has the site of the proposed action or an adjoining property been the location of an active or closed solid waste	NO	YES
management facility?  If Yes, describe:		
11 1 65, describe.		
		,===,
20. Has the site of the proposed action or an adjoining property been the subject of remediation (ongoing or	NO	YES
completed) for hazardous waste?		
If Yes, describe: DEC ID number 915243: Remediation site was a result of a fire to the facility adjacent to the project where		
hazardous waste was stored. Groundwater and soil samples were obtained after the fire at the facility, which were not above the allowable limits. The site was properly closed with no further action needed.		<b>.</b>
I CERTIFY THAT THE INFORMATION PROVIDED ABOVE IS TRUE AND ACCURATE TO THE BE	ST OF	
MY KNOWLEDGE	75	
Applicant/sponsor/name Michael J-Met 250 / VE Date: 1/15/3		
Signature:	4	_
- ~ (/		



Part 1 / Question 7 [Critical Environmental Area]	No
Part 1 / Question 12a [National or State Register of Historic Places or State Eligible Sites]	No
Part 1 / Question 12b [Archeological Sites]	Yes
Part 1 / Question 13a [Wetlands or Other Regulated Waterbodies]	Yes - Digital mapping information on local and federal wetlands and waterbodies is known to be incomplete. Refer to EAF Workbook.
Part 1 / Question 15 [Threatened or Endangered Animal]	No
Part 1 / Question 16 [100 Year Flood Plain]	No
Part 1 / Question 20 [Remediation Site]	Yes



**APPLICANT REQUEST:** 

# **Request for Action**

Town of Clarence | Office of Planning & Zoning (716)741-8933 | 1 Town Place, Clarence, NY 14031

Town	llea	Onl	١.
IOWII	USE		V

Date:

Received By:

Project Address: 0 Research Parkway

**SBL** #: 83.00-3-31, sublot #5

#### **Action Desired:**

Concept Plan approval for an industrial building focusing on distribution, warehousing, and light manufacturing.

#### Reason:

Further expansion of an established manufacturing business in the town.

# APPLICANT INFO

Name / Business: Metzger Civil Engineering on behalf of Stephen Development

E-Mail: meteng@roadrunner.com

Phone #: 716-633-2601

Address: 8245 Sheridan Dr

Town: Williamsville State: NY zip: 14221

### PROJECT SPONSOR INFO (If Different Than Applicant)

Name / Business: Metzger Civil Engineering

E-Mail: meteng@roadrunner.com

Phone #: 716-633-2601

Address: 8245 Sheridan Dr

Town: Williamsville State: NY Zip: 14221

#### **SIGNATURE**

Request for Action shall be filled out completely in the spaces provided. The complete Request for Action shall be submitted to the Office of Planning and Zoning along with all necessary plans, maps, and supporting documentation. By signing below I certify that I have the authority to submit this Request for action, and further certify its contents of the and correct.

Signed:

## CORRESPONDENCE

Please indicate the preferred entity that shall receive the appropriate correspondence and billing associated with this Request for Action.

Please select only one.

_		
	Applicant	
7	Project Sponsor	

# Town Use Only:

CONTACT INFO

Andion	_	_	_	
Action:	By:	On:	Fee:	Paid:
Action:	By:	On:	Fee:	Paid:
Action:	By:	On:	Fee:	Paid:
Action:	Ву:	On:	Fee:	Paid:
Action:	Ву:	On:	Fee:	Paid:
Action:	Ву:	On:	Fee:	Paid:



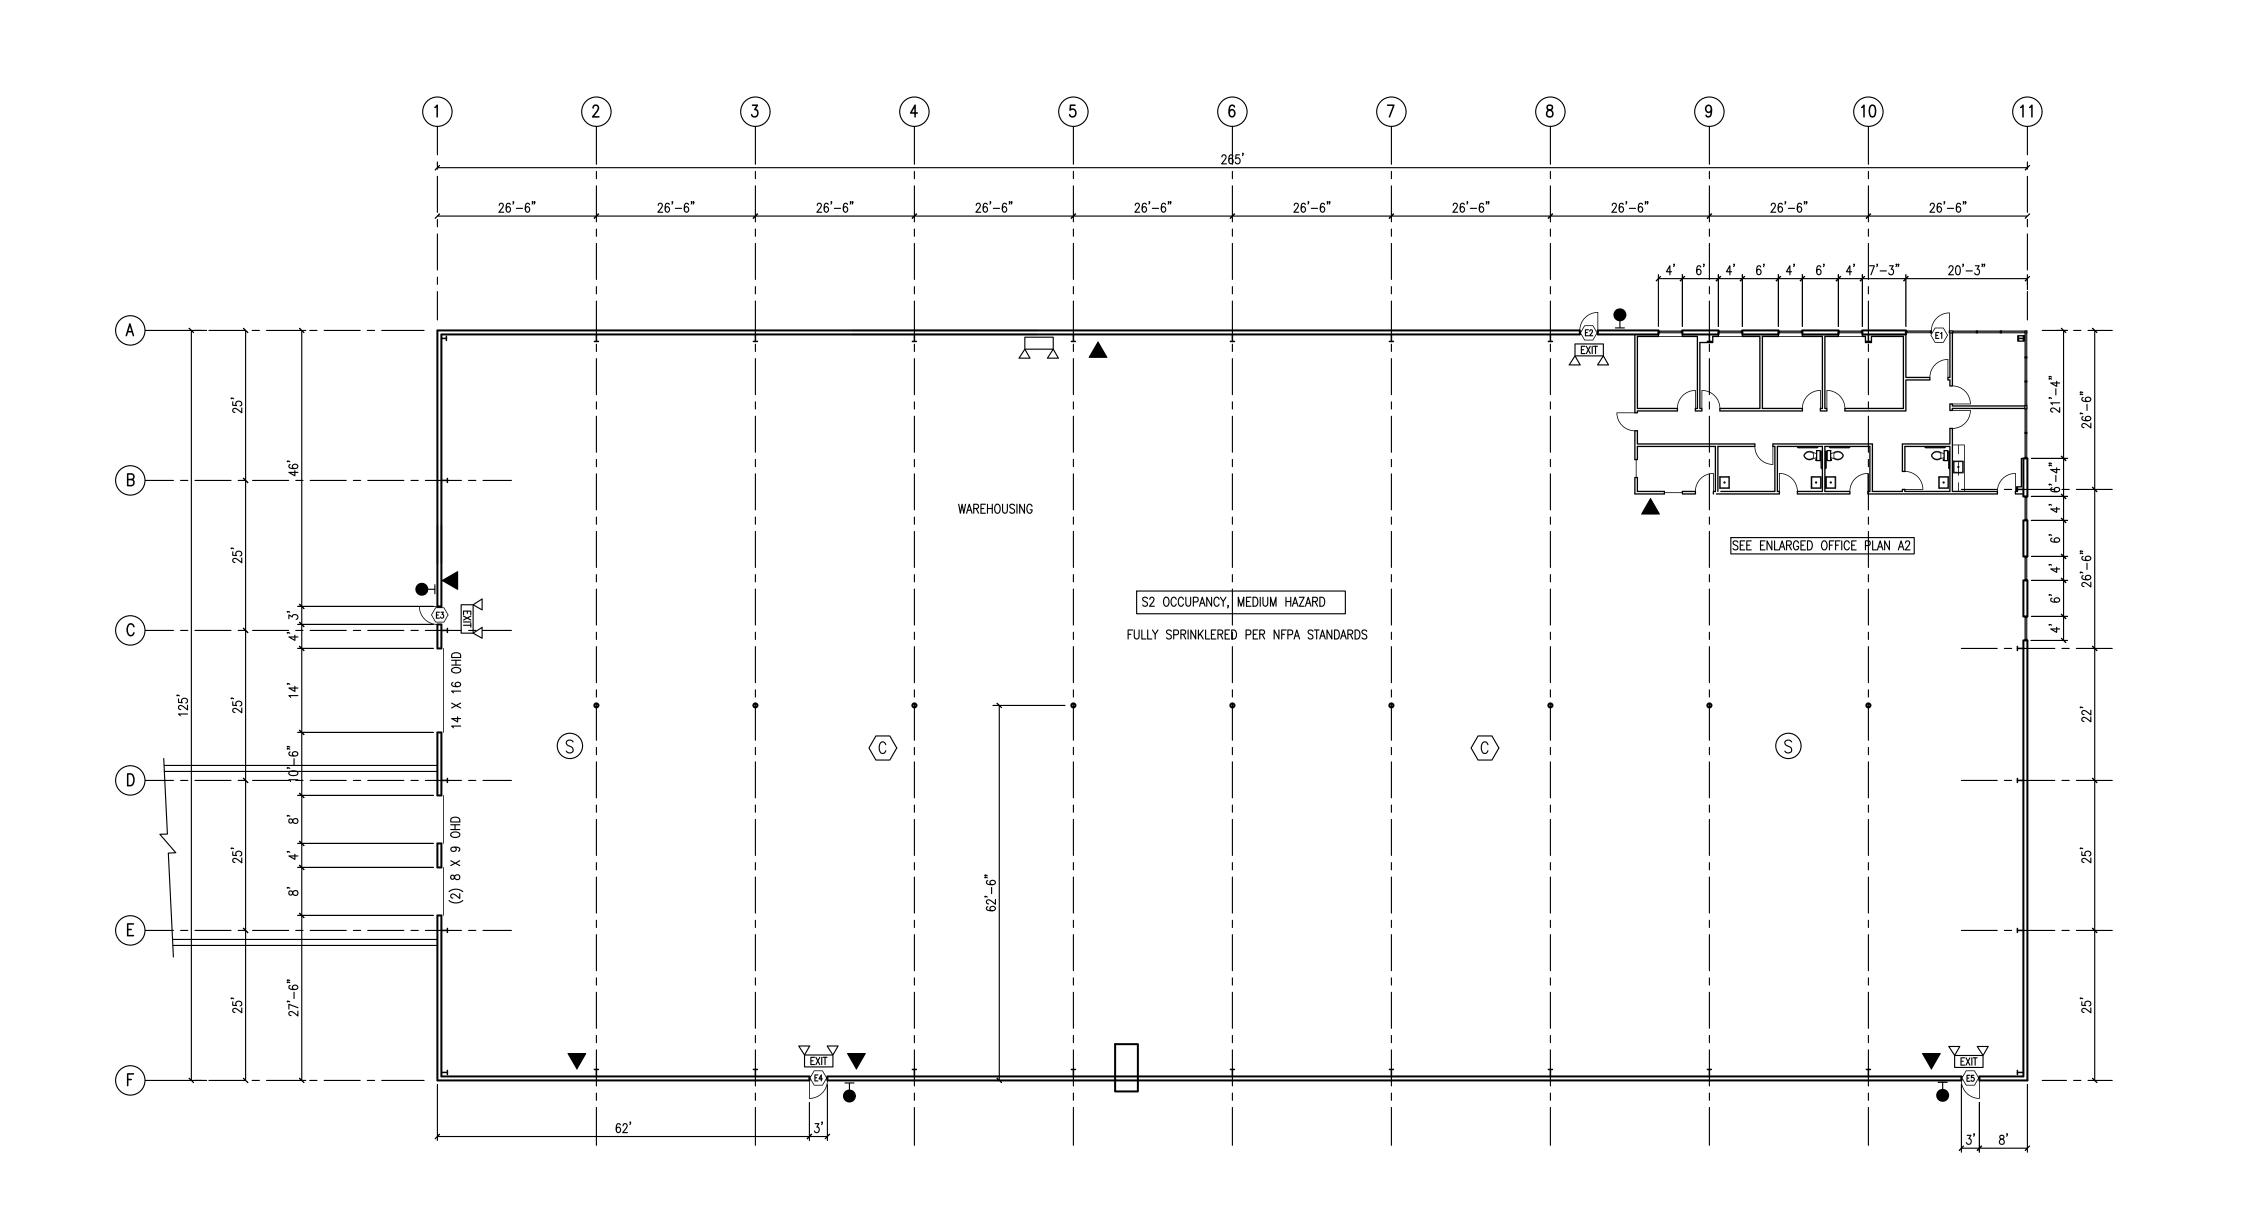










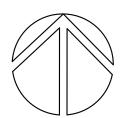


# FLOOR PLAN

1/16" = 1'-0"

# GENERAL NOTES

- 1. ALL WORK SHALL CONFORM TO APPLICABLE LOCAL, STATE AND FEDERAL CODES AS INTERPRETED BY AUTHORITIES HAVING JURISDICTION
- 2. CONTRACTOR SHALL BE RESPONSIBLE FOR FIELD VERIFICATION OF DIMENSIONS
- 3. BUILDING IS A PRE-ENGINEERED METAL BUILDING MANUFACTURED BY NUCOR BUILDINGS
- 4. ALL LAVATORIES ARE ADA COMPLIANT.
- 5. ADA COMPLIANT SIGNAGE WHERE REQUIRED.



# EMERGENCY LIGHTING EMERGENCY/EXIT COMBO FIRE EXTINGUISHER EXTERIOR REMOTE EMERGENCY LIGHT SMOKE DETECTOR

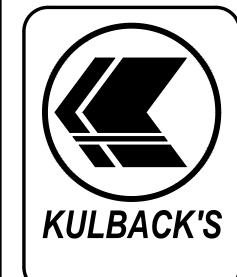
LEGEND

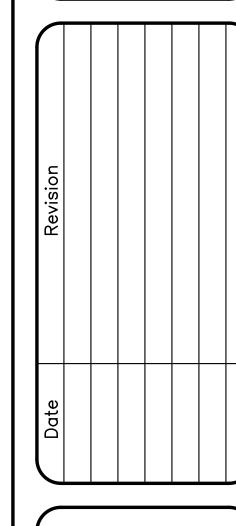
CARBON MONOXIDE DETECTOR

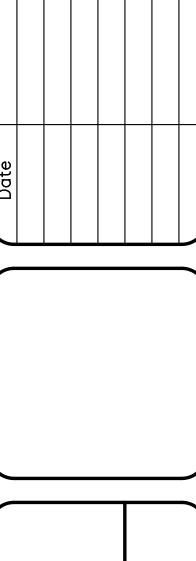
# OCCUPANCY DESIGN CRITERIA

OCCUPANCY CLASSIFICATION	B, S2
BUILDING CONSTRUCTION TYPE	2B
TOTAL No. OF FLOORS	1
BUILDING AREA	33,125 S.F.
NUMBER OF EMPLOYEES	7

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Manufacturing arkway Clarence,

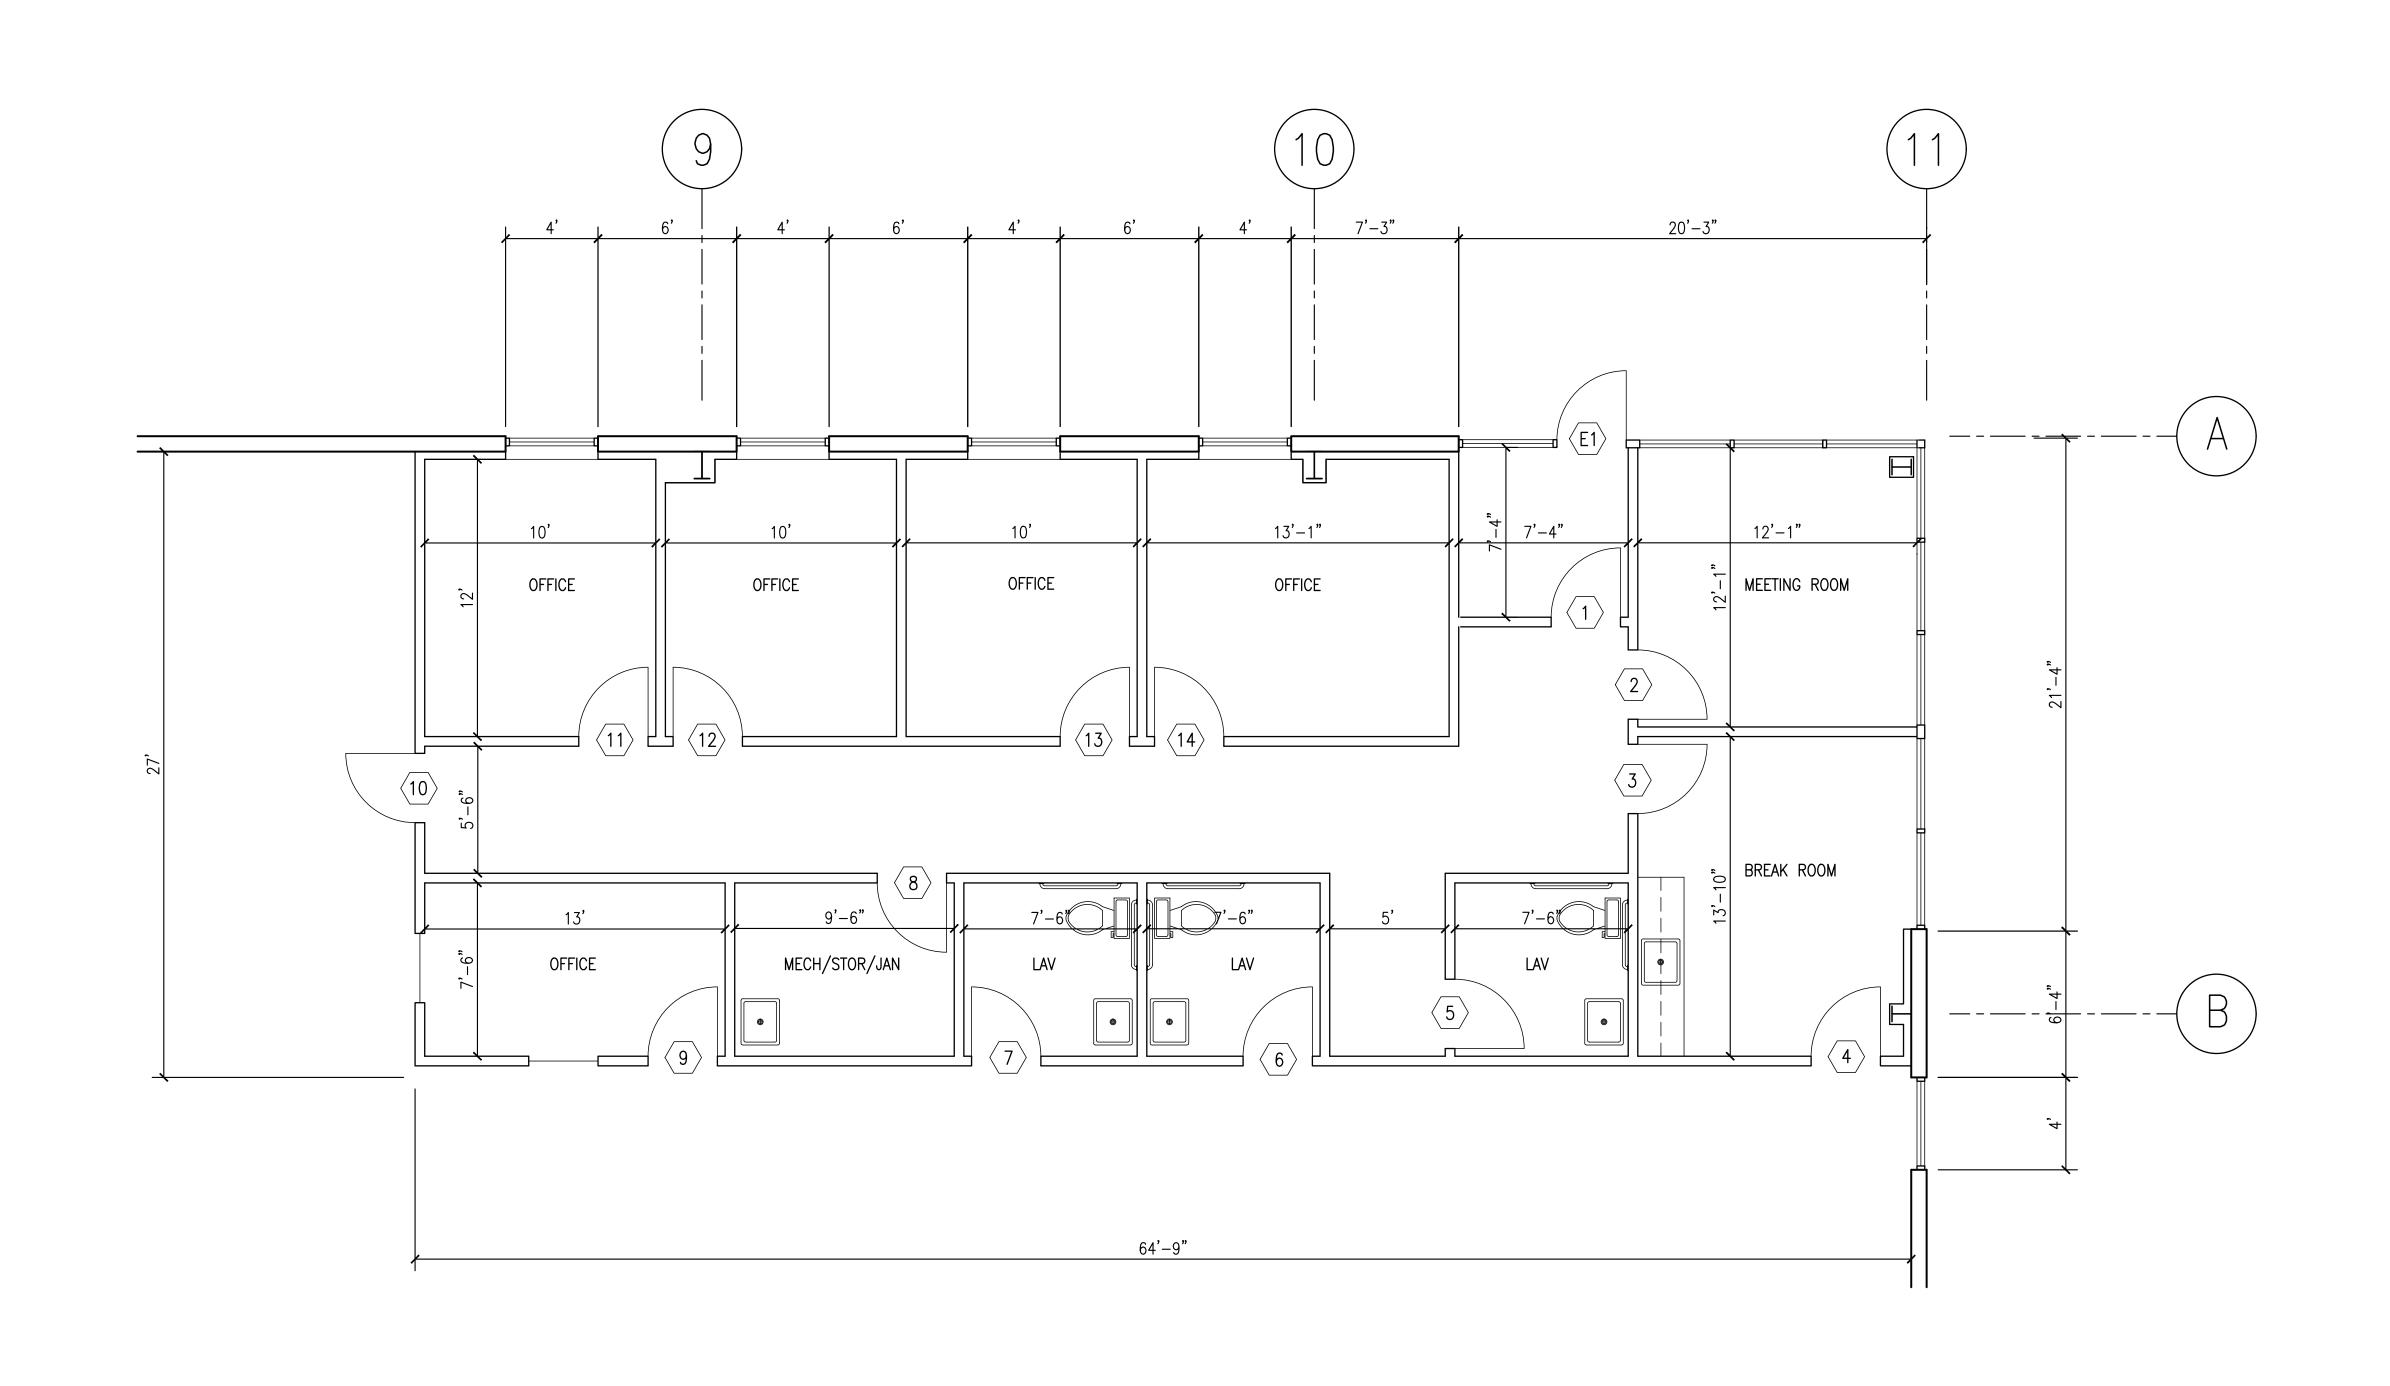
**Dimar** Research P

<u>H</u>0

Drawn HCS

12-24 Scale AS NOTED

Project No.





FULLY SPRINKLERED (ACCESSORY USE)

1/4" = 1' - 0"

# GENERAL NOTES

- 1. ALL WORK SHALL CONFORM TO APPLICABLE LOCAL, STATE AND FEDERAL CODES AS INTERPRETED BY AUTHORITIES HAVING JURISDICTION
- 2. CONTRACTOR SHALL BE RESPONSIBLE FOR FIELD VERIFICATION OF DIMENSIONS
- BUILDING IS A PRE-ENGINEERED METAL BUILDING MANUFACTURED BY NUCOR BUILDINGS REFER TO NUCOR DRAWINGS FOR ANCHOR BOLT LAYOUT AND SIZE
- 4. ALL LAVATORIES ARE ADA COMPLIANT.
- 5. ADA COMPLIANT SIGNAGE WHERE REQUIRED.



EMERGENCY LIGHTING

EMERGENCY/EXIT COMBO

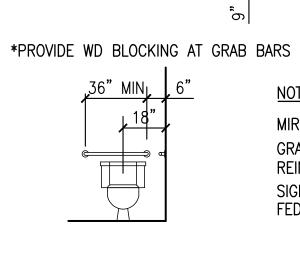
SMOKE DETECTOR

CARBON MONOXIDE DETECTOR

101 ROOM NUMBER FIRE EXTINGUISHER, 75' TRAVEL MAX

ILLUMINATED EXIT SIGN

EXTERIOR REMOTE EMERGENCY LIGHT



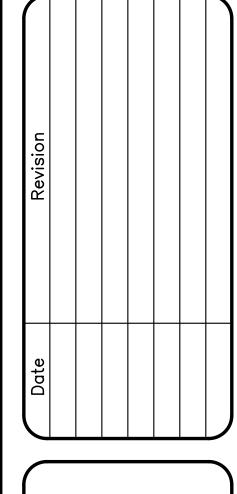
4'-0" CLEAR FLOOR SPACE

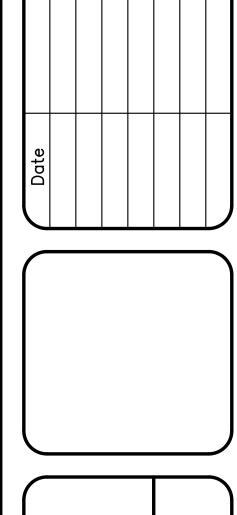
MIRROR -2'-0" X 3'-0" (3'-4" A.F.F.) - IF REQ'D GRAB BARS — 1 1/2" DIA. 33" — 36" A.F.F REINFORCE WALL WITH WOOD BLOCKING SIGNAGE SHALL COMPLY WITH ALL LOCAL AND FEDERAL REGULATIONS

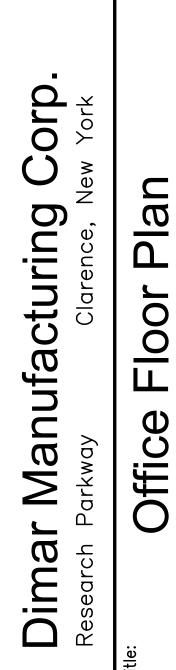
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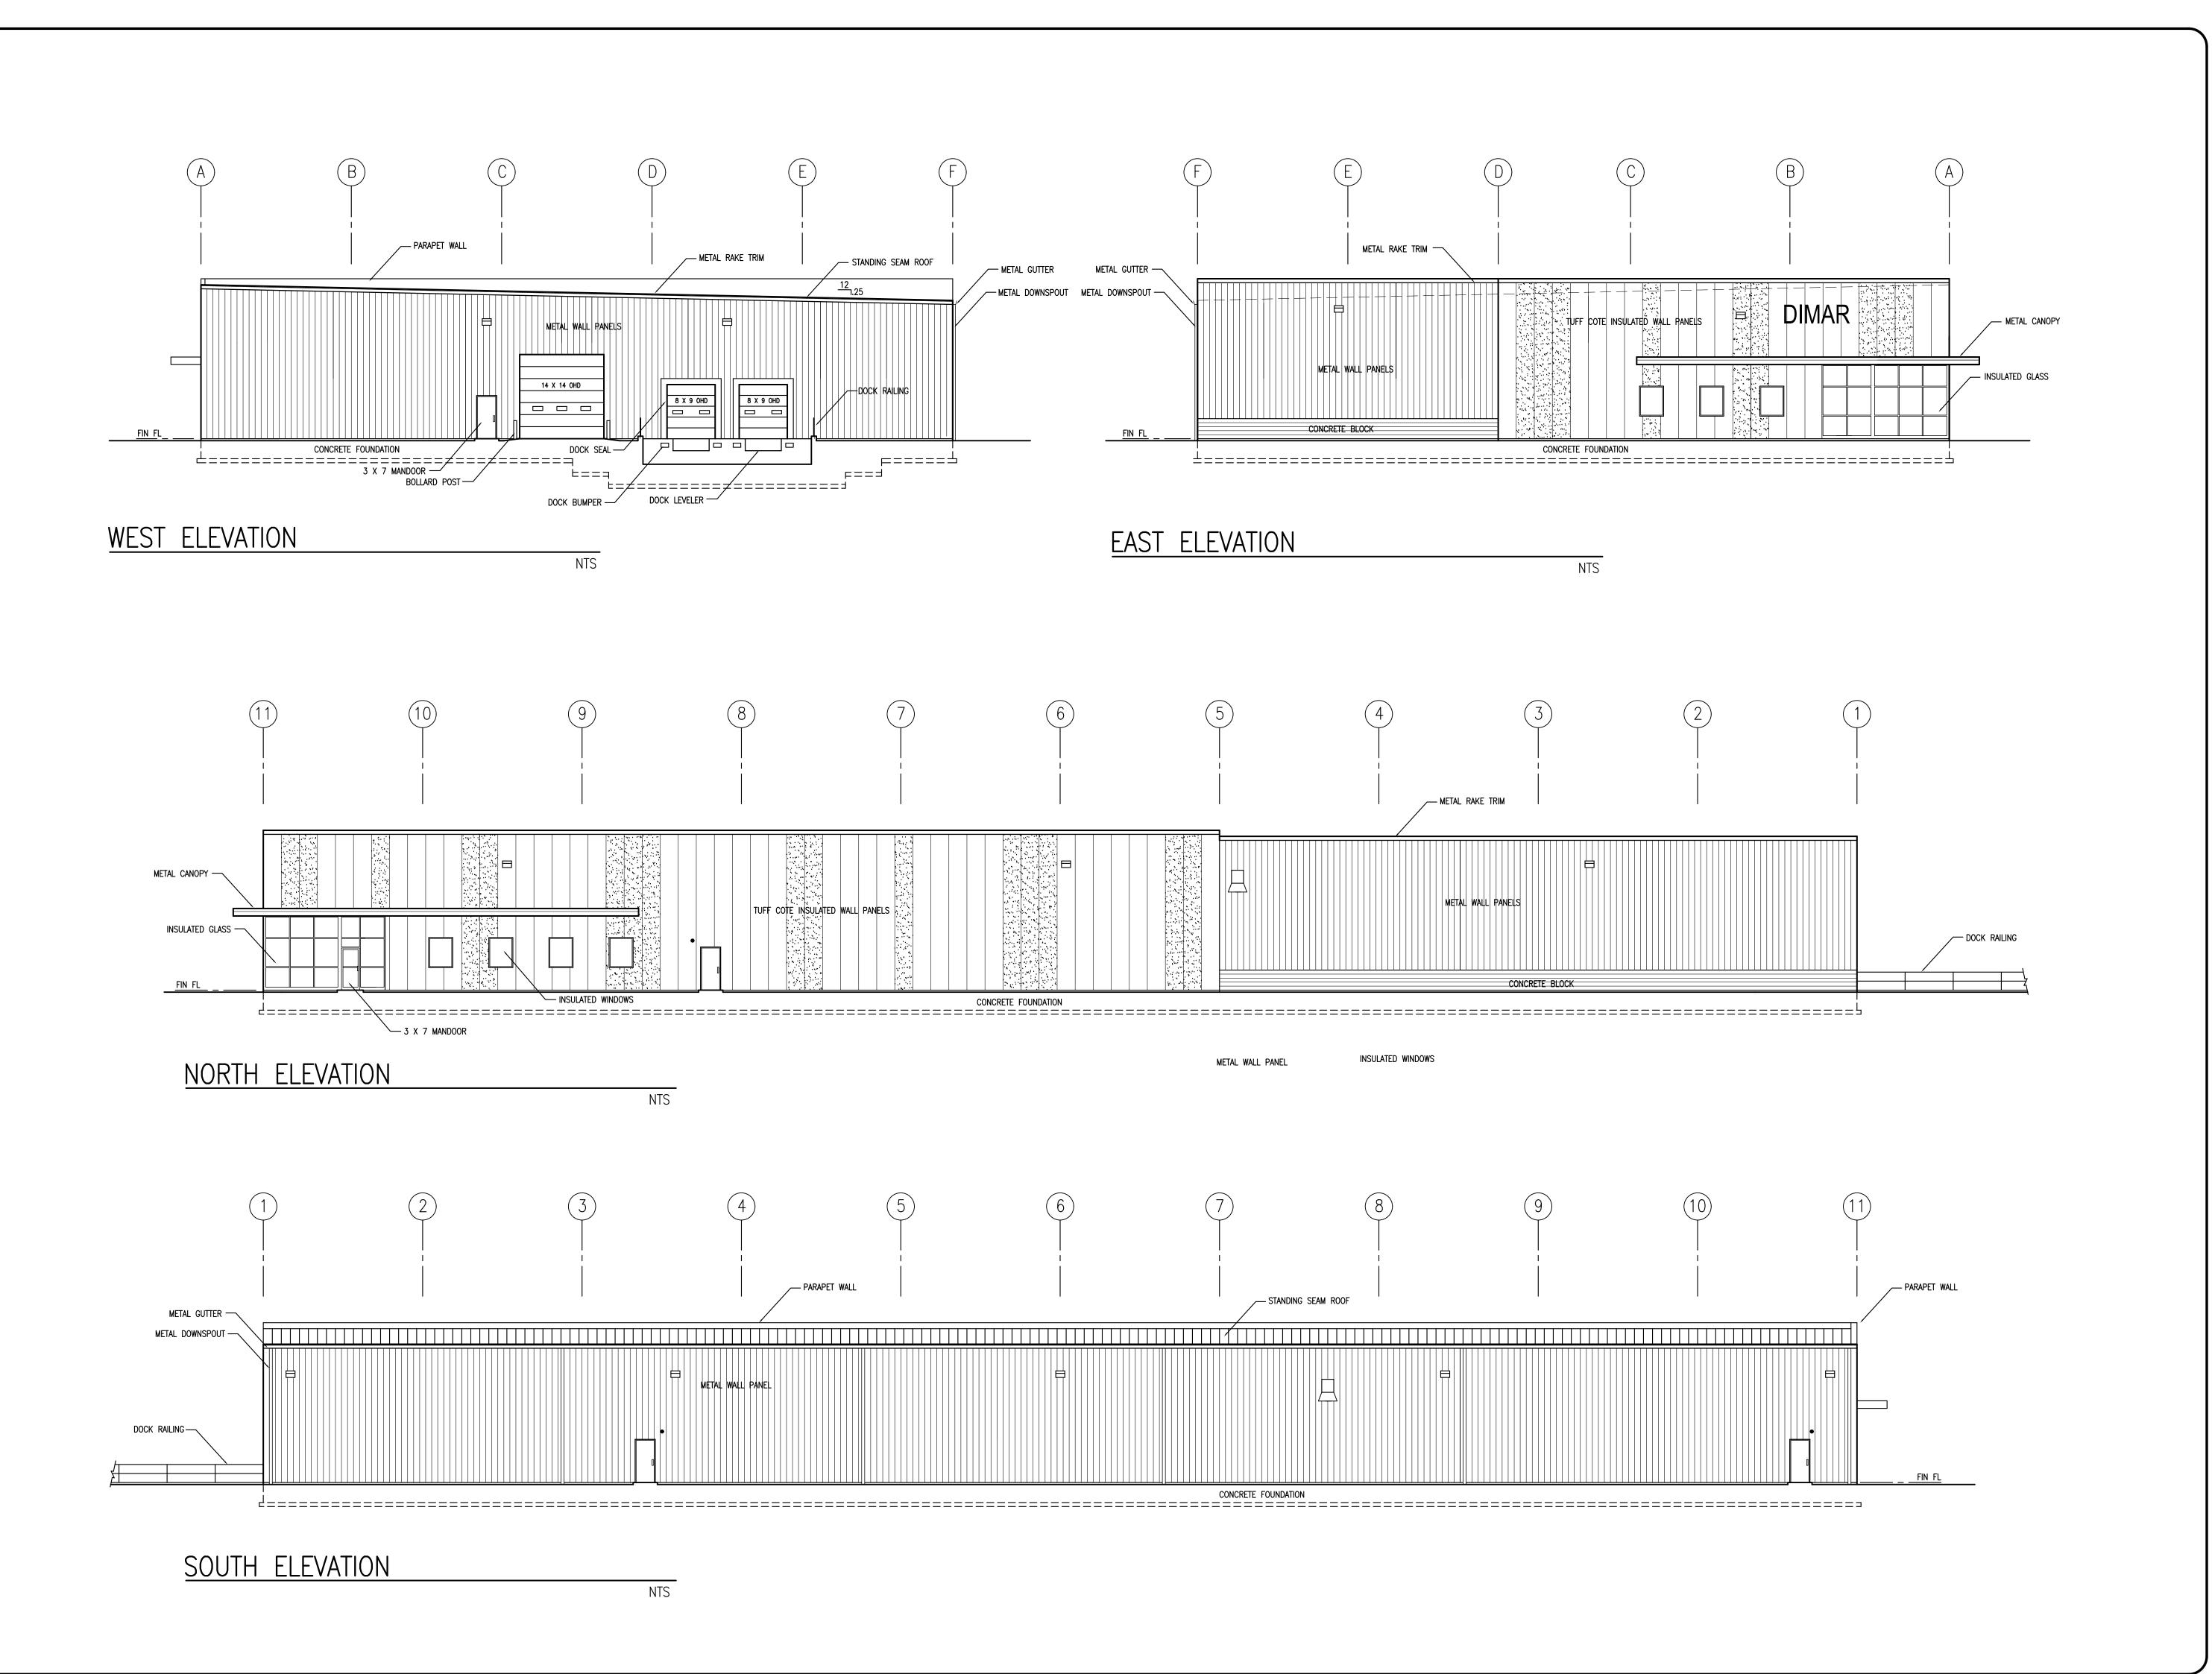








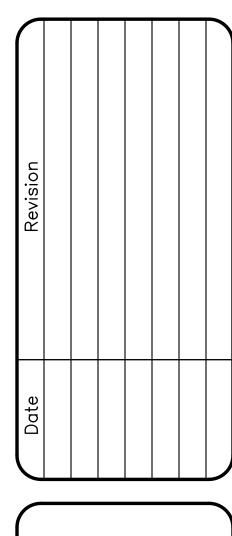
Drawn	HCS	She
Checked	d	
Date	12-24	1 0
Scale	AS NOTED	
Project	No.	



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Corp

Manufacturing Building Dimar

Checked 12-24