





NOTICE

6,100 SF 6,100 SF

11,810 SF 13,760 SF

24,339 SF 1,928 SF 26,267 SF

17,895 SF

83,574 SF 62,963 SF (75%)

20,611 SF (25%)

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TOWNHOMES & APARTMENT BUILDINGS

|8560-8568 MAIN STREET| CLARENCE, NY

ISSUE:

SA PROJECT TEAM: PRINCIPAL P.Silvestri PROJ. ARCH. _____ DRAFTER ___ JOB CAPT. **INTERIORS**

TITLE:

PROPOSED BUILDING 3 FLOOR PLANS



1321 MILLERSPORT HWY PH. 716.691.0900 AMHERST, NY 14221 FAX 716.691.4773

SA JOB #: 23084.01

TOTAL

10

DATE: 05-13-24

A-101



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UNIT B UNIT B UNIT A 2 BED, 2 BATH 2 BED, 1 BED, ∃ 2 BATH 1 BATH UNIT C 1 BED, 1 BATH UNIT C 1 BED, 1 BATH UNIT A UNIT B STAIR 2 BED, 2 BATH MECH./ ELECT. STOR.

C1 PROPOSED BUILDING 3 | THIRD FLOOR PLAN

BUILDING DATA TABLE

EXISTING BUILDING 1 - RESIDENTIAL BUILDING 6,100 SF 6,100 SF 6 RESIDENTIAL DWELLING UNITS TOTAL BUILDING FLOOR AREA

EXISTING BUILDING 2 - MIXED USE BUILDING 2 RESIDENTIAL DWELLING UNITS 11,810 SF 13,760 SF COMMERCIAL SPACE TOTAL BUILDING FLOOR AREA

PROPOSED BUILDING 3 - 3 STORY MIXED USE BUILDING 24,339 SF 19 DWELLING UNITS 1,928 SF 26,267 SF COMMERCIAL SPACE TOTAL BUILDING FLOOR AREA

PROPOSED BUILDING 4 - 3 STORY MIXED USE BUILDING14 DWELLING UNITS 17,895 SF COMMERCIAL SPACE TOTAL BUILDING FLOOR AREA

PROPOSED BUILDING 5 - 2 STORY TOWNHOUSE 8 DWELLING UNITS TOTAL BUILDING FLOOR AREA

TOTAL SITE SQUARE FOOTAGE RESIDENTIAL SPACE 83,574 SF 62,963 SF (75%) COMMERCIAL SPACE 20,611 SF (25%) NOTICE

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DATE: SA JOB #: 23084.01 05-13-24

DRAWING #:

A-101b

BUILDING 3 - SUMMARY OF UNITS

ROOM TYPE	LEVEL			TOTAL	
KOOM TIPE	1st	2nd	3rd		
1 BEDROOM	2	4	4	10	
2 BEDROOM	3	3	3	9	
TOTAL	5	7	7	19	



Full Environmental Assessment Form Part 1 - Project and Setting

Instructions for Completing Part 1

Part 1 is to be completed by the applicant or project sponsor. Responses become part of the application for approval or funding, are subject to public review, and may be subject to further verification.

Complete Part 1 based on information currently available. If additional research or investigation would be needed to fully respond to any item, please answer as thoroughly as possible based on current information; indicate whether missing information does not exist, or is not reasonably available to the sponsor; and, when possible, generally describe work or studies which would be necessary to update or fully develop that information.

Applicants/sponsors must complete all items in Sections A & B. In Sections C, D & E, most items contain an initial question that must be answered either "Yes" or "No". If the answer to the initial question is "Yes", complete the sub-questions that follow. If the answer to the initial question is "No", proceed to the next question. Section F allows the project sponsor to identify and attach any additional information. Section G requires the name and signature of the applicant or project sponsor to verify that the information contained in Part 1 is accurate and complete.

A. Project and Applicant/Sponsor Information.

Name of Action or Project: Mixed Use Redevelopment of multiple parcels				
Project Location (describe, and attach a general location map):				
8560-8574 Main Street (6 parcels total - see attached parcel map with submittal package for f	urther details with SBL numbers)			
Brief Description of Proposed Action (include purpose or need):				
The redevelopment of these parcels will require multiple approvals from the Town of Clarence including: (1) an area variance to allow the 3-story buildings; (2) five Special Exception Use Permits (SEUP) to allow multi-family dwelling units in TND zoning, a drive-thru, and buildings between 10,000 - 30,000 SF; (3) rezoning of a portion of the project from RSF to TND; and concept plan approval, development plan approval and final architectural approval.				
The redevelopment project will comprise six parcels including 8560, 8564, 8568 and 8574 Marnap is attached to this EAF for further details. Together, the development will consist of five existing mixed use building (to be partially demolished); (3) 3-story mixed use building (will conformer cial space on the first floor); (4) 3-story mixed use building (will contain 14 dwelling space on the first floor); (5) 8-unit upscale townhouse. The existing building at 8568 Main Street.	puildings including: (1) existing 6-un ntain 19 dwelling units and approxir runits and approximately 6,873 squ	it apartment building; (2) nately 1,928 square feet are feet of commercial		
Name of Applicant/Sponsor:	Telephone: 716-633-2601			
Metzger Civil Engineering, PLLC on behalf of Visone Bros, Inc.	E-Mail: meteng@roadrunner.com			
Address: 8245 Sheridan Drive				
City/PO: Williamsville	State: NY	Zip Code: 14221		
Project Contact (if not same as sponsor; give name and title/role):	Telephone:			
SAME AS SPONSOR	E-Mail:			
Address:				
City/PO:	State:	Zip Code:		
Property Owner (if not same as sponsor):	Telephone: 716-759-1715			
DLV Properties, LLC	E-Mail: lou@visoneco.com			
Address: 9829 Main Street				
City/PO: Clarence	State: NY	Zip Code: ₁₄₀₃₁		

B. Government Approvals

B. Government Approvals, Funding, or Sponsorship. ("Funding" includes grants, loans, tax relief, and any other forms of financial assistance.)				
Government Entity	If Yes: Identify Agency and Approval(s) Required	Application Date (Actual or projected)		
a. City Counsel, Town Board, ☑ Yes No or Village Board of Trustees	Architectural Approval; Rezone; SEUP	March 2024		
b. City, Town or Village ✓Yes□No Planning Board or Commission	Concept Approval; Development Approval; SEUP; rezoning and architectural recommendations	March 2024		
c. City, Town or ✓ Yes□No Village Zoning Board of Appeals	Area Variance	March 2024		
d. Other local agencies ☐Yes☑No				
e. County agencies ☑Yes☐No	ECHD Septic Approval ECWA RPZ Approval	July 2024 (P) July 2024 (P)		
f. Regional agencies ☐Yes☑No				
g. State agencies ✓ Yes□No	NYSDOT Highway Work Permit NYSDEC Stormwater Permit & septic SPDES	July 2024 (P) July 2024 (P)		
h. Federal agencies ☐Yes☑No				
i. Coastal Resources.i. Is the project site within a Coastal Area, or	r the waterfront area of a Designated Inland W	/aterway?	□Yes ☑ No	
ii. Is the project site located in a community with an approved Local Waterfront Revitalization Program?iii. Is the project site within a Coastal Erosion Hazard Area?			☐ Yes☑No ☐ Yes☑No	
C. Planning and Zoning				
C.1. Planning and zoning actions.				
Will administrative or legislative adoption, or amendment of a plan, local law, ordinance, rule or regulation be the only approval(s) which must be granted to enable the proposed action to proceed? ■ If Yes, complete sections C, F and G. ■ If No, proceed to question C.2 and complete all remaining sections and questions in Part 1				
C.2. Adopted land use plans.				
a. Do any municipally- adopted (city, town, vil where the proposed action would be located?	lage or county) comprehensive land use plan(s) include the site	✓ Yes□No	
If Yes, does the comprehensive plan include spewould be located?	ecific recommendations for the site where the p	proposed action	∠ Yes□No	
b. Is the site of the proposed action within any I Brownfield Opportunity Area (BOA); design or other?) If Yes, identify the plan(s): NYS Heritage Areas:West Erie Canal Corridor	ocal or regional special planning district (for eated State or Federal heritage area; watershed	example: Greenway; management plan;	∠ Yes No	
c. Is the proposed action located wholly or part or an adopted municipal farmland protection If Yes, identify the plan(s):	ially within an area listed in an adopted munic n plan?	ipal open space plan,	∐Yes Z No	

C2 Zaring	
C.3. Zoning	
a. Is the site of the proposed action located in a municipality with an adopted zoning law or ordinance. If Yes, what is the zoning classification(s) including any applicable overlay district? Residential Single Family (RSF) & Traditional Neighborhood (TND)	Yes□No
b. Is the use permitted or allowed by a special or conditional use permit?	Yes No
c. Is a zoning change requested as part of the proposed action? If Yes, i. What is the proposed new zoning for the site? Portion of the property to be rezoned to: Traditional Neighborhood (TND)	Yes□No
C.4. Existing community services.	
a. In what school district is the project site located? Clarence Central School District	
b. What police or other public protection forces serve the project site? NYS Police: Erie County Sheriff's Office	
c. Which fire protection and emergency medical services serve the project site? Harris Hill Volunteer Fire Company	
d. What parks serve the project site? <u>Clarence Town Park; Sunset Park</u>	
D. Project Details	
D.1. Proposed and Potential Development	
a. What is the general nature of the proposed action (e.g., residential, industrial, commercial, recreational; if mixed, incomponents)? Mixed use of commercial businesses and multi-family	lude all
b. a. Total acreage of the site of the proposed action? b. Total acreage to be physically disturbed? c. Total acreage (project site and any contiguous properties) owned or controlled by the applicant or project sponsor? 7.2 acres 7.2 acres	
c. Is the proposed action an expansion of an existing project or use? i. If Yes, what is the approximate percentage of the proposed expansion and identify the units (e.g., acres, miles, house square feet)? % 500 Units: housing units	Yes No sing units,
d. Is the proposed action a subdivision, or does it include a subdivision? If Yes, i. Purpose or type of subdivision? (e.g., residential, industrial, commercial; if mixed, specify types)	Yes Z No
ii. Is a cluster/conservation layout proposed?iii. Number of lots proposed?iv. Minimum and maximum proposed lot sizes? Minimum Maximum]Yes □No
e. Will the proposed action be constructed in multiple phases? i. If No, anticipated period of construction: ii. If Yes: • Total number of phases anticipated • Anticipated commencement date of phase 1 (including demolition) • Anticipated completion date of final phase • Generally describe connections or relationships among phases, including any contingencies where progress of determine timing or duration of future phases: The phasing will occur based on market demands.	

		1 1 0			∠ Yes No
	et include new resid				MI i es I No
If Yes, show nun	bers of units propo		Three Family	Multiple Family (four or more)	
	One Family	<u>Two Family</u>	Infee Family	wuttiple rainity (tour or more)	
Initial Phase				41	
At completion				44	
of all phases				41	
g. Does the prope	sed action include	new non-residenti	al construction (inclu	iding expansions)?	✓ Yes No
If Yes,	osed action include	new non-residenti	ar construction (mon	ading expansions).	
	of structures	2			
ii. Dimensions (in feet) of largest p	roposed structure:	35± height;	60± width; and 145± length	
iii. Approximate	extent of building	space to be heated	or cooled:	100% square feet	
h Does the prope	osed action include	construction or oth	ner activities that wil	l result in the impoundment of any	☐Yes Z No
liquids, such a	s creation of a wate	r supply, reservoir	, pond, lake, waste l	agoon or other storage?	
If Yes,			,, ,		
i. Purpose of the	e impoundment:				
ii. If a water imp	oundment, the prin	cipal source of the	water:	Ground water Surface water stream	ms Other specify:
iii. If other than	water, identify the ty	ype of impounded	contained liquids an	d their source.	
	-: C41	d imm arm due out	Volumet	million gallons: surface area!	acres
iv. Approximate	size of the propose	a impoundment.	volume:	million gallons; surface area:height;length	acics
v. Difficustions	method/materials	for the proposed d	am or impounding st	ructure (e.g., earth fill, rock, wood, cond	crete):
vi. Construction	memod materials	for the proposed di	am or impounding se		
×					
D.2. Project Op	erations				
		any excavation m	ining or dredging d	luring construction, operations, or both?	Yes√No
(Not including	general site prepar	ation orading or it	nstallation of utilities	s or foundations where all excavated	
materials will		ation, grading or in	istantation of attitue	01 10 till 2010 111 21 2 till 211 211 211 211 211 211 211 211 211 2	
If Yes:	••••••				
i. What is the p	urpose of the excav	ation or dredging?			
ii. How much ma	nterial (including ro	ck, earth, sedimen	ts, etc.) is proposed t	to be removed from the site?	
Over w.	hat duration of time	?			
iii. Describe natu	re and characteristi	cs of materials to	be excavated or dred	ged, and plans to use, manage or dispos	e of them.
					Yes No
		or processing of e	xcavated materials?		
If yes, descr	ibe				
What is that	otal area to be dred	rad or executed?		acres	
v. What is the r	naximum area to be	ged of excavated:	e time?	acres	
wii What would	he the maximum de	enth of excavation	or dredging?	feet	
	avation require blas		or drouging.		∏Yes∏No
		•			
b. Would the pro	posed action cause	or result in alterat	ion of, increase or de	ecrease in size of, or encroachment	☐ Yes / No
			ach or adjacent area		
If Yes:		•	-		
i. Identify the	wetland or waterboo	dy which would be	e affected (by name,	water index number, wetland map numb	per or geographic
:					

ii. Describe how the proposed action would affect that waterbody or wetland, e.g. excavation, fill, placement of s	tructures, or
alteration of channels, banks and shorelines. Indicate extent of activities, alterations and additions in square fee	et or acres:
iii. Will the proposed action cause or result in disturbance to bottom sediments?	□Yes□No
If Yes, describe:	
iv. Will the proposed action cause or result in the destruction or removal of aquatic vegetation?	☐ Yes ☐ No
If Yes:	
acres of aquatic vegetation proposed to be removed:	
 expected acreage of aquatic vegetation remaining after project completion: purpose of proposed removal (e.g. beach clearing, invasive species control, boat access): 	
proposed method of plant removal:	
if chemical/herbicide treatment will be used, specify product(s):	
v. Describe any proposed reclamation/mitigation following disturbance:	
c. Will the proposed action use, or create a new demand for water?	Z Yes □No
If Yes:	
i. Total anticipated water usage/demand per day:15,536 gallons/day	
ii. Will the proposed action obtain water from an existing public water supply?	✓ Yes No
If Yes:	
Name of district or service area:	
 Does the existing public water supply have capacity to serve the proposal? 	✓ Yes No
Is the project site in the existing district?	✓ Yes No
Is expansion of the district needed?	Yes 🖊 No
• Do existing lines serve the project site?	✓ Yes ☐ No
iii. Will line extension within an existing district be necessary to supply the project?	☐Yes Z No
If Yes:	
Describe extensions or capacity expansions proposed to serve this project:	
Source(s) of supply for the district:	
iv. Is a new water supply district or service area proposed to be formed to serve the project site?	☐ Yes ✓ No
If, Yes:	
Applicant/sponsor for new district:	
Date application submitted or anticipated:	
Proposed source(s) of supply for new district:	
v. If a public water supply will not be used, describe plans to provide water supply for the project:	
	-1
vi. If water supply will be from wells (public or private), what is the maximum pumping capacity: gallon	is/minute.
d. Will the proposed action generate liquid wastes?	✓ Yes ☐ No
If Yes:	
i. Total anticipated liquid waste generation per day: 15,536 gallons/day	
ii. Nature of liquid wastes to be generated (e.g., sanitary wastewater, industrial; if combination, describe all comp	onents and
approximate volumes or proportions of each):	
Domestic sanitary sewerage generated from the residential uses as well as commercial uses.	
	☐ Yes Z No
iii. Will the proposed action use any existing public wastewater treatment facilities?	□ I es MINO
If Yes:	
Name of wastewater treatment plant to be used: Name of literature.	
Name of district: Department the project of the project?	□Yes□No
Does the existing wastewater treatment plant have capacity to serve the project? In the appropriate site in the existing district?	☐ Yes ☐No
Is the project site in the existing district? In any appear of the district product?	☐ Yes ☐No
Is expansion of the district needed?	

•	Do existing sewer lines serve the project site?	□Yes□No
•	Will a line extension within an existing district be necessary to serve the project?	□Yes□No
	If Yes:	
	Describe extensions or capacity expansions proposed to serve this project:	
iv. Wi	ill a new wastewater (sewage) treatment district be formed to serve the project site?	□Yes Z No
If `	Yes:	
•	Applicant/sponsor for new district:	
•	Date application submitted or anticipated:	
	What is the receiving water for the wastewater discharge?	
ν Ifr	bublic facilities will not be used, describe plans to provide wastewater treatment for the project, including speci	fying proposed
re	ceiving water (name and classification if surface discharge or describe subsurface disposal plans):	
ΔII	generated domestic wastewater from the project will be treated and disposed of on-site through a septic system. The system	will be designed and
vill real	uire approval by the ECHD.	
vi De	escribe any plans or designs to capture, recycle or reuse liquid waste:	
4.	VA	
-		
e. Wil	Il the proposed action disturb more than one acre and create stormwater runoff, either from new point	Z Yes □ No
SOII	arces (i.e. ditches, pipes, swales, curbs, gutters or other concentrated flows of stormwater) or non-point	
SO	urce (i.e. sheet flow) during construction or post construction?	
If Yes		
	ow much impervious surface will the project create in relation to total size of project parcel?	
<i>t</i> . 110	Square feet or 3.5 acres (impervious surface)	
	Square feet or acres (parcel size)	
# De	escribe types of new point sources. Stormwater generated from impervious surface runoff.	
ii. De	section types of new point sources	
::: 117	here will the stormwater runoff be directed (i.e. on-site stormwater management facility/structures, adjacent pro-	roperties.
111. VV	roundwater, on-site surface water or off-site surface waters)?	
g	groundwater, on-site surface water of off-site surface waters): On-site treatment measures and infiltration in accordance with the NYSDEC Stormwater Management Design Manual (SMDN)	Discharge will be to
	On-site treatment measures and inflitration in accordance with the NTSDEC Stoffwater Management Design Mandar (SMDN) (injection wells.	i). Discharge will be to
DECITOCK	If to surface waters, identify receiving water bodies or wetlands:	
•	If to surface waters, identify receiving water bodies of weitailus.	
	Will the CC Clare to a discount and a second and	☐Yes ✓ No
	Will stormwater runoff flow to adjacent properties?	
	pes the proposed plan minimize impervious surfaces, use pervious materials or collect and re-use stormwater?	
	bes the proposed action include, or will it use on-site, one or more sources of air emissions, including fuel	□Yes Z No
cor	mbustion, waste incineration, or other processes or operations?	
If Yes	s, identify:	
i. M	Sobile sources during project operations (e.g., heavy equipment, fleet or delivery vehicles)	
ii. S	tationary sources during construction (e.g., power generation, structural heating, batch plant, crushers)	
iii. S	tationary sources during operations (e.g., process emissions, large boilers, electric generation)	
σ Wi	ill any air emission sources named in D.2.f (above), require a NY State Air Registration, Air Facility Permit,	☐Yes Z No
6. W	Federal Clean Air Act Title IV or Title V Permit?	
If Ye		
i Ici	the project site located in an Air quality non-attainment area? (Area routinely or periodically fails to meet	□Yes□No
ι. 18 Ι	abient air quality standards for all or some parts of the year)	
am	addition to emissions as calculated in the application, the project will generate:	
u. In	addition to emissions as calculated in the application, the project will generate:	
•	Tons/year (short tons) of Carbon Dioxide (CO ₂)	
	Tons/year (short tons) of Nitrous Oxide (N ₂ O)	
	Tons/year (short tons) of Perfluorocarbons (PFCs)	
•	Tons/year (short tons) of Sulfur Hexafluoride (SF ₆)	
	Tons/year (short tons) of Carbon Dioxide equivalent of Hydroflourocarbons (HFCs)	
	Tons/year (short tons) of Hazardous Air Pollutants (HAPs)	

h. Will the proposed action generate or emit methane (including, but not limited to, sewage treatment plants, landfills, composting facilities)? If Yes: i. Estimate methane generation in tons/year (metric): ii. Describe any methane capture, control or elimination measures included in project design (e.g., combustion to generation); electricity, flaring):	☐Yes ☑ No enerate heat or
 i. Will the proposed action result in the release of air pollutants from open-air operations or processes, such as quarry or landfill operations? If Yes: Describe operations and nature of emissions (e.g., diesel exhaust, rock particulates/dust): 	□Yes ☑ No
j. Will the proposed action result in a substantial increase in traffic above present levels or generate substantial new demand for transportation facilities or services? If Yes: i. When is the peak traffic expected (Check all that apply): Randomly between hours of	Yes. ☑ No s):
 iii. Parking spaces: Existing Proposed Net increase/decrease	□Yes□No
 k. Will the proposed action (for commercial or industrial projects only) generate new or additional demand for energy? If Yes: i. Estimate annual electricity demand during operation of the proposed action: Typical energy consumption for small commercial business. ii. Anticipated sources/suppliers of electricity for the project (e.g., on-site combustion, on-site renewable, via grid/other): Local energy provider (i.e. NYSEG) via existing grid. iii. Will the proposed action require a new, or an upgrade, to an existing substation? 	✓Yes No local utility, or ☐Yes ✓No
1. Hours of operation. Answer all items which apply. ii. During Operations: i. During Construction: iii. During Operations: Monday - Friday: 7:00 am - 6:00 pm Monday - Friday: Continuous Saturday: 7:00 am - 6:00 pm Saturday: Continuous Sunday: 7:00 am - 6:00 pm Sunday: Continuous Holidays: 7:00 am - 6:00 pm Holidays: Continuous	

m. Will the proposed action produce noise that will exceed existing ambient noise levels during construction, operation, or both?	✓ Yes □No
If yes:	
i. Provide details including sources, time of day and duration:	
Typical noise from construction equipment during operating hour listed in section D.2,I,	
" TYTH I at the second of the	✓ Yes □No
ii. Will the proposed action remove existing natural barriers that could act as a noise barrier or screen?	M I CS LINU
Describe: A portion of the existing vegetation will be removed for the septic system and stormwater management area.	
n. Will the proposed action have outdoor lighting?	✓ Yes ☐ No
If yes:	
i. Describe source(s), location(s), height of fixture(s), direction/aim, and proximity to nearest occupied structures:	
Each building will be affixed with dark sky compliant lighting to illuminate building entryways. Parking lot lighting between building entryways.	dings compliant with
town code.	Div Div
ii. Will proposed action remove existing natural barriers that could act as a light barrier or screen?	☑ Yes □ No
Describe: A portion of the existing vegetation will be removed for the septic system and stormwater management area.	
o. Does the proposed action have the potential to produce odors for more than one hour per day?	☐ Yes ☑ No
If Yes, describe possible sources, potential frequency and duration of odor emissions, and proximity to nearest	1032110
occupied structures:	
p. Will the proposed action include any bulk storage of petroleum (combined capacity of over 1,100 gallons)	☐ Yes ☑ No
or chemical products 185 gallons in above ground storage or any amount in underground storage?	
If Yes:	
i. Product(s) to be stored	
iii. Generally, describe the proposed storage facilities:	
III. Generally, describe the proposed storage facilities.	
q. Will the proposed action (commercial, industrial and recreational projects only) use pesticides (i.e., herbicides,	☐ Yes ☑ No
insecticides) during construction or operation?	
If Yes:	
i. Describe proposed treatment(s):	
ii. Will the proposed action use Integrated Pest Management Practices?	☑ Yes □ No
r. Will the proposed action (commercial or industrial projects only) involve or require the management or disposal	☑ Yes □ No
of solid waste (excluding hazardous materials)?	
If Yes:	
i. Describe any solid waste(s) to be generated during construction or operation of the facility:	
• Construction: 2 tons per month (unit of time)	
 Construction; Operation: 2 tons per month (unit of time) Operation: 0.5 tons per month (unit of time) 	
ii. Describe any proposals for on-site minimization, recycling or reuse of materials to avoid disposal as solid waster	
	tal cardboard etc.)
 Construction: Contractors will be responsible for utilizing segregated dumpsters for recycling materials (i.e. wood, me 	iai, barabbara, etc.)
	ata rafuea companico
 Operation: <u>Individual commercial tenants will be responsible for entering into recycling programs offered by the private.</u> 	ate refuse companies.
W. D. 1.1'	
iii. Proposed disposal methods/facilities for solid waste generated on-site:	
Construction: Contractors will provide disposal dumpsters on site during all construction activities.	
	. 20
 Operation: Individual tenants will be responsible for collection and disposal of refuse at on site dumpster locations, to 	be removed by the
local refuse / recycling provider.	


s. Does the proposed action include construction or modification of a solid waste management facility?			
If Yes:i. Type of management or handling of waste proposed	for the cite (a.g. recycling or t	rangfer station composting	r landfill or
other disposal activities):	for the site (e.g., recycling of	ransier station, composing	z, iailum, oi
ii. Anticipated rate of disposal/processing:			
•Tons/month, if transfer or other non-c	ombustion/thermal treatment,	or	
Tons/hour, if combustion or thermal to	reatment		
iii. If landfill, anticipated site life:	years		
t. Will the proposed action at the site involve the commer		rage, or disposal of hazarde	ous TYes 7 No
waste?	orar generation, treatment, see	age, or aroposar or manage	
If Yes:			
i. Name(s) of all hazardous wastes or constituents to be	generated, handled or manage	ed at facility:	
	1		
ii. Generally describe processes or activities involving h	azardous wastes or constituen	ts:	
iii. Specify amount to be handled or generatedto	ns/month		
iv. Describe any proposals for on-site minimization, recy	ycling or reuse of hazardous c	onstituents:	c
, , , , , , , , , , , , , , , , , , ,			
v. Will any hazardous wastes be disposed at an existing	offsite hazardous waste facili	ty?	□Yes□No
If Yes: provide name and location of facility:			
If No: describe proposed management of any hazardous v	vactes which will not be sent t	o a hazardous waste facilit	V*
If No. describe proposed management of any nazardous v	wastes which will not be sent t	o a mazardous wasto racini	J.
E. Site and Setting of Proposed Action			
E.1. Land uses on and surrounding the project site			
a. Existing land uses.			
i. Check all uses that occur on, adjoining and near the project site.			
☑ Urban ☐ Industrial ☑ Commercial ☑ Residential (suburban) ☐ Rural (non-farm)			
Forest Agriculture Aquatic Other	(specify):		
ii. If mix of uses, generally describe:			
-			
b. Land uses and covertypes on the project site.			p
Land use or	Current	Acreage After	Change
Covertype	Acreage	Project Completion	(Acres +/-)
Roads, buildings, and other paved or impervious	2.5	3.5	+1.0
surfaces			
Forested	(4)		(#E
Meadows, grasslands or brushlands (non-	2.7	1.3	-1.4
agricultural, including abandoned agricultural)		297	
Agricultural	7.43	151	(e)
(includes active orchards, field, greenhouse etc.)			
Surface water features		() 5)	(6)
(lakes, ponds, streams, rivers, etc.)			
Wetlands (freshwater or tidal)			1.5
Non-vegetated (bare rock, earth or fill)		U.S.	
Other			
Describe: Lawn area	2.0	2.4	+0,4

	□Yes√No
c. Is the project site presently used by members of the community for public recreation? i. If Yes: explain:	
d. Are there any facilities serving children, the elderly, people with disabilities (e.g., schools, hospitals, licensed day care centers, or group homes) within 1500 feet of the project site? If Yes,	Z Yes□No
i. Identify Facilities:	
Nativity Blessed Virgin Mary Church; Harris Hill Elementary; St. Paul's Episcopal Church	
Nativity Diessed Virgin Wary Ontrol, Hams him Elementary, etc. Factor Episospa. Section.	
	☐ Yes Z No
e. Does the project site contain an existing dam? If Yes:	LI I ESMINO
i. Dimensions of the dam and impoundment:	
Dam height:feet	
Dam length:	
Surface area: acres	
Volume impounded: gallons OR acre-feet	
ii. Dam's existing hazard classification:	
iii. Provide date and summarize results of last inspection:	
f. Has the project site ever been used as a municipal, commercial or industrial solid waste management facility, or does the project site adjoin property which is now, or was at one time, used as a solid waste management facil	□Yes ☑ No ty?
If Yes:	☐Yes☐ No
i. Has the facility been formally closed?	
If yes, cite sources/documentation:	
ii. Describe the location of the project site relative to the boundaries of the solid waste management facility:	
iii. Describe any development constraints due to the prior solid waste activities:	
g. Have hazardous wastes been generated, treated and/or disposed of at the site, or does the project site adjoin property which is now or was at one time used to commercially treat, store and/or dispose of hazardous waste?	□Yes ☑ No
If Yes: i. Describe waste(s) handled and waste management activities, including approximate time when activities occurred.	ed:
i. Describe waste(s) finalitied and waste finalitigement detricted, morading upproximate since waste(s)	
h. Potential contamination history. Has there been a reported spill at the proposed project site, or have any remedial actions been conducted at or adjacent to the proposed site?	☐Yes☑ No
i. Is any portion of the site listed on the NYSDEC Spills Incidents database or Environmental Site	□Yes□No
Remediation database? Check all that apply:	
☐ Yes – Spills Incidents database Provide DEC ID number(s):	
☐ Neither database	
ii. If site has been subject of RCRA corrective activities, describe control measures:	
ii. If site has been subject of RCRA corrective activities, describe control measures:	
ii. If site has been subject of RCRA corrective activities, describe control measures:	
 ii. If site has been subject of RCRA corrective activities, describe control measures: iii. Is the project within 2000 feet of any site in the NYSDEC Environmental Site Remediation database? If yes, provide DEC ID number(s): iv. If yes to (i), (ii) or (iii) above, describe current status of site(s): 	☐ Yes ✓ No
 ii. If site has been subject of RCRA corrective activities, describe control measures: iii. Is the project within 2000 feet of any site in the NYSDEC Environmental Site Remediation database? If yes, provide DEC ID number(s): 	☐ Yes ✓ No

v. Is the project site subject to an institutional control	limiting property uses?		☐ Yes Z No
If yes, DEC site ID number:	1.1		
 Describe the type of institutional control (e.g. Describe any use limitations: 			
Describe any use limitations: Describe any engineering controls:			
 Describe any engineering controls: Will the project affect the institutional or eng 	ineering controls in place?		☐ Yes ☐ No
• Explain:			
E.2. Natural Resources On or Near Project Site			
a. What is the average depth to bedrock on the project	site? <u>0-5</u> f	eet	
b. Are there bedrock outcroppings on the project site?			☐ Yes Z No
If Yes, what proportion of the site is comprised of bed	ock outcroppings?	%	
c. Predominant soil type(s) present on project site:	Benson very channery loam	33 %	
31 (71	Ovid silt loam	31 %	
	Wassaic silt loam	36 %	
d. What is the average depth to the water table on the p	project site? Average:>5 feet		
e. Drainage status of project site soils: Well Drained			
✓ Moderately V	Well Drained: 64 % of site		
Poorly Drain			
f. Approximate proportion of proposed action site with	I Manual	00 % of site	
	10-15%:	% of site % of site	
	15% or greater:	70 01 Site	
g. Are there any unique geologic features on the project	et site?		☐ Yes ✓ No
If Yes, describe:			
			
h. Surface water features.i. Does any portion of the project site contain wetland	ds or other waterhodies (including stream	ms rivers	□Yes ☑ No
ponds or lakes)?	is of other waterbodies (merading stream	110, 111010,	
ii. Do any wetlands or other waterbodies adjoin the pr	roject site?		Z Yes□No
If Yes to either <i>i</i> or <i>ii</i> , continue. If No, skip to E.2.i.			
iii. Are any of the wetlands or waterbodies within or a	idjoining the project site regulated by a	ny federal,	✓ Yes □No
state or local agency? iv. For each identified regulated wetland and waterbo	Joseph a project site provide the follow	ving informations	
	Cl	assification	
Lakes or Ponds: Name			
Wetlands: Name	A ₁	assification oproximate Size	
Wetland No. (if regulated by DEC)	THE CANAC	ta t	□Yes ☑ No
v. Are any of the above water bodies listed in the mos waterbodies?	it recent compilation of NYS water qual	ity-impaired	I i es Mino
If yes, name of impaired water body/bodies and basis	for listing as impaired:		
y y y y y y			
i. Is the project site in a designated Floodway?			□Yes Z No
j. Is the project site in the 100-year Floodplain?			□Yes Z No
k. Is the project site in the 500-year Floodplain?			□Yes ☑ No
1. Is the project site located over, or immediately adjoin	ning, a primary, principal or sole source	e aquifer?	□Yes☑No
If Yes:			
i. Name of aquifer:			

m. Identify the predominant wildlife species	s that occupy or use the project site: Rabbits	Squirrels	
White tailed deer Various bird species	Various rodent species	Raccoons	
various bird species	Tanous rodoni oposios		
n. Does the project site contain a designated If Yes: i. Describe the habitat/community (compo Oak Openings		tion):	☑ Yes N o
ii. Source(s) of description or evaluation:	NYSDEC EAF Mapper		
iii. Extent of community/habitat:			
Currently:	70.		
 Following completion of project as 		0 acres	
• Gain or loss (indicate + or -):	0.	0 acres	
o. Does project site contain any species of p endangered or threatened, or does it conta If Yes: i. Species and listing (endangered or threatened)	in any areas identified as habitat for a	eral government or NYS as in endangered or threatened spec	
p. Does the project site contain any species special concern? If Yes: i. Species and listing:			□Yes ☑ No
q. Is the project site or adjoining area currer If yes, give a brief description of how the pr	ntly used for hunting, trapping, fishing roposed action may affect that use:	g or shell fishing?	□Yes ✓No
E.3. Designated Public Resources On or	Near Project Site		
a. Is the project site, or any portion of it, loc Agriculture and Markets Law, Article 25 If Yes, provide county plus district name/n	cated in a designated agricultural distro-AA, Section 303 and 304?		∐Yes ∏ No
b. Are agricultural lands consisting of highl i. If Yes: acreage(s) on project site? ii. Source(s) of soil rating(s):			∐Yes Z No
c. Does the project site contain all or part of Natural Landmark? If Yes:	□ Biological Community □ 0	Geological Feature	∐Yes ∏ No
d. Is the project site located in or does it add If Yes: i. CEA name: ii. Basis for designation:			
iii. Designating agency and date:			

e. Does the project site contain, or is it substantially contiguous to, a building, archaeological site, or district which is listed on the National or State Register of Historic Places, or that has been determined by the Commission Office of Parks, Recreation and Historic Preservation to be eligible for listing on the State Register of Historic Places is Nature of historic/archaeological resource: Archaeological Site Historic Building or District	☐ Yes☑ No oner of the NYS ices?		
ii. Name:iii. Brief description of attributes on which listing is based:	***		
f. Is the project site, or any portion of it, located in or adjacent to an area designated as sensitive for archaeological sites on the NY State Historic Preservation Office (SHPO) archaeological site inventory?	Z Yes □No		
g. Have additional archaeological or historic site(s) or resources been identified on the project site? If Yes:	□Yes Z No		
i. Describe possible resource(s):ii. Basis for identification:			
h. Is the project site within fives miles of any officially designated and publicly accessible federal, state, or local scenic or aesthetic resource? If Yes:	∐Yes Z No		
 i. Identify resource: ii. Nature of, or basis for, designation (e.g., established highway overlook, state or local park, state historic trail or etc.): iii. Distance between project and resource: miles. 	scenic byway,		
i. Is the project site located within a designated river corridor under the Wild, Scenic and Recreational Rivers Program 6 NYCRR 666? If Yes: ✓ No			
i. Identify the name of the river and its designation:ii. Is the activity consistent with development restrictions contained in 6NYCRR Part 666?	□Yes □No		
F. Additional Information Attach any additional information which may be needed to clarify your project. If you have identified any adverse impacts which could be associated with your proposal, please describe those impacts plus any measures which you propose to avoid or minimize them.			
G. Verification I certify that the information provided is true to the best of my knowledge. Applicant/Sponsor Name Jacob Metzger, PE Date_March 21, 2024	:		
Signature Title Engineering Consultant			

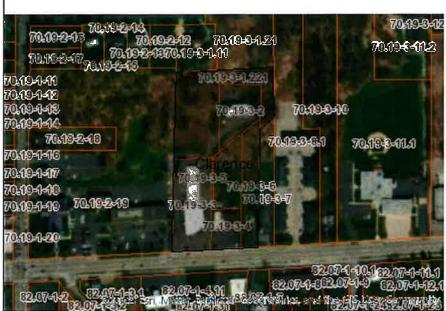

Disclaimer: The EAF Mapper is a screening tool intended to assist project sponsors and reviewing agencies in preparing an environmental assessment form (EAF). Not all questions asked in the EAF are answered by the EAF Mapper. Additional information on any EAF question can be obtained by consulting the EAF Workbooks. Although the EAF Mapper provides the most up-to-date digital data available to DEC, you may also need to contact local or other data sources in order to obtain data not provided by the Mapper, Digital data is not a substitute for agency determinations,



B.i.i [Coastal or Waterfront Area]	No
B.i.ii [Local Waterfront Revitalization Area]	No
C.2.b. [Special Planning District]	Yes - Digital mapping data are not available for all Special Planning Districts. Refer to EAF Workbook.
C.2.b. [Special Planning District - Name]	NYS Heritage Areas:West Erie Canal Corridor
E.1.h [DEC Spills or Remediation Site - Potential Contamination History]	Digital mapping data are not available or are incomplete. Refer to EAF Workbook.
E.1.h.i [DEC Spills or Remediation Site - Listed]	Digital mapping data are not available or are incomplete. Refer to EAF Workbook.
E.1.h.i [DEC Spills or Remediation Site - Environmental Site Remediation Database]	Digital mapping data are not available or are incomplete. Refer to EAF Workbook.
E.1.h.iii [Within 2,000' of DEC Remediation Site]	No
E.2.g [Unique Geologic Features]	No
E.2.h.i [Surface Water Features]	No
E.2.h.ii [Surface Water Features]	Yes
E.2.h.iii [Surface Water Features]	Yes - Digital mapping information on local and federal wetlands and waterbodies is known to be incomplete. Refer to EAF Workbook.
E.2.h.v [Impaired Water Bodies]	No
E.2.i. [Floodway]	No
E.2.j. [100 Year Floodplain]	No
E.2.k. [500 Year Floodplain]	No
E.2.I. [Aquifers]	No
E.2.n. [Natural Communities]	Yes
E.2.n.i [Natural Communities - Name]	Oak Openings

E.3.i. [Designated River Corridor]	No
E.3.f. [Archeological Sites]	Yes
E.3.e. [National or State Register of Historic Places or State Eligible Sites]	Digital mapping data are not available or are incomplete. Refer to EAF Workbook.
E.3.d [Critical Environmental Area]	No
E.3.c. [National Natural Landmark]	No
E.3.a. [Agricultural District]	No
E.2.p. [Rare Plants or Animals]	No
E.2.o. [Endangered or Threatened Species]	No
L.Z.II.I [Hatural Colliniumides - Acres]	10.0




Erie County On-Line Mapping Application

Hamilton

Rochester

Toronto

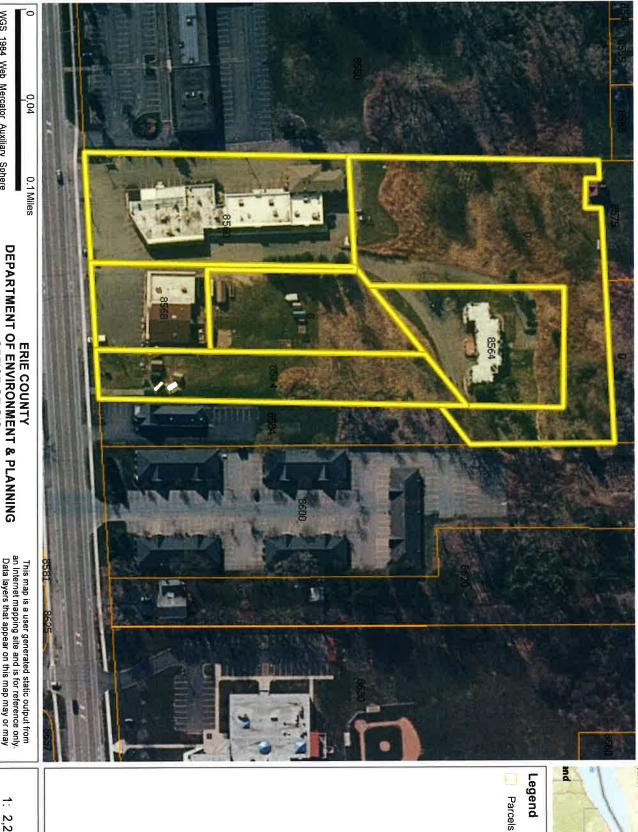

This map is a user generated static output from an Internet mapping site and is for reference only. Data layers that appear on this map may or may not be accurate, current, or otherwise reliable.

WGS_1984_Web_Mercator_Auxiliary_Sphere THIS MAP IS NOT TO BE USED FOR NAVIGATION

OFFICE OF GIS










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MILLOWISCOCK DR W HERDANDER ED THE FARMANS CIA THE FAR

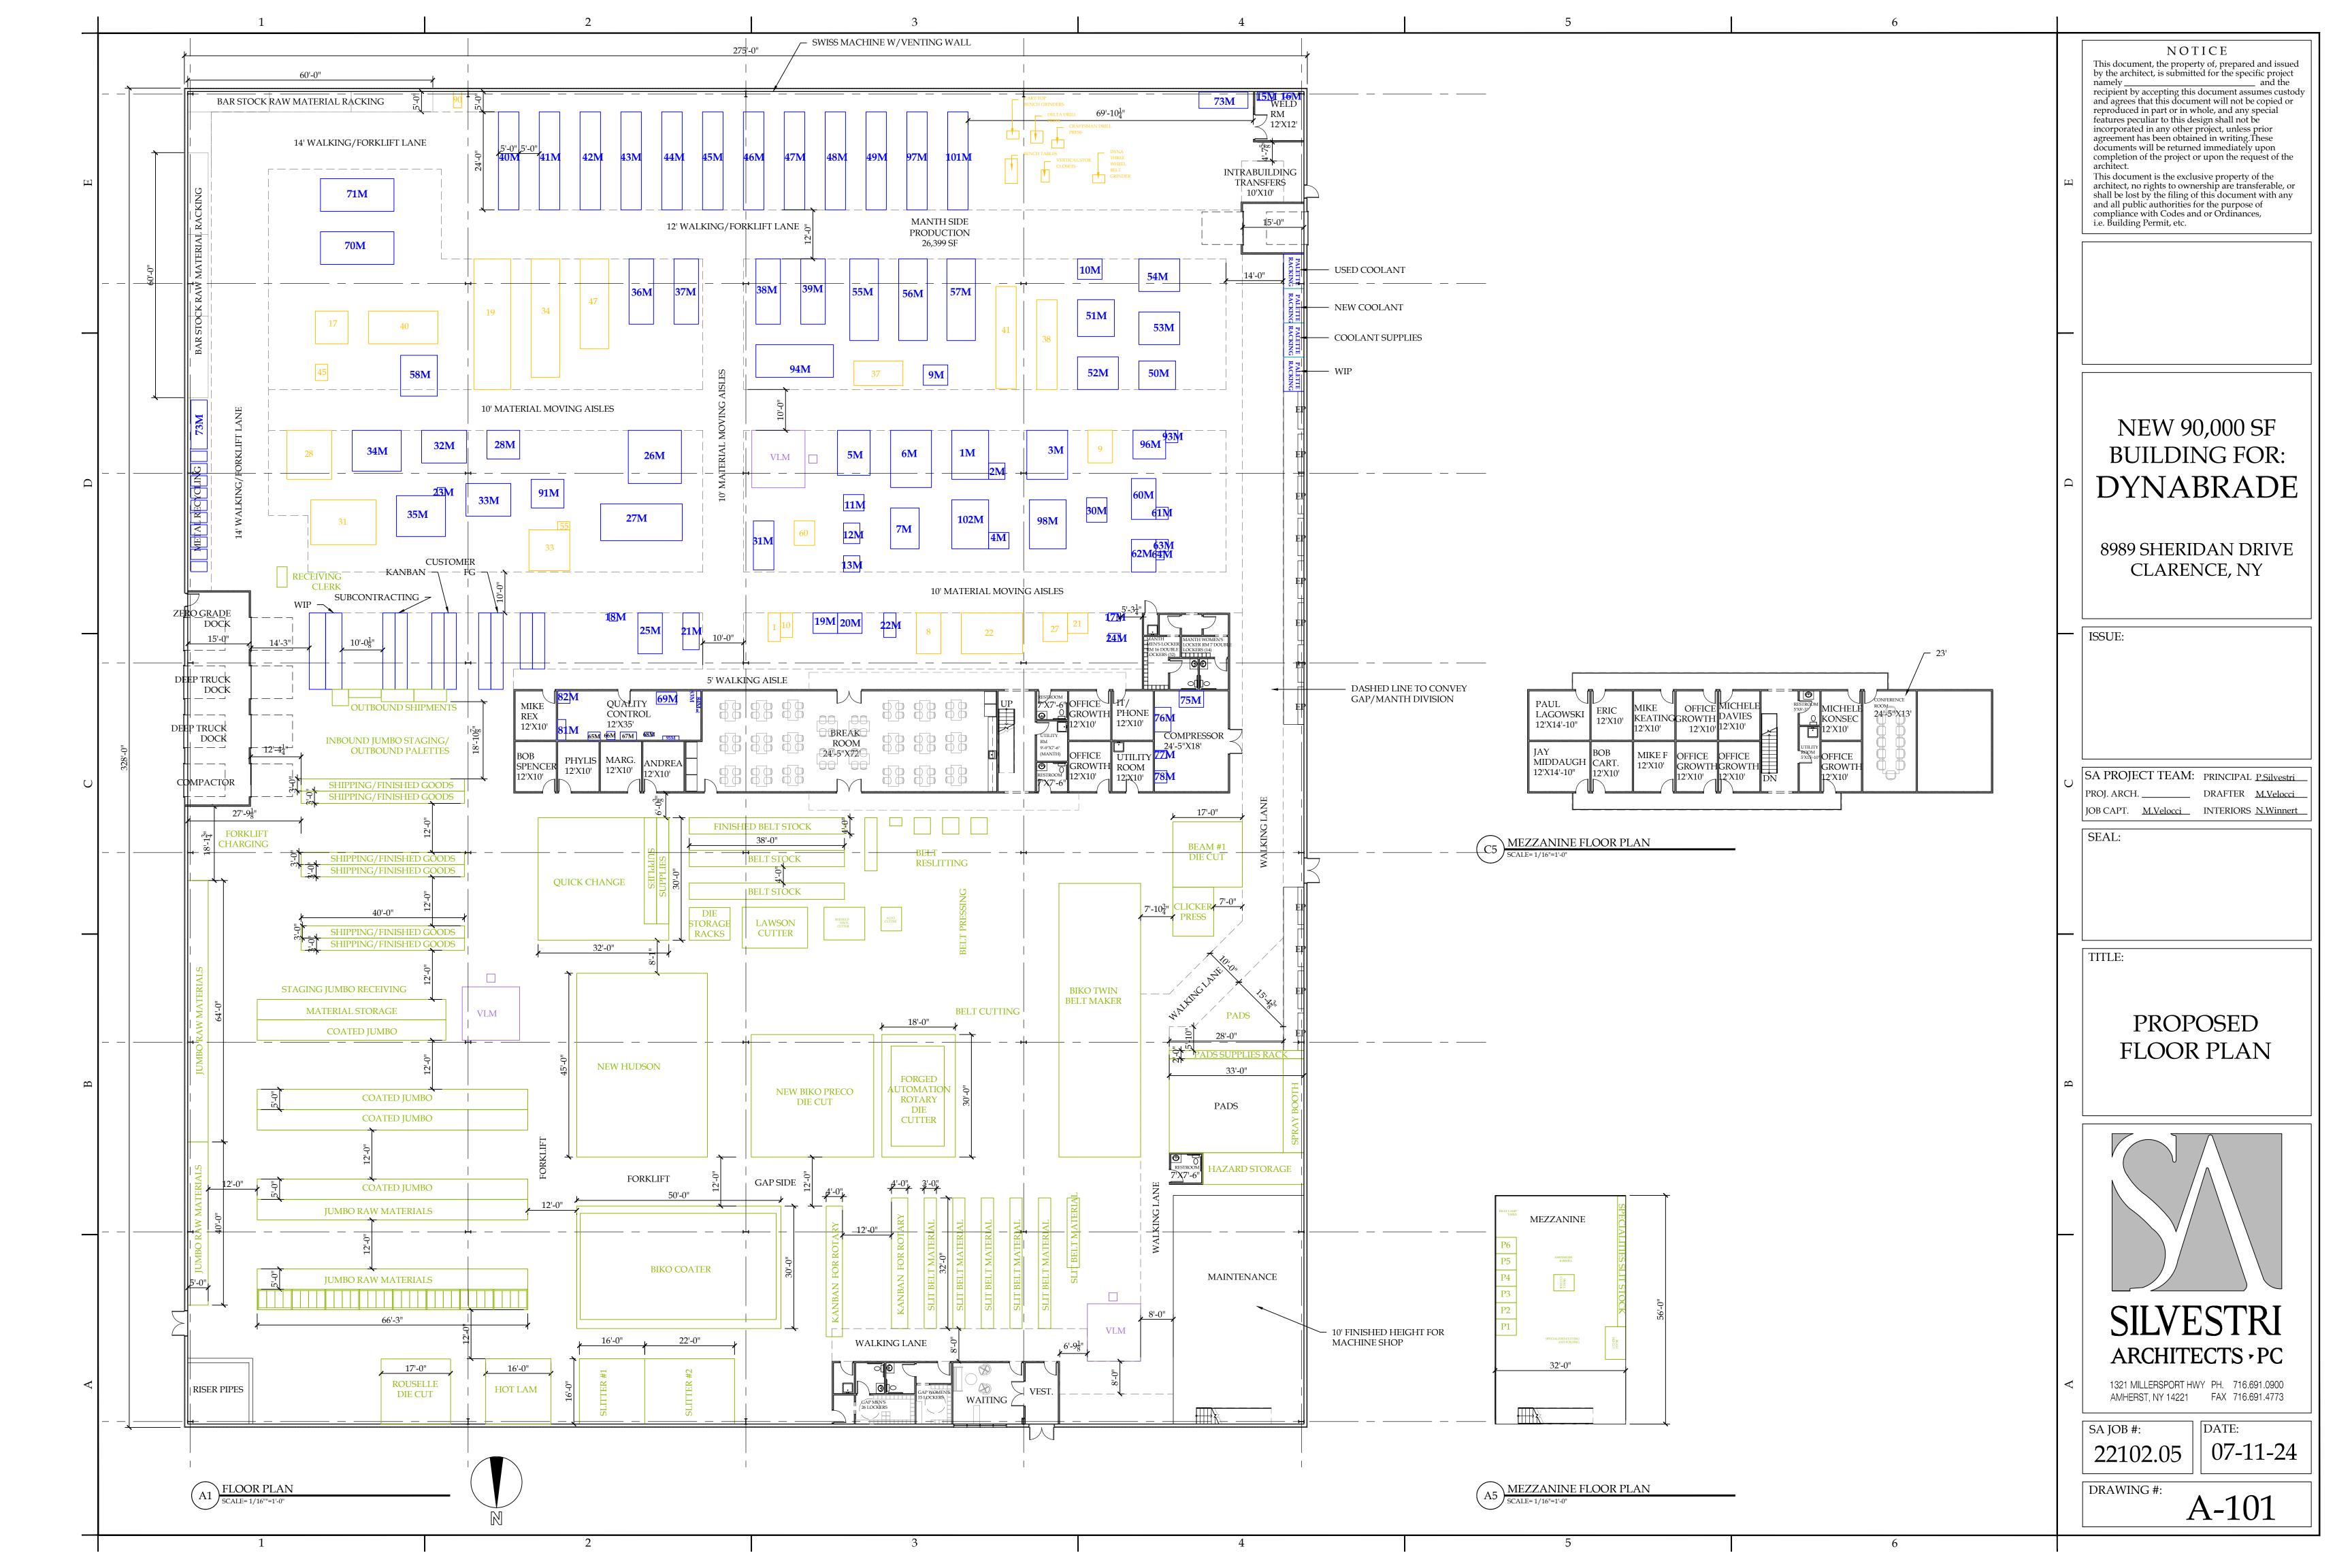LOCATION MAP



CONTRACT DRAWINGS FOR THE CONSTRUCTION OF NEW BUILDING ADDITION FOR DYNABRADE 8989 SHERIDAN DRIVE CLARENCE, NY SILVESTRI ARCHITECTS, PC

C&S PROJECT:D51.117.002


AUGUST 5, 2024

DRAWING LIS	ST ST	
SHEET NO.	SHEET NAME	
G-001	TITLE SHEET	
	SURVEY	
C-100	OVERALL SITE & TRAFFIC CONTROL PLAN	
C-101	SITE PLAN	
C-102	DEMOLITION PLAN	
C-103	GRADING PLAN	
C-104	UTILITY PLAN	
C-105	LANDSCAPING PLAN	
C-106	PHOTOMETRIC PLAN	
C-107	EROSION & SEDIMENT CONTROL PLAN	
C-501	DETAILS	
C-502	DETAILS	
C-503	DETAILS	

TO THE BEST OF OUR KNOWLEDGE, INFORMATION AND BELIEF THE PLANS AND SPECIFICATIONS FOR THIS PROJECT ARE IN COMPLIANCE WITH THE NEW YORK STATE ENERGY CONSERVATION CONSTRUCTION CODE AND THE BUILDING CODE OF NEW YORK STATE

NO ALTERATION PERMITTED HEREON EXCEPT AS PROVIDED UNDER SECTION 7209
SUBDIVISION 2 OF THE NEW YORK STATE EDUCATION LAW

G-001

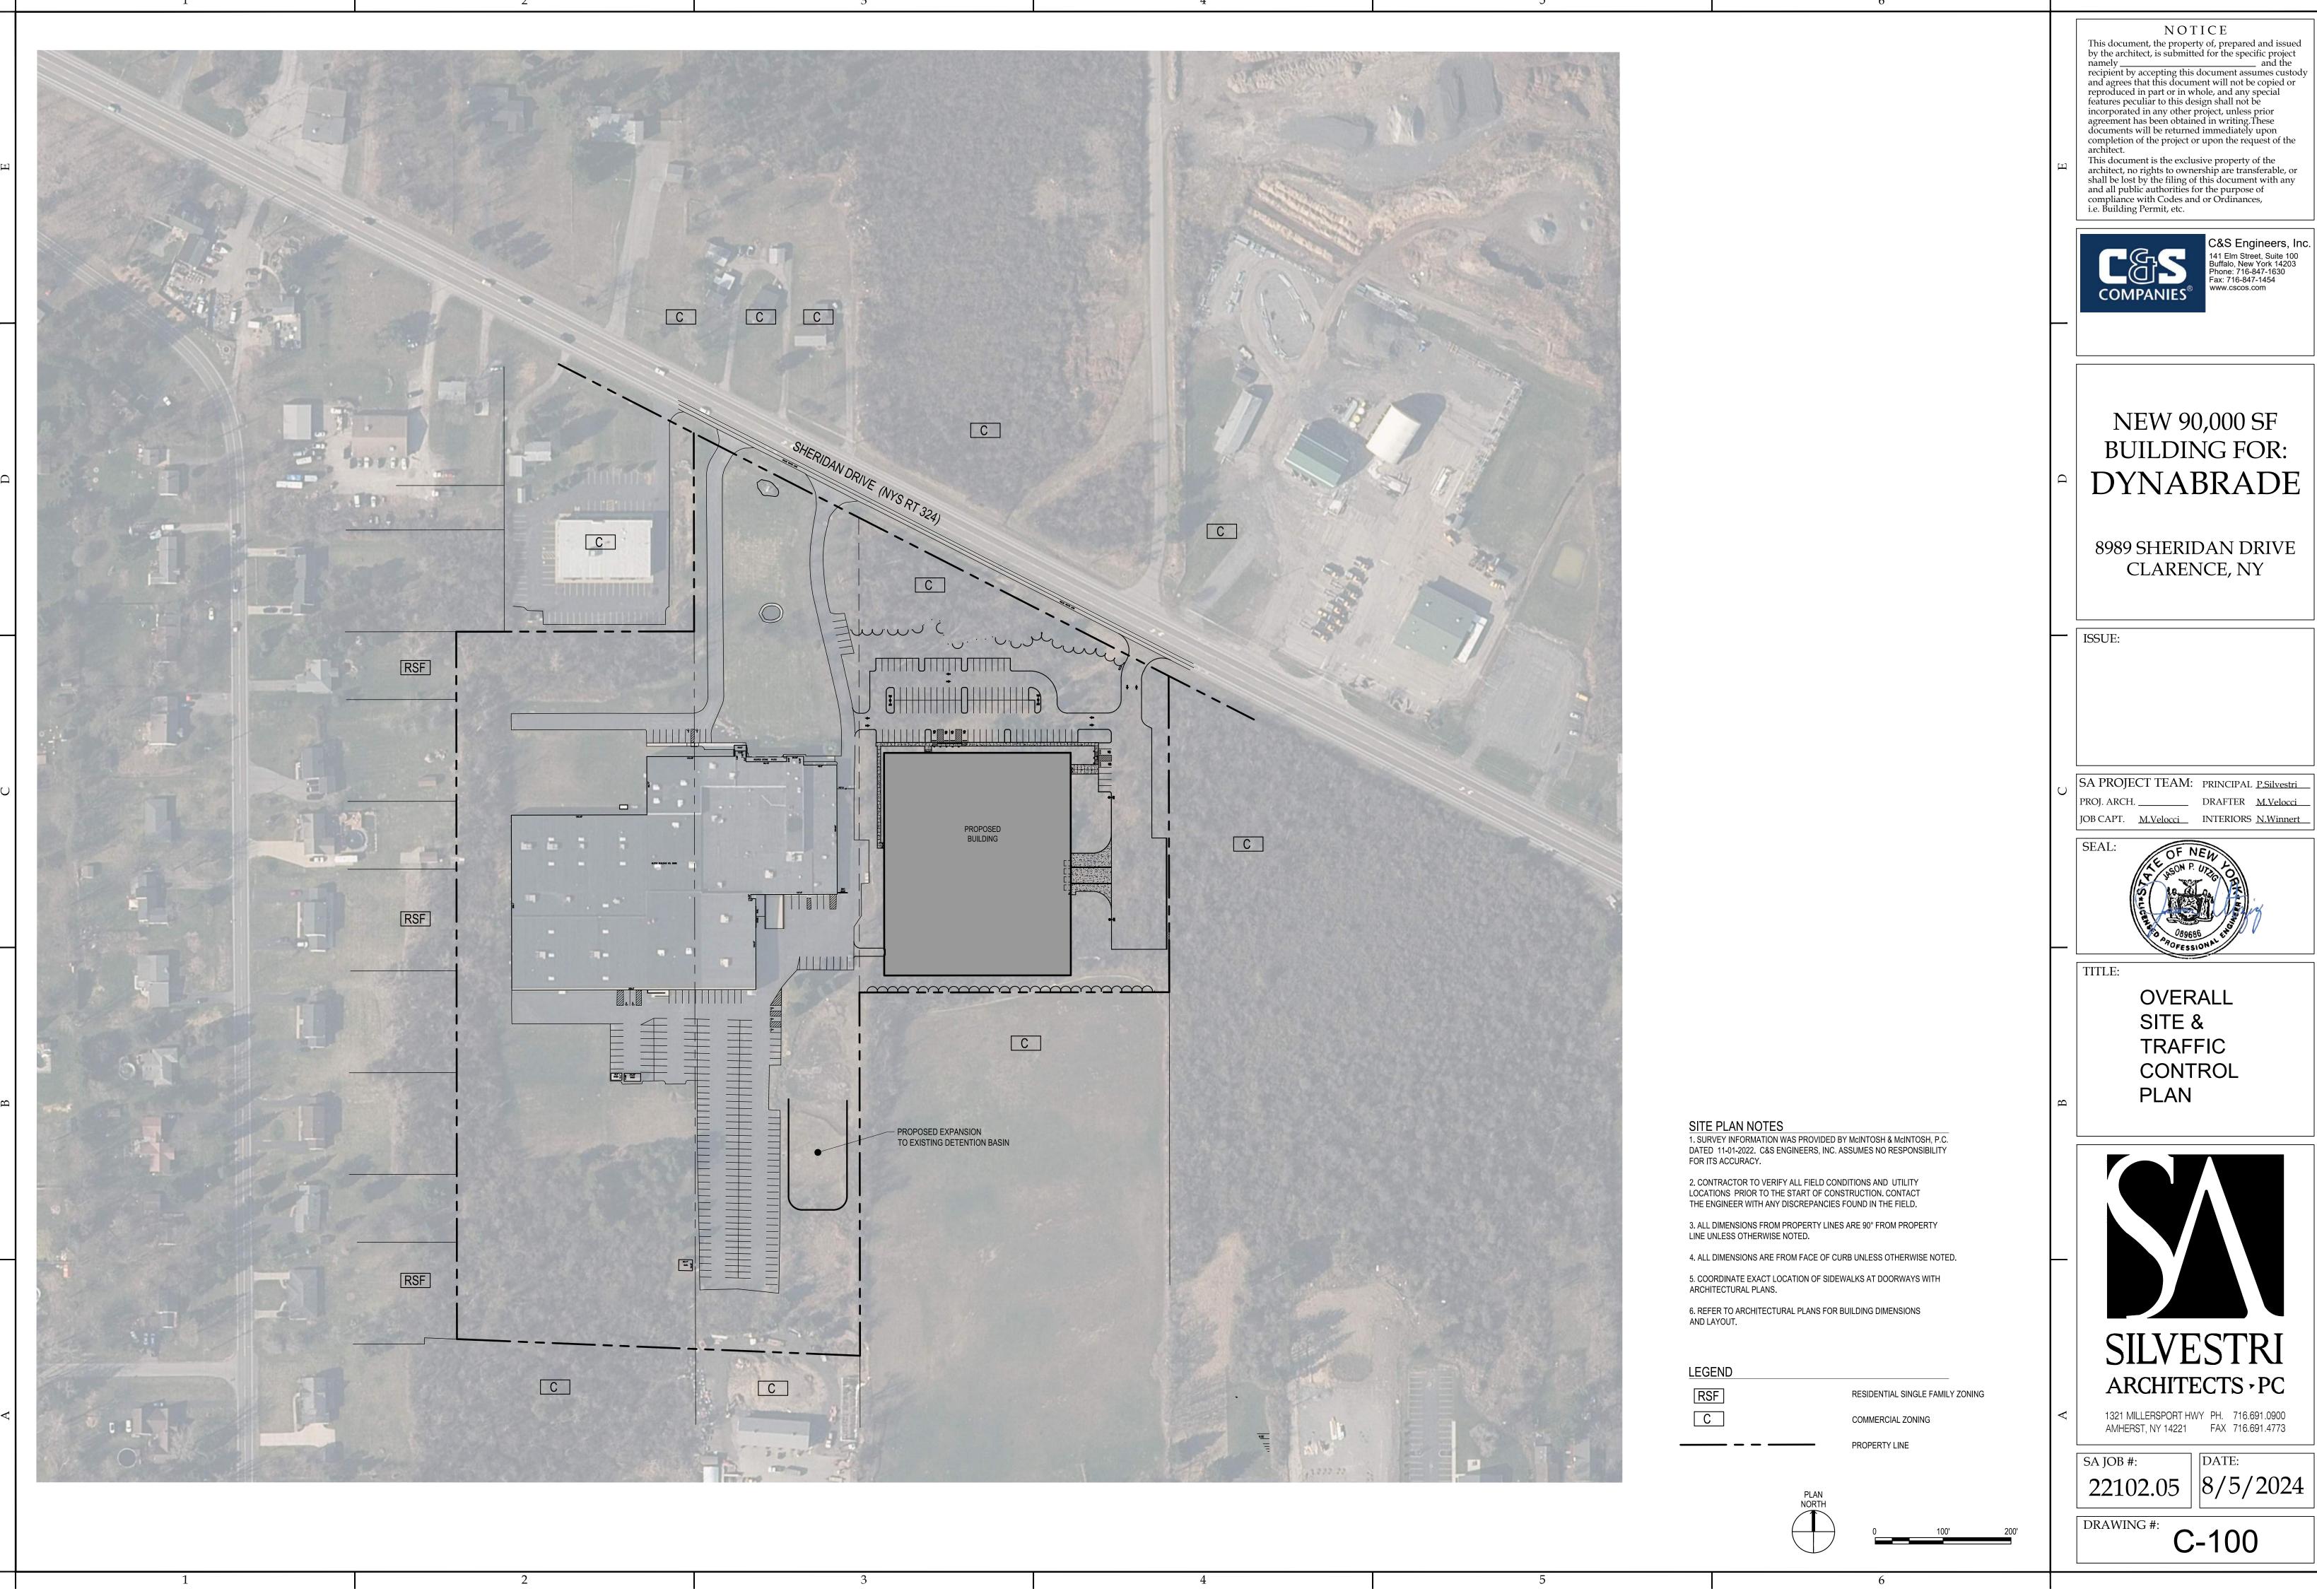

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NEW 90,000 SF BUILDING FOR:


8989 SHERIDAN DRIVE CLARENCE, NY


JOB CAPT. <u>M.Velocci</u> INTERIORS <u>N.Winnert</u>







AMHERST, NY 14221 FAX 716.691.4773

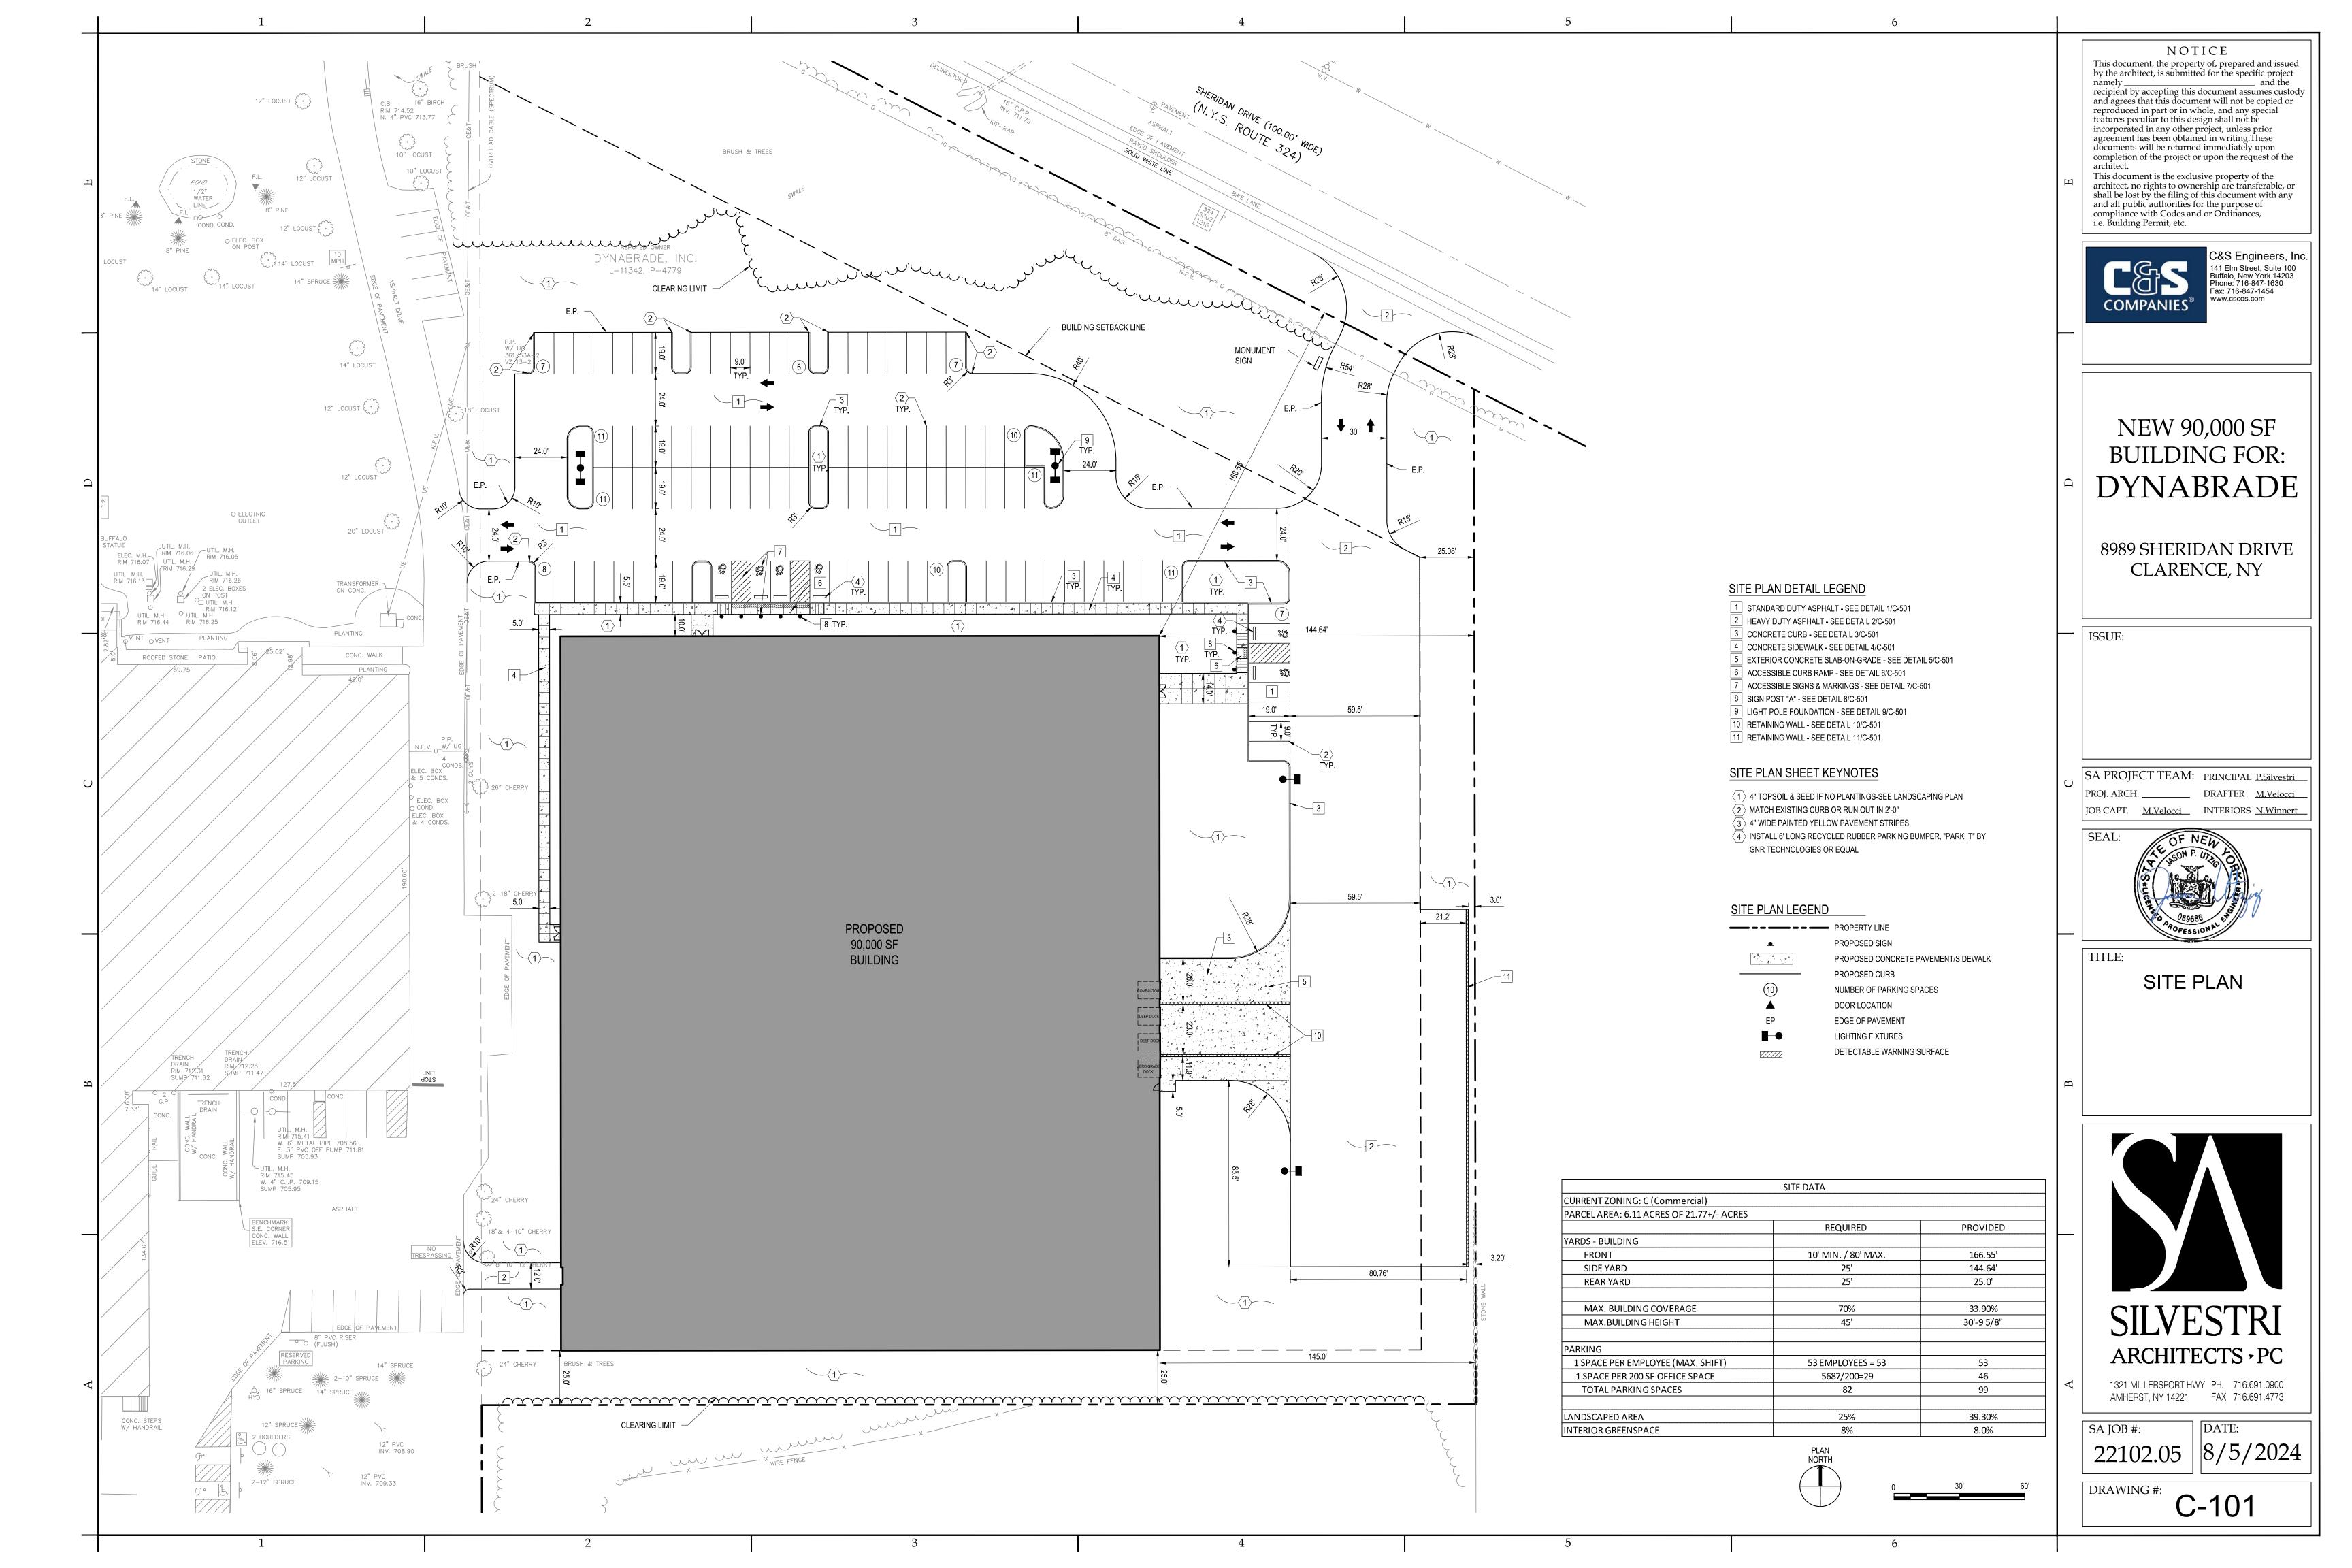

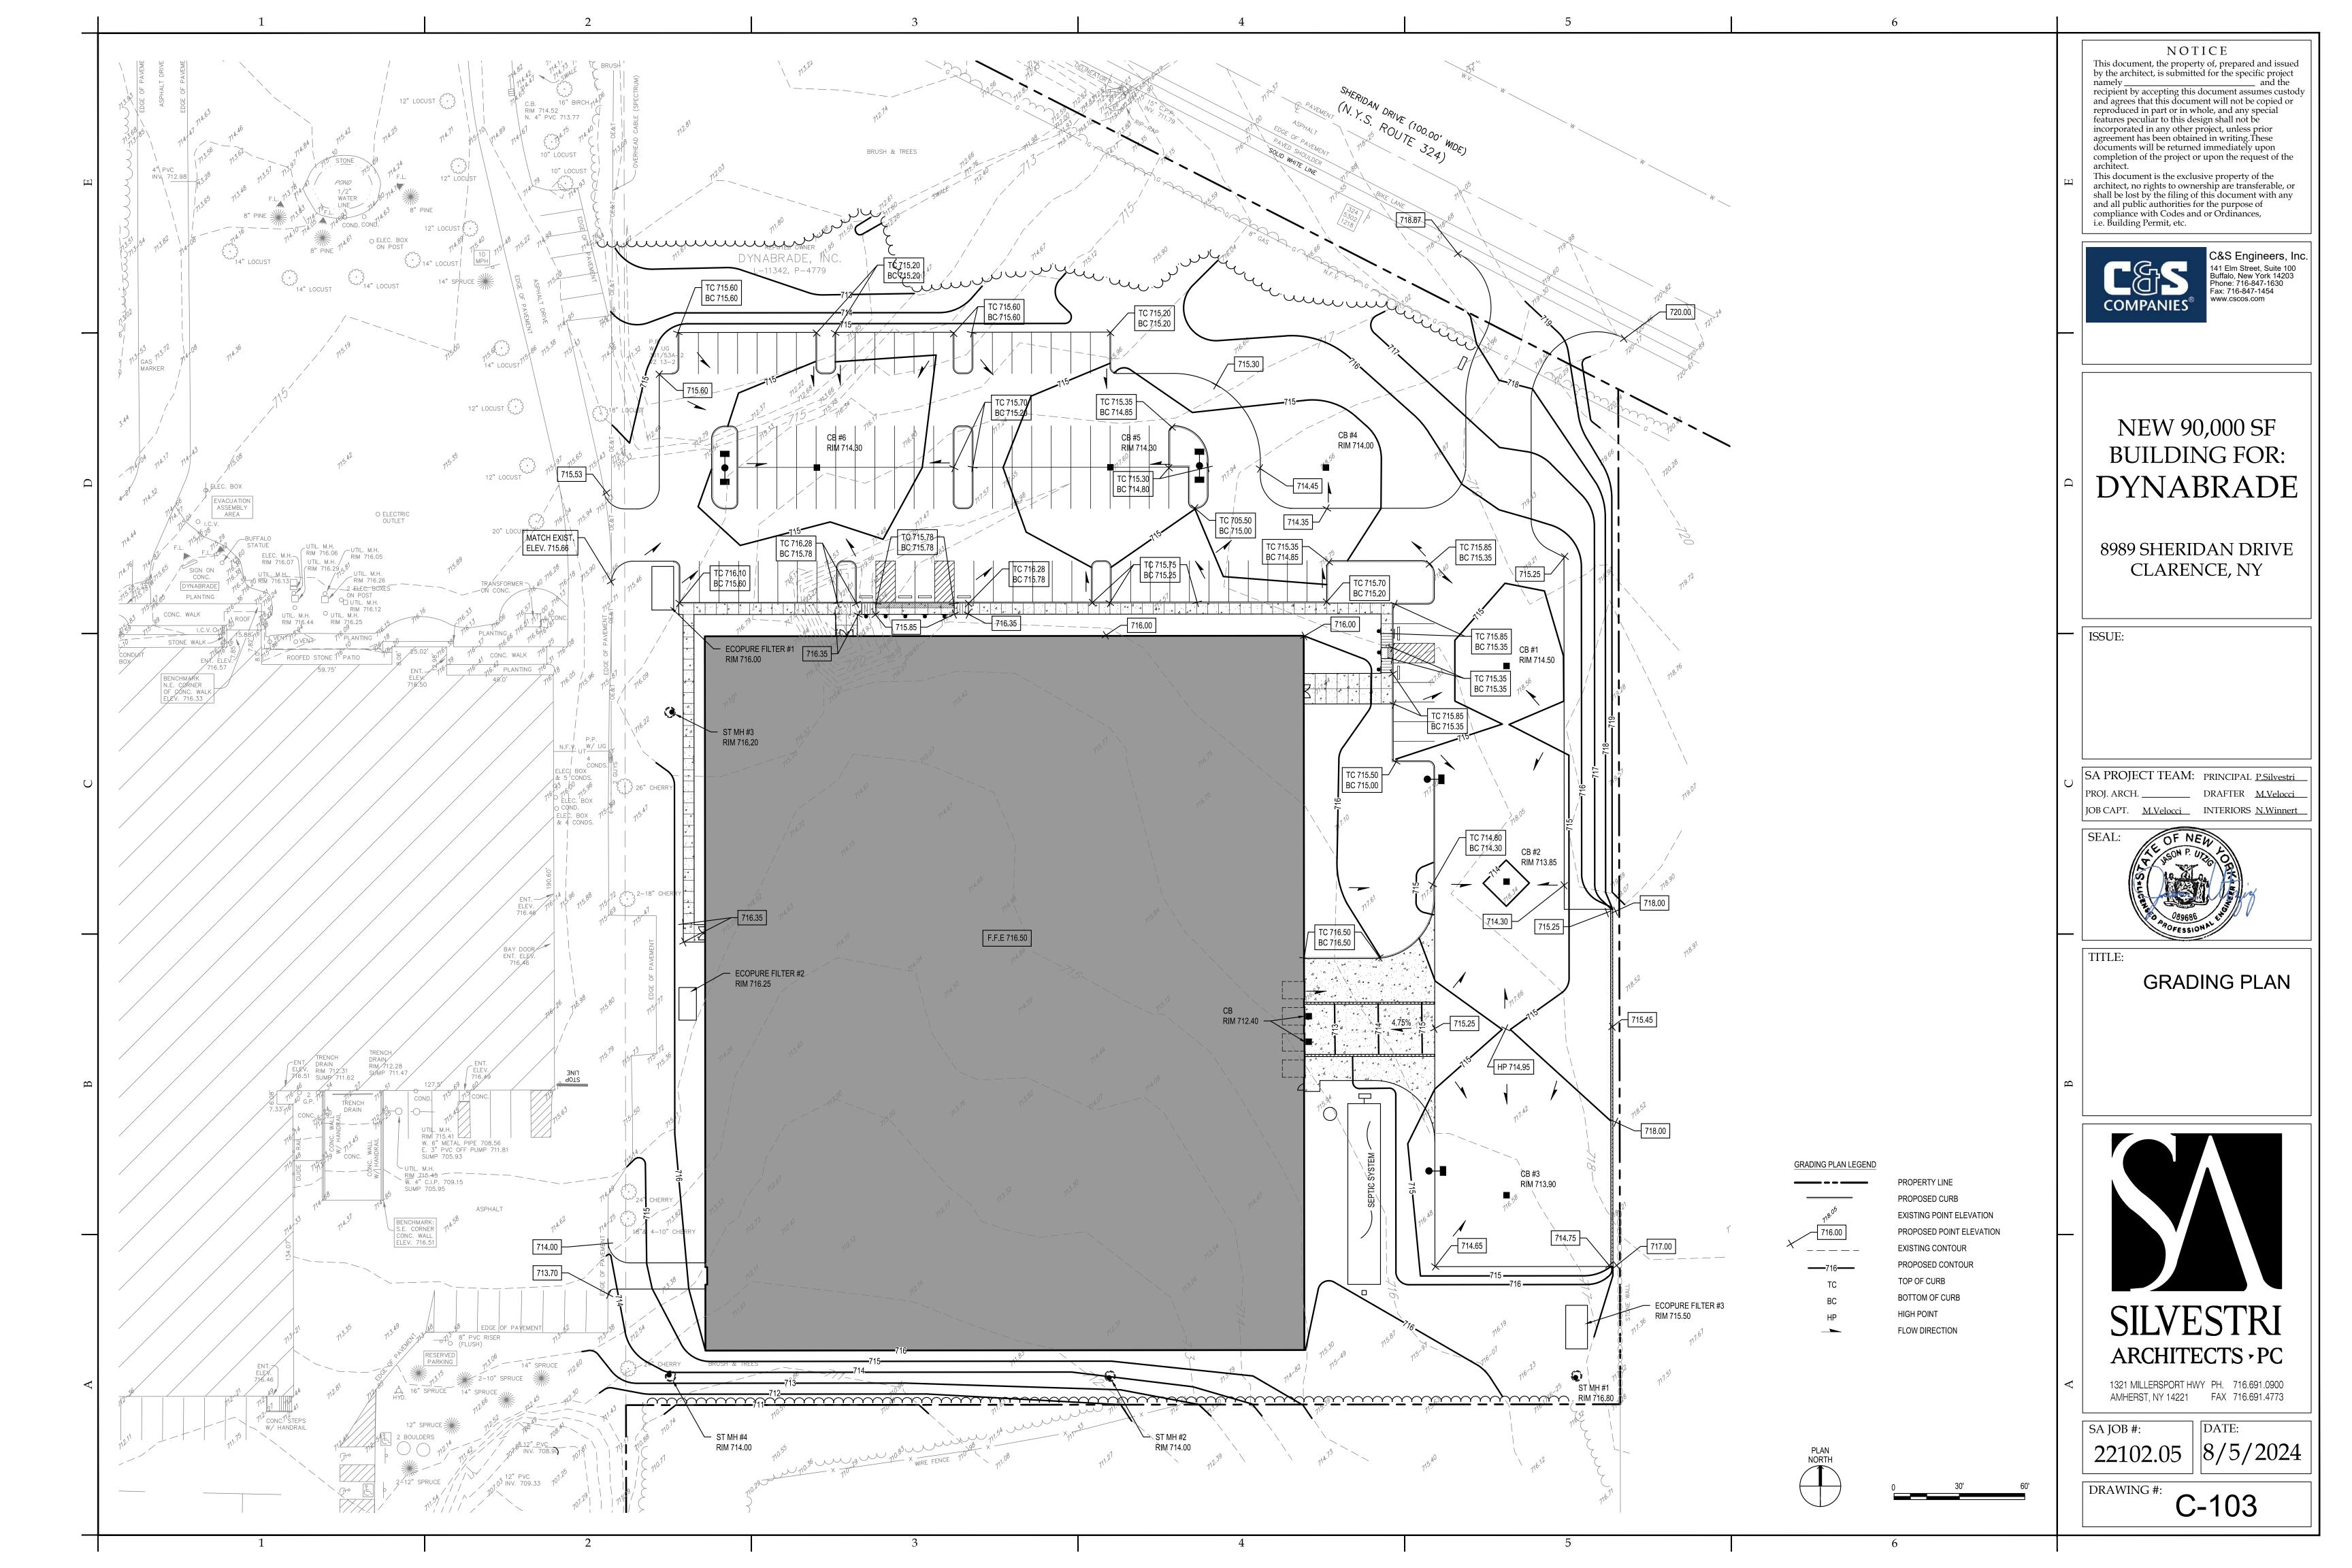

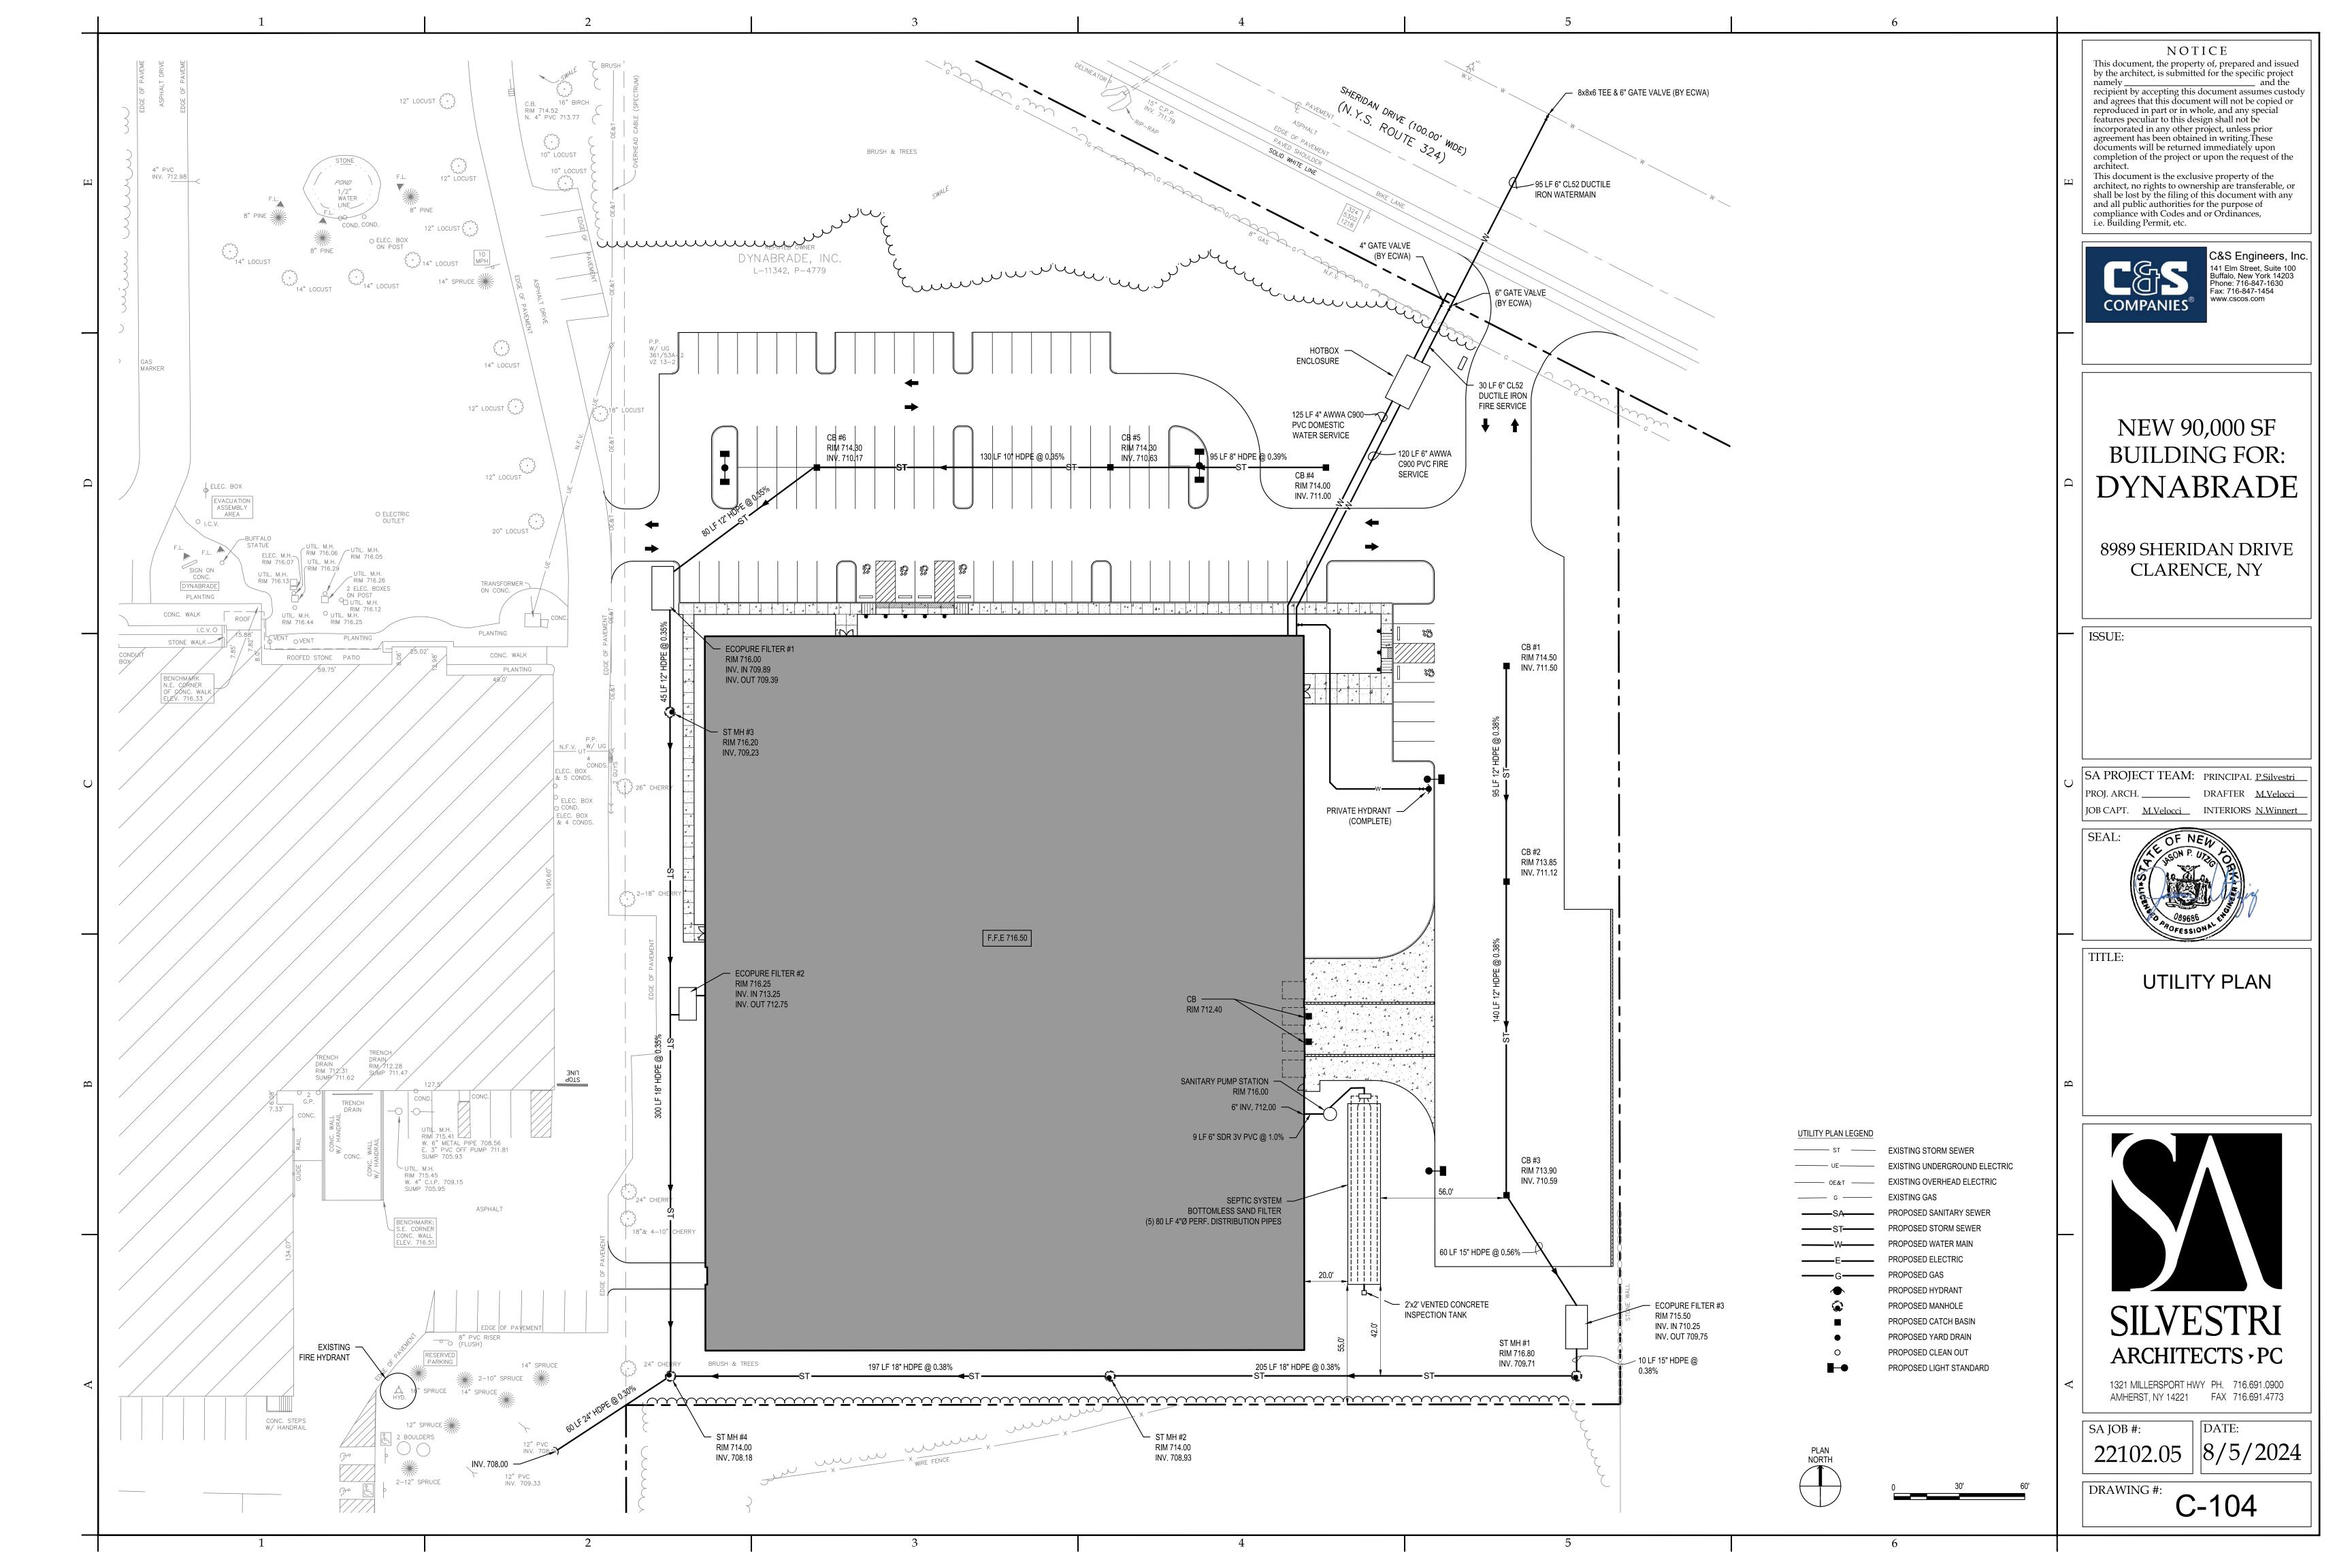

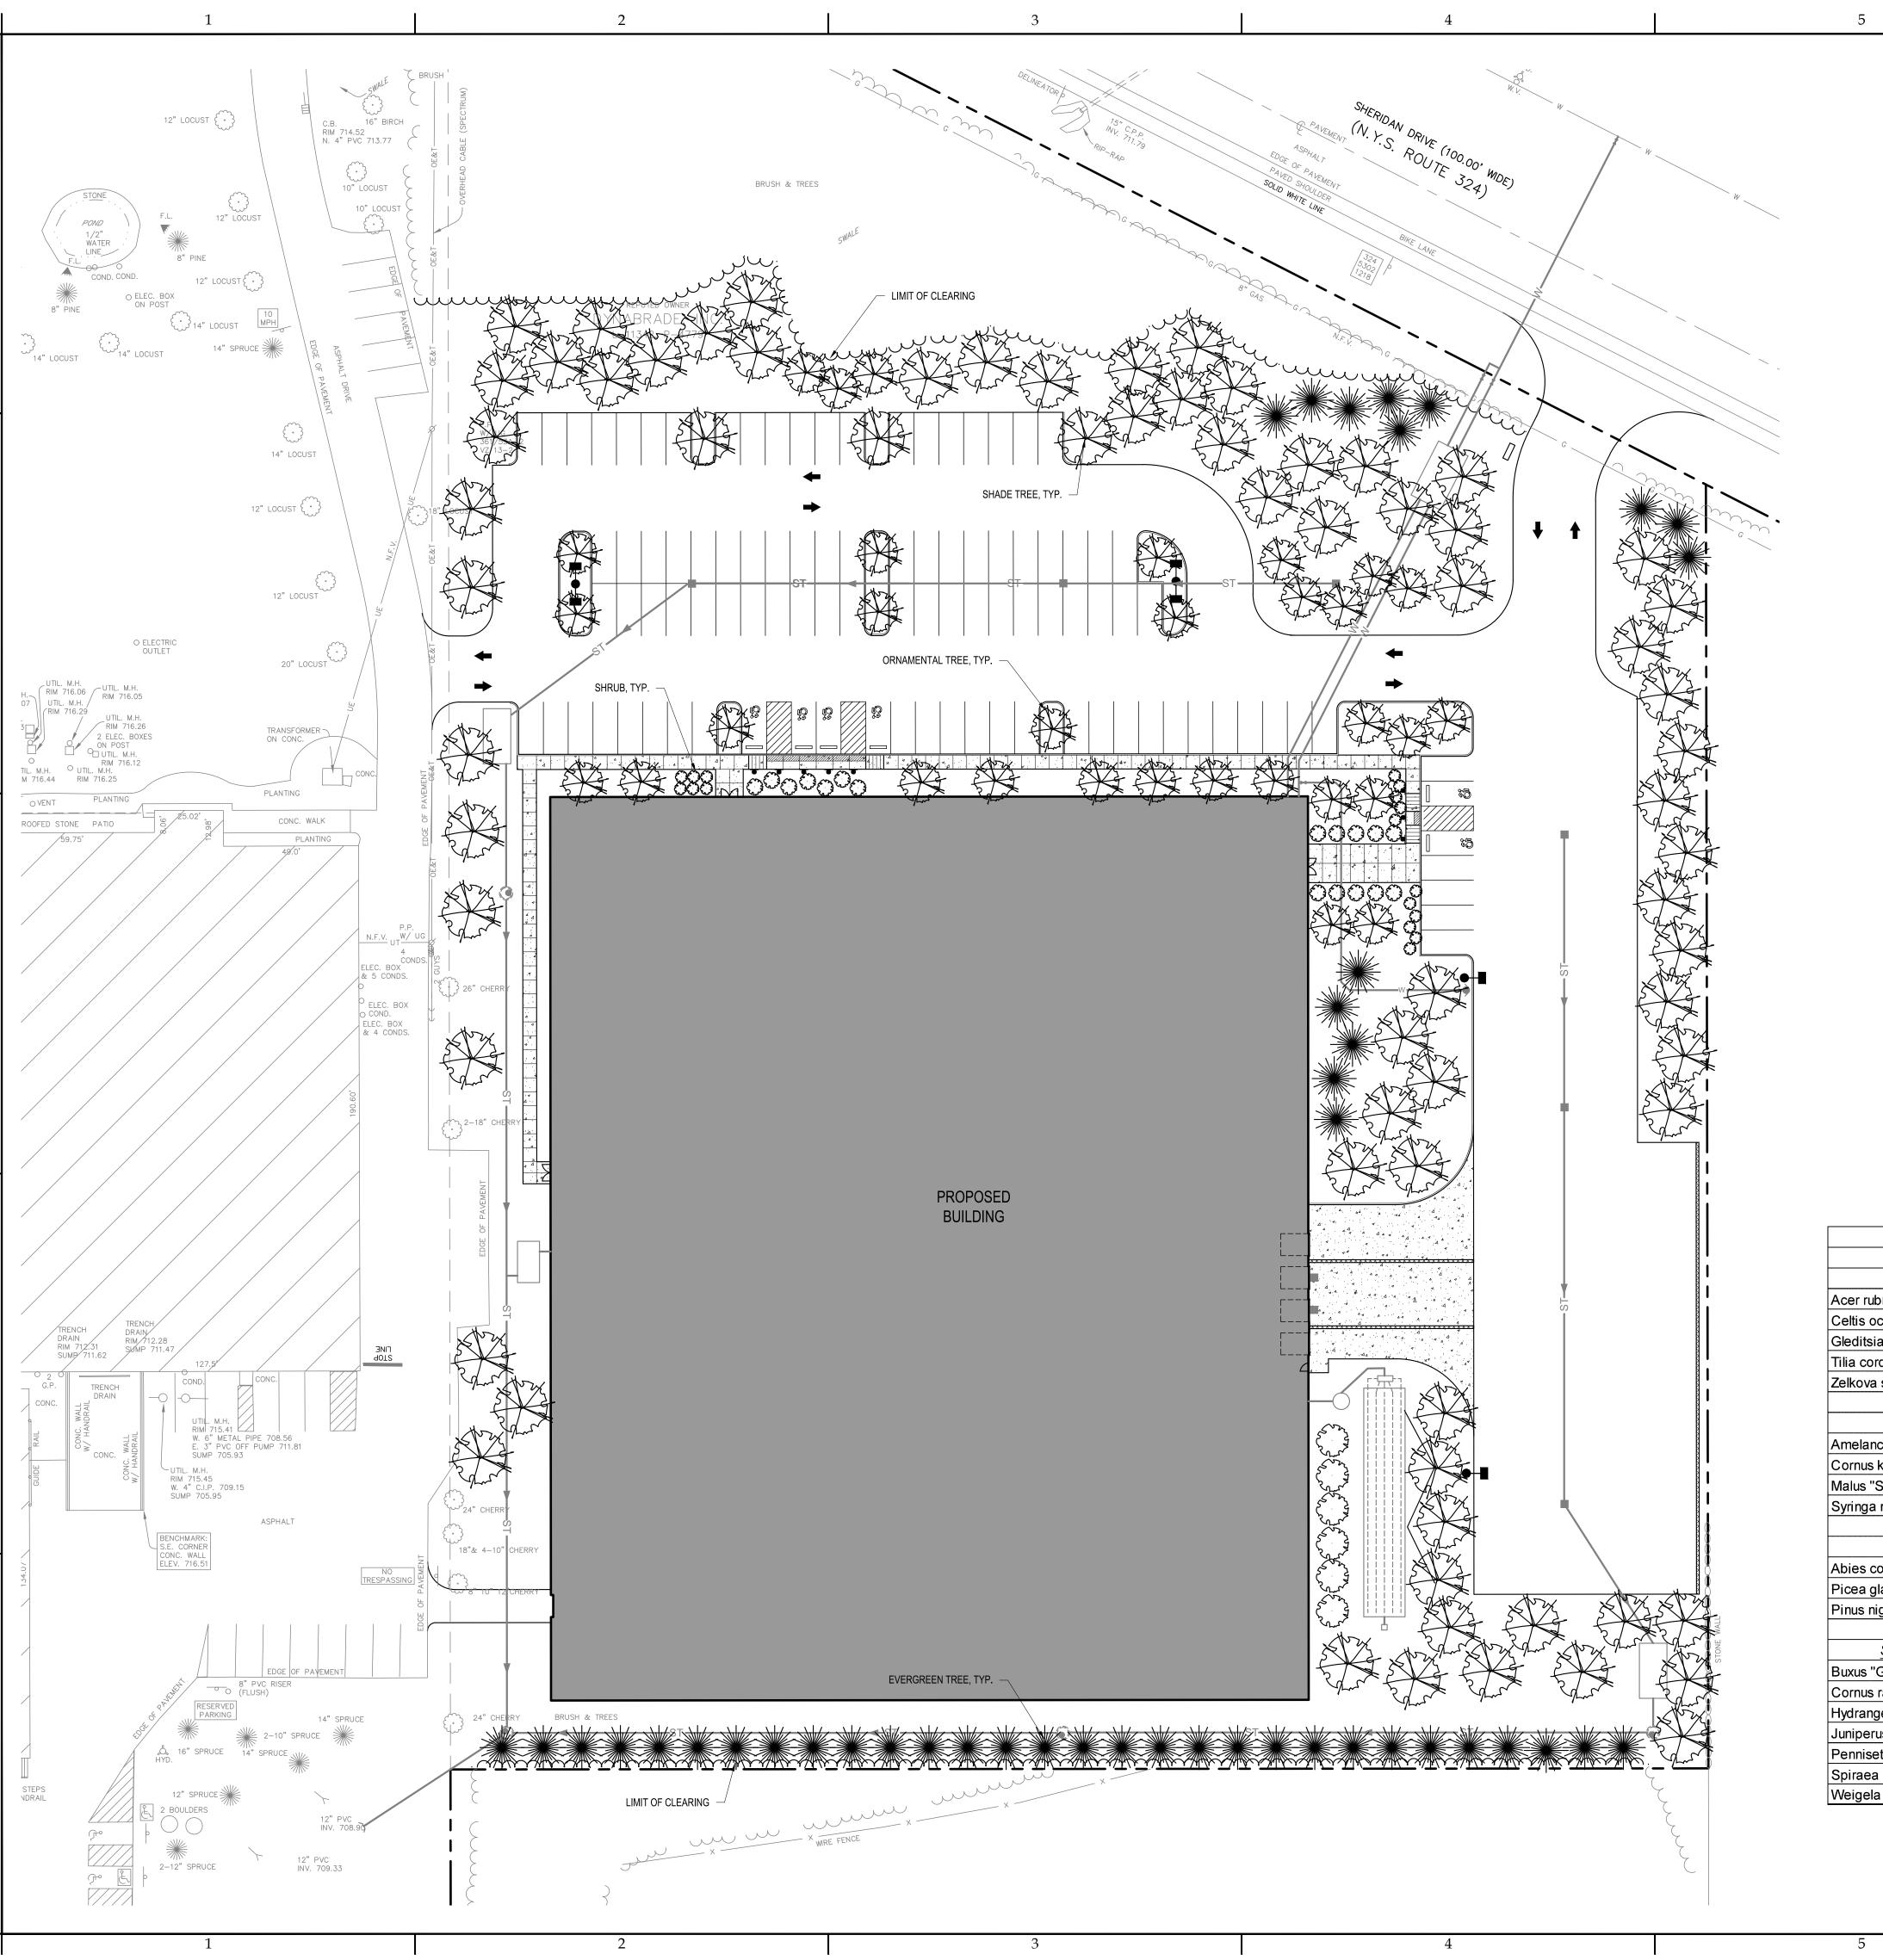

PLANTING SPECIFICATION

SCOPE OF WORK

A. THIS WORK SHALL CONSIST OF PERFORMING, CLEARING, AND GRUBBING SOIL PREPARATION, FINISH GRADING, PLANTING AND DRAINAGE INCLUDING ALL LABOR MATERIALS, TOOLS, EQUIPMENT, AND ANY OTHER APPURTENANCES NECESSARY FOR THE COMPLETION OF THE PROJECT.

A. PLANTS - ALL PLANTS SHALL BE HEALTHY, OF NORMAL GROWTH, WELL ROOTED, FREE FROM DISEASE AND INSECTS. QUALITY AND PLANT MATERIAL SHALL CONFORM TO THE AMERICAN STANDARDS FOR NURSERY STOCK (ANSI Z60.1) AND BE OF NUMBER ONE GRADE. B. VARIETIES AND SIZES OF PLANTS SHALL BE SHOWN ON DRAWING.

3. FERTILIZER A. FERTILIZER SHALL BE MILORGANITE (6-2-0) OR APPROVED EQUAL

4. GENERAL WORK PROCEDURES

A. LANDSCAPE WORK SHALL BE ACCORDING TO THE WORKMANLIKE STANDARDS ESTABLISHED FOR LANDSCAPING CONSTRUCTION AND PLANTING.

5. WEEDING A. BEFORE AND DURING PRELIMINARY GRADING AND FINISH GRADING, ALL WEEDS AND GRASSES SHALL BE DUG OUT BY THE ROOTS AND DISPOSED OF AT THE CONTRACTOR'S EXPENSE.

6. SOIL CONDITIONING A. CULTIVATE ALL AREAS TO BE PLANTED TO A DEPTH OF 6". ALL DEBRIS EXPOSED FROM EXCAVATION AND CULTIVATION SHALL BE DISPOSED OF AT THE CONTRACTOR'S EXPENSE.

7. PLANTING POSITION TREES AND SHRUBS AT THEIR INTENDED LOCATIONS AS PER THE PLANS

AND SECURE THE APPROVAL OF THE LANDSCAPE ARCHITECT BEFORE EXCAVATING PITS, MAKING NECESSARY ADJUSTMENTS AS DIRECTED. A. PLANTING PITS SHALL BE DUG WITH LEVEL BOTTOMS, AS SHOWN ON THE

- PLANTING DETAILS
- 3 PARTS TOPSOIL - 1 PART PEAT MOSS OR COMPOST
- 1/3 PART MILORGANITE FERTILIZER B. PREPARED SOIL SHALL BE TAMPED FIRMLY AT BOTTOM OF PIT. FILL PREPARED SOIL AROUND BALL OF PLANT ½ WAY, AND WATER. COMPLETE BACK-FILLING AND
- WATER THOROUGHLY. C. ALL PLANTS SHALL BE SET SO THAT, WHEN SETTLED, THEY BEAR THE SAME RELATION TO THE REQUIRED GRADE AS THEY BORE TO THE NATURAL GRADE
- BEFORE BEING TRANSPLANTED. D. IMMEDIATELY AFTER PLANTING, STAKE ALL TREES PER DETAILS AND AS DIRECTED
- BY LANDSCAPE ARCHITECT E. PREPARE RAISED EARTH SAUCER AS WIDE AS PLANTING HOLE OF EACH PLANT.
- F. WATER IMMEDIATELY AFTER PLANTING. WATER SHALL BE APPLIED TO EACH TREE AND SHRUB IN SUCH MANNER AS NOT TO DISTURB BACKFILL AND TO THE EXTENT THAT ALL MATERIALS IN THE PLANTING HOLE ARE THOROUGHLY SATURATED.
- G. AFTER SHRUB BEDS AND TREE SAUCERS ARE BACKFILLED AND FINE GRADED, MULCH WITH 3" DEPTH OF DARK, SHREDDED HARDWOOD BARK MULCH.

8. FINISH GRADING

- A. PLUS/MINUS .1 FOOT OF FINISH GRADE
- B. ALL LAWNS AND PLANTING AREAS SHALL BE GRADED TO A SMOOTH, EVEN UNIFORM PLANE WITH NO ABRUPT CHANGE OF SURFACE. SOIL AREAS ADJACENT TO THE BUILDING SHALL SLOPE AWAY FROM THE BUILDING.
- C. ALL PLANTING AREAS SHALL BE GRADED AND MAINTAINED TO ALLOW FREE FLOW OF SURFACE WATER.

A. CONTRACTOR SHALL GUARANTEE ALL PLANTS FOR A PERIOD OF ONE (1) YEAR

A. UPON COMPLETION OF ALL PLANTING WORK AND BEFORE FINAL ACCEPTANCE, THE CONTRACTOR SHALL REMOVE ALL MATERIAL, EQUIPMENT AND DEBRIS RESULTING FROM HIS WORK. ALL ACCEPTABLE CONDITIONS AS APPROVED BY THE OWNERS AUTHORIZED REPRESENTATIVE.


11. MAINTENANCE

MAINTENANCE PERIOD TO COMMENCE AFTER FINAL INSPECTION

A. MAINTENANCE PERIOD FOR THIS CONTRACT SHALL BE 90 CALENDAR DAYS COMMENCING AFTER FINAL INSPECTION OF CONSTRUCTION. MAINTAIN TREES, SHRUBS AND OTHER PLANTS BY PRUNING, CULTIVATING AND WEEDING AS REQUIRED FOR HEALTHY GROWTH. RESTORE PLANTING SAUCERS. TIGHTEN AND GRADES OR VERTICAL POSITION AS REQUIRED. SPRAY AS REQUIRED TO KEEP TREES AND SHRUBS FREE OF INSECTS AND DISEASE. MAINTAIN LAWNS BY NATERING, FERTILIZING, WEEDING, MOWING, TRIMMING, AND OTHER OPERATIONS SUCH AS ROLLING, REGRADING AND REPLANTING AS REQUIRED TO ESTABLISH A SMOOTH, ACCEPTABLE LAWN, FREE OF ERODED OR BARE AREAS.

BOTANICAL NAME	BOTANICAL NAME COMMON NAME	
Park and Street Trees		
Acer rubrum "October Glory"	October Glory Red Maple	2.5" Caliper
Celtis occidentalis	Hackberry	2.5" Caliper
Gleditsia tricantos inermis "Skycole"	Skyline Thornless Honeylocust	2.5" Caliper
Tilia cordata "Greenspire"	Greenspire Linden	2.5" Caliper
Zelkova serrata	Japanese Zelkova	2.5" Caliper
Ornamental Trees		
Amelanchier canadensis	Serviceberry	1.5" Caliper
Cornus kousa	Kousa Dogwood	1.5" Caliper
Malus "Spring Snow"	Spring Snow Crabapple	1.5" Caliper
Syringa reticulata "lvory Silk"	Ivory Silk Tree Lilac	1.5" Caliper
Evergreen Trees		
Abies concolor	White Fir	5-6' Ht.
Picea glauca	White Spruce	5-6' Ht.

Abies concolor	vvnite Fir	5-6' Ht.
Picea glauca	White Spruce	5-6' Ht.
Pinus nigra	Austrian Pine	5-6' Ht.
Shrubs, Perennials and Grasses		
Buxus "Green Velvet"	Green Velvet Boxwood	24" Ht.
Cornus racemosa "Muszam"	Muskingum Gray Dogwood	24" Ht.
Hydrangea macrophylla "Jane"	Little Lime Hydrangea	24" Ht.
Juniperus chinensis "Old Gold"	Old Gold Juniper	24" Ht.
Pennisetum alopecuroides "Hameln"	Hameln Fountain Grass	24" Ht.
Spiraea bumalda "Gold Flame"	Gold Flame Spirea	24" Ht.
Weigela florida "Alexandra"	Wine & Roses Weigela	24" Ht.

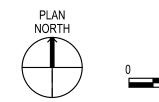

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NEW 90,000 SF BUILDING FOR: DYNABRADE

8989 SHERIDAN DRIVE CLARENCE, NY

ISSUE:

SA PROJECT TEAM: PRINCIPAL P.Silvestri

PROJ. ARCH. _____ DRAFTER M.Velocci JOB CAPT. <u>M.Velocci</u> INTERIORS <u>N.Winnert</u>




LANDSCAPING PLAN




DATE: SA JOB #:

22102.05 | 8/5/2024

C-105

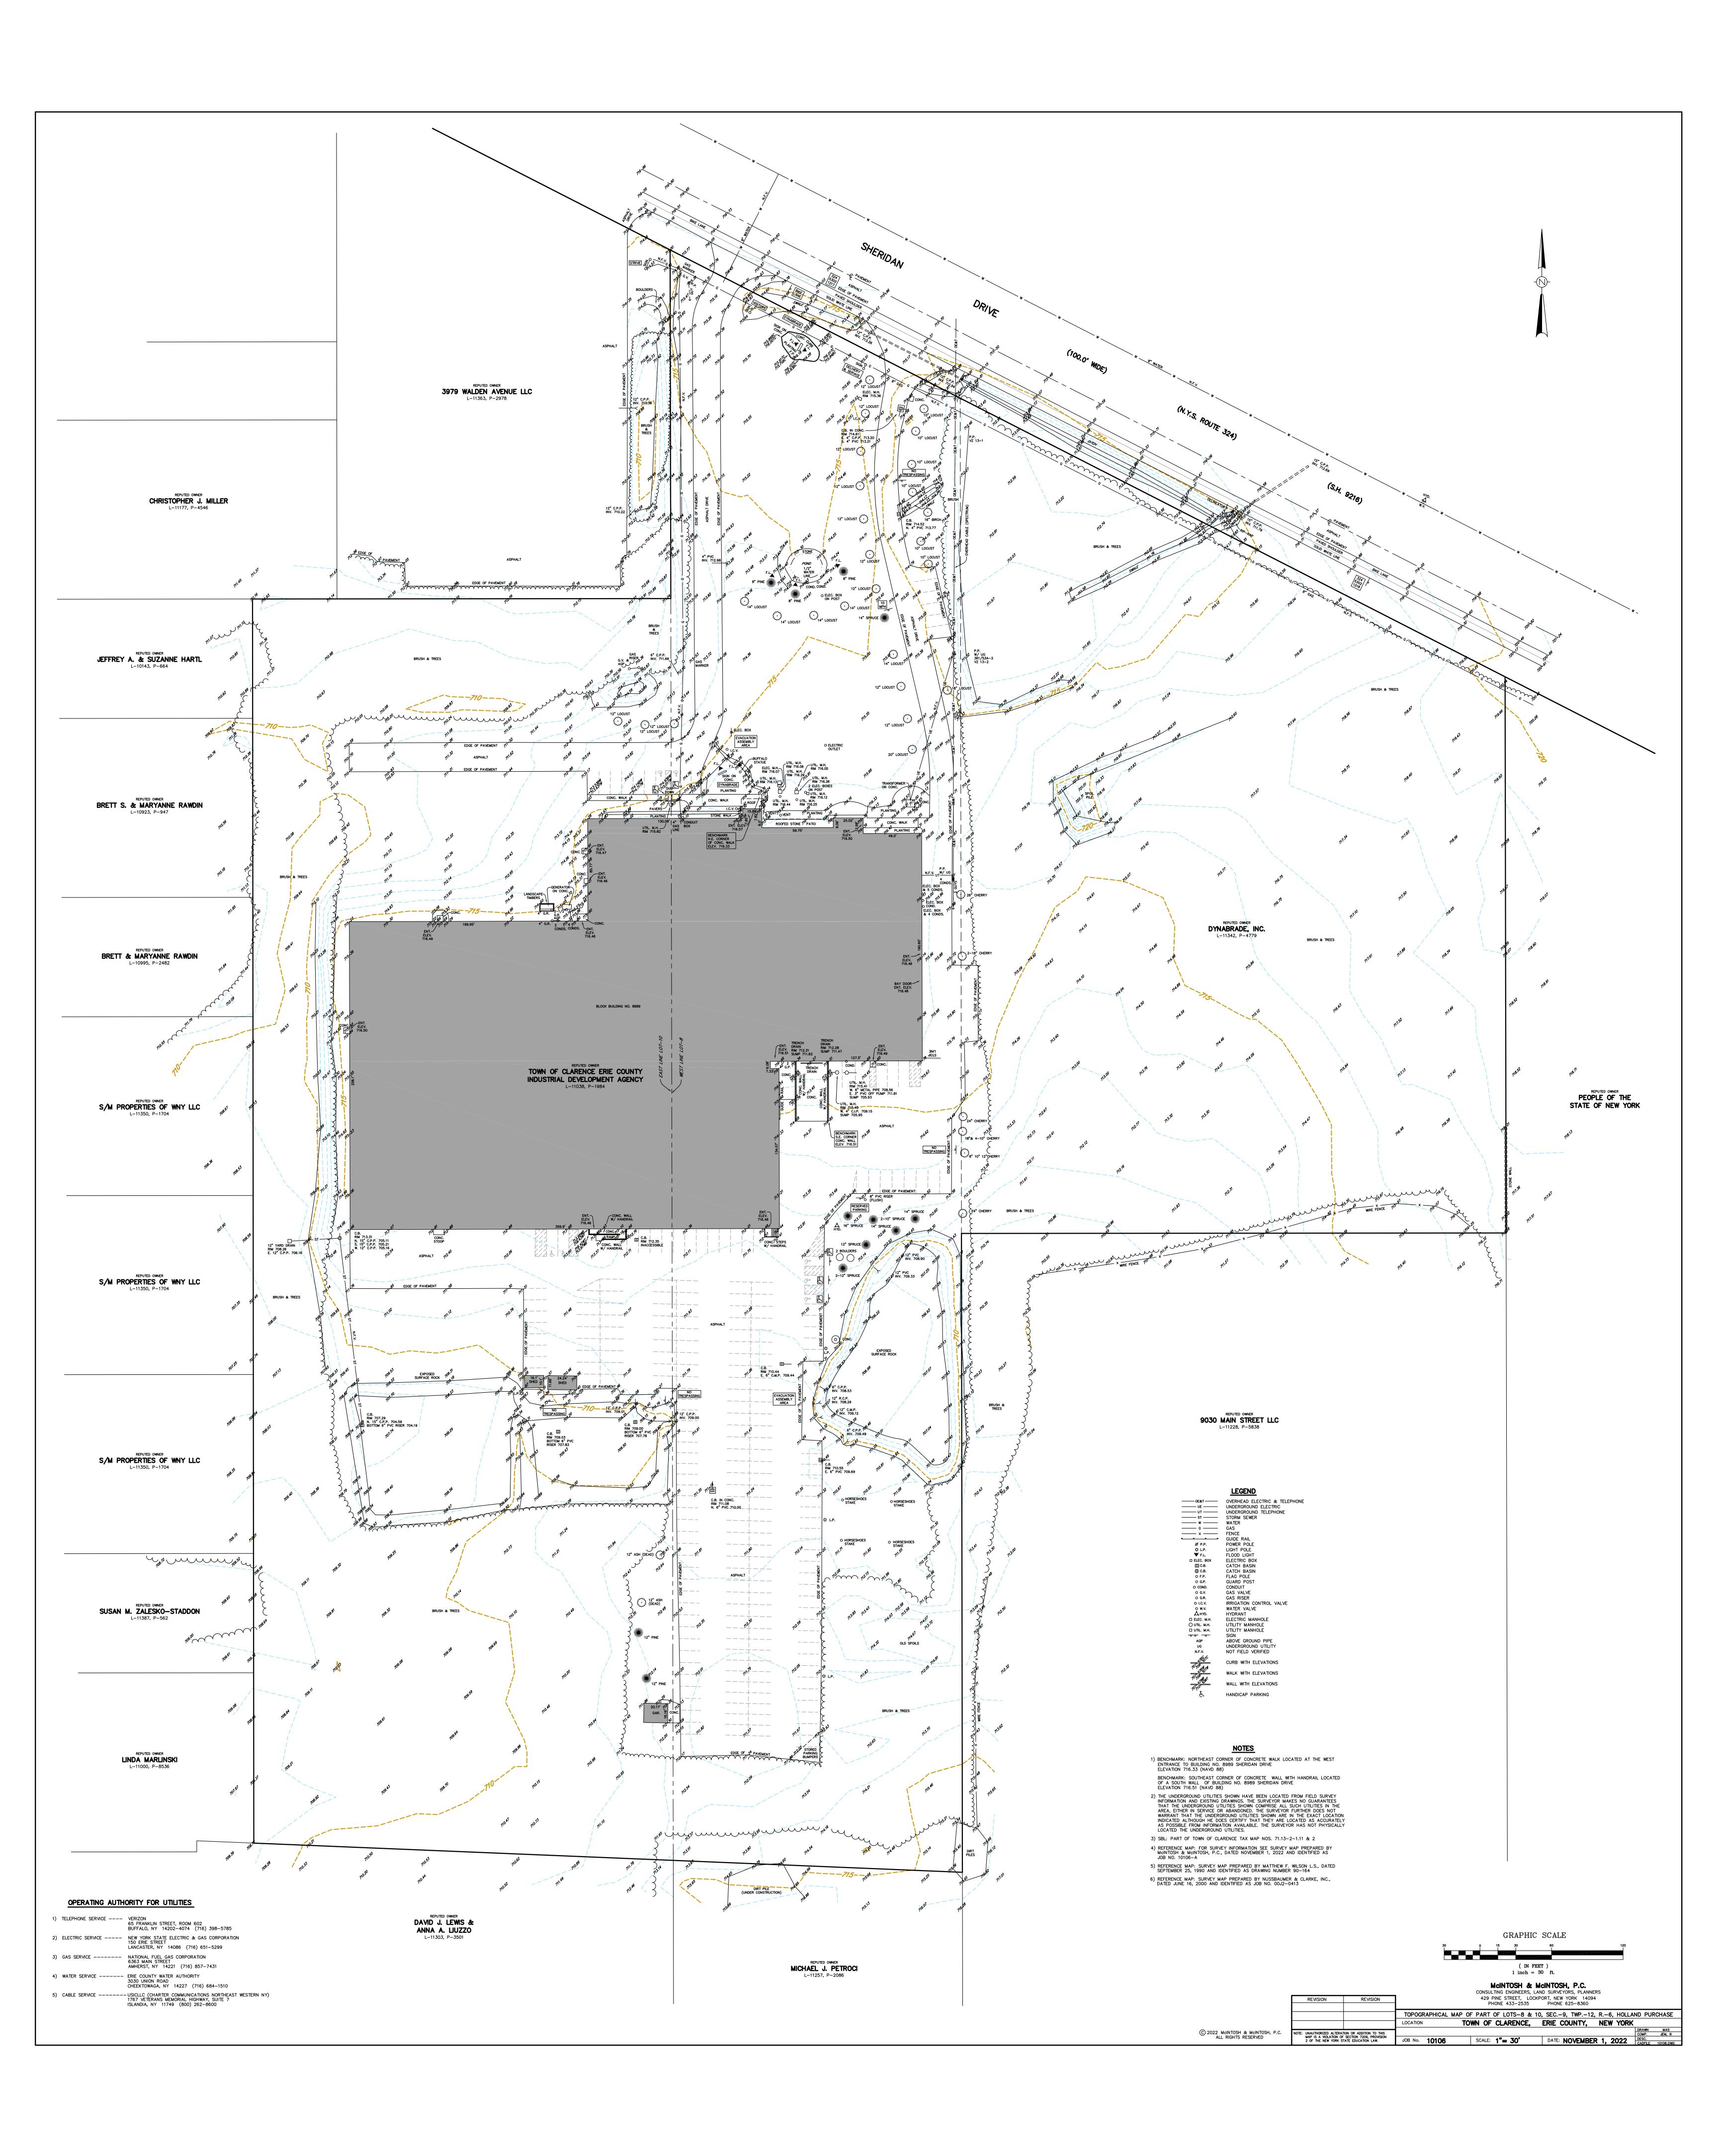

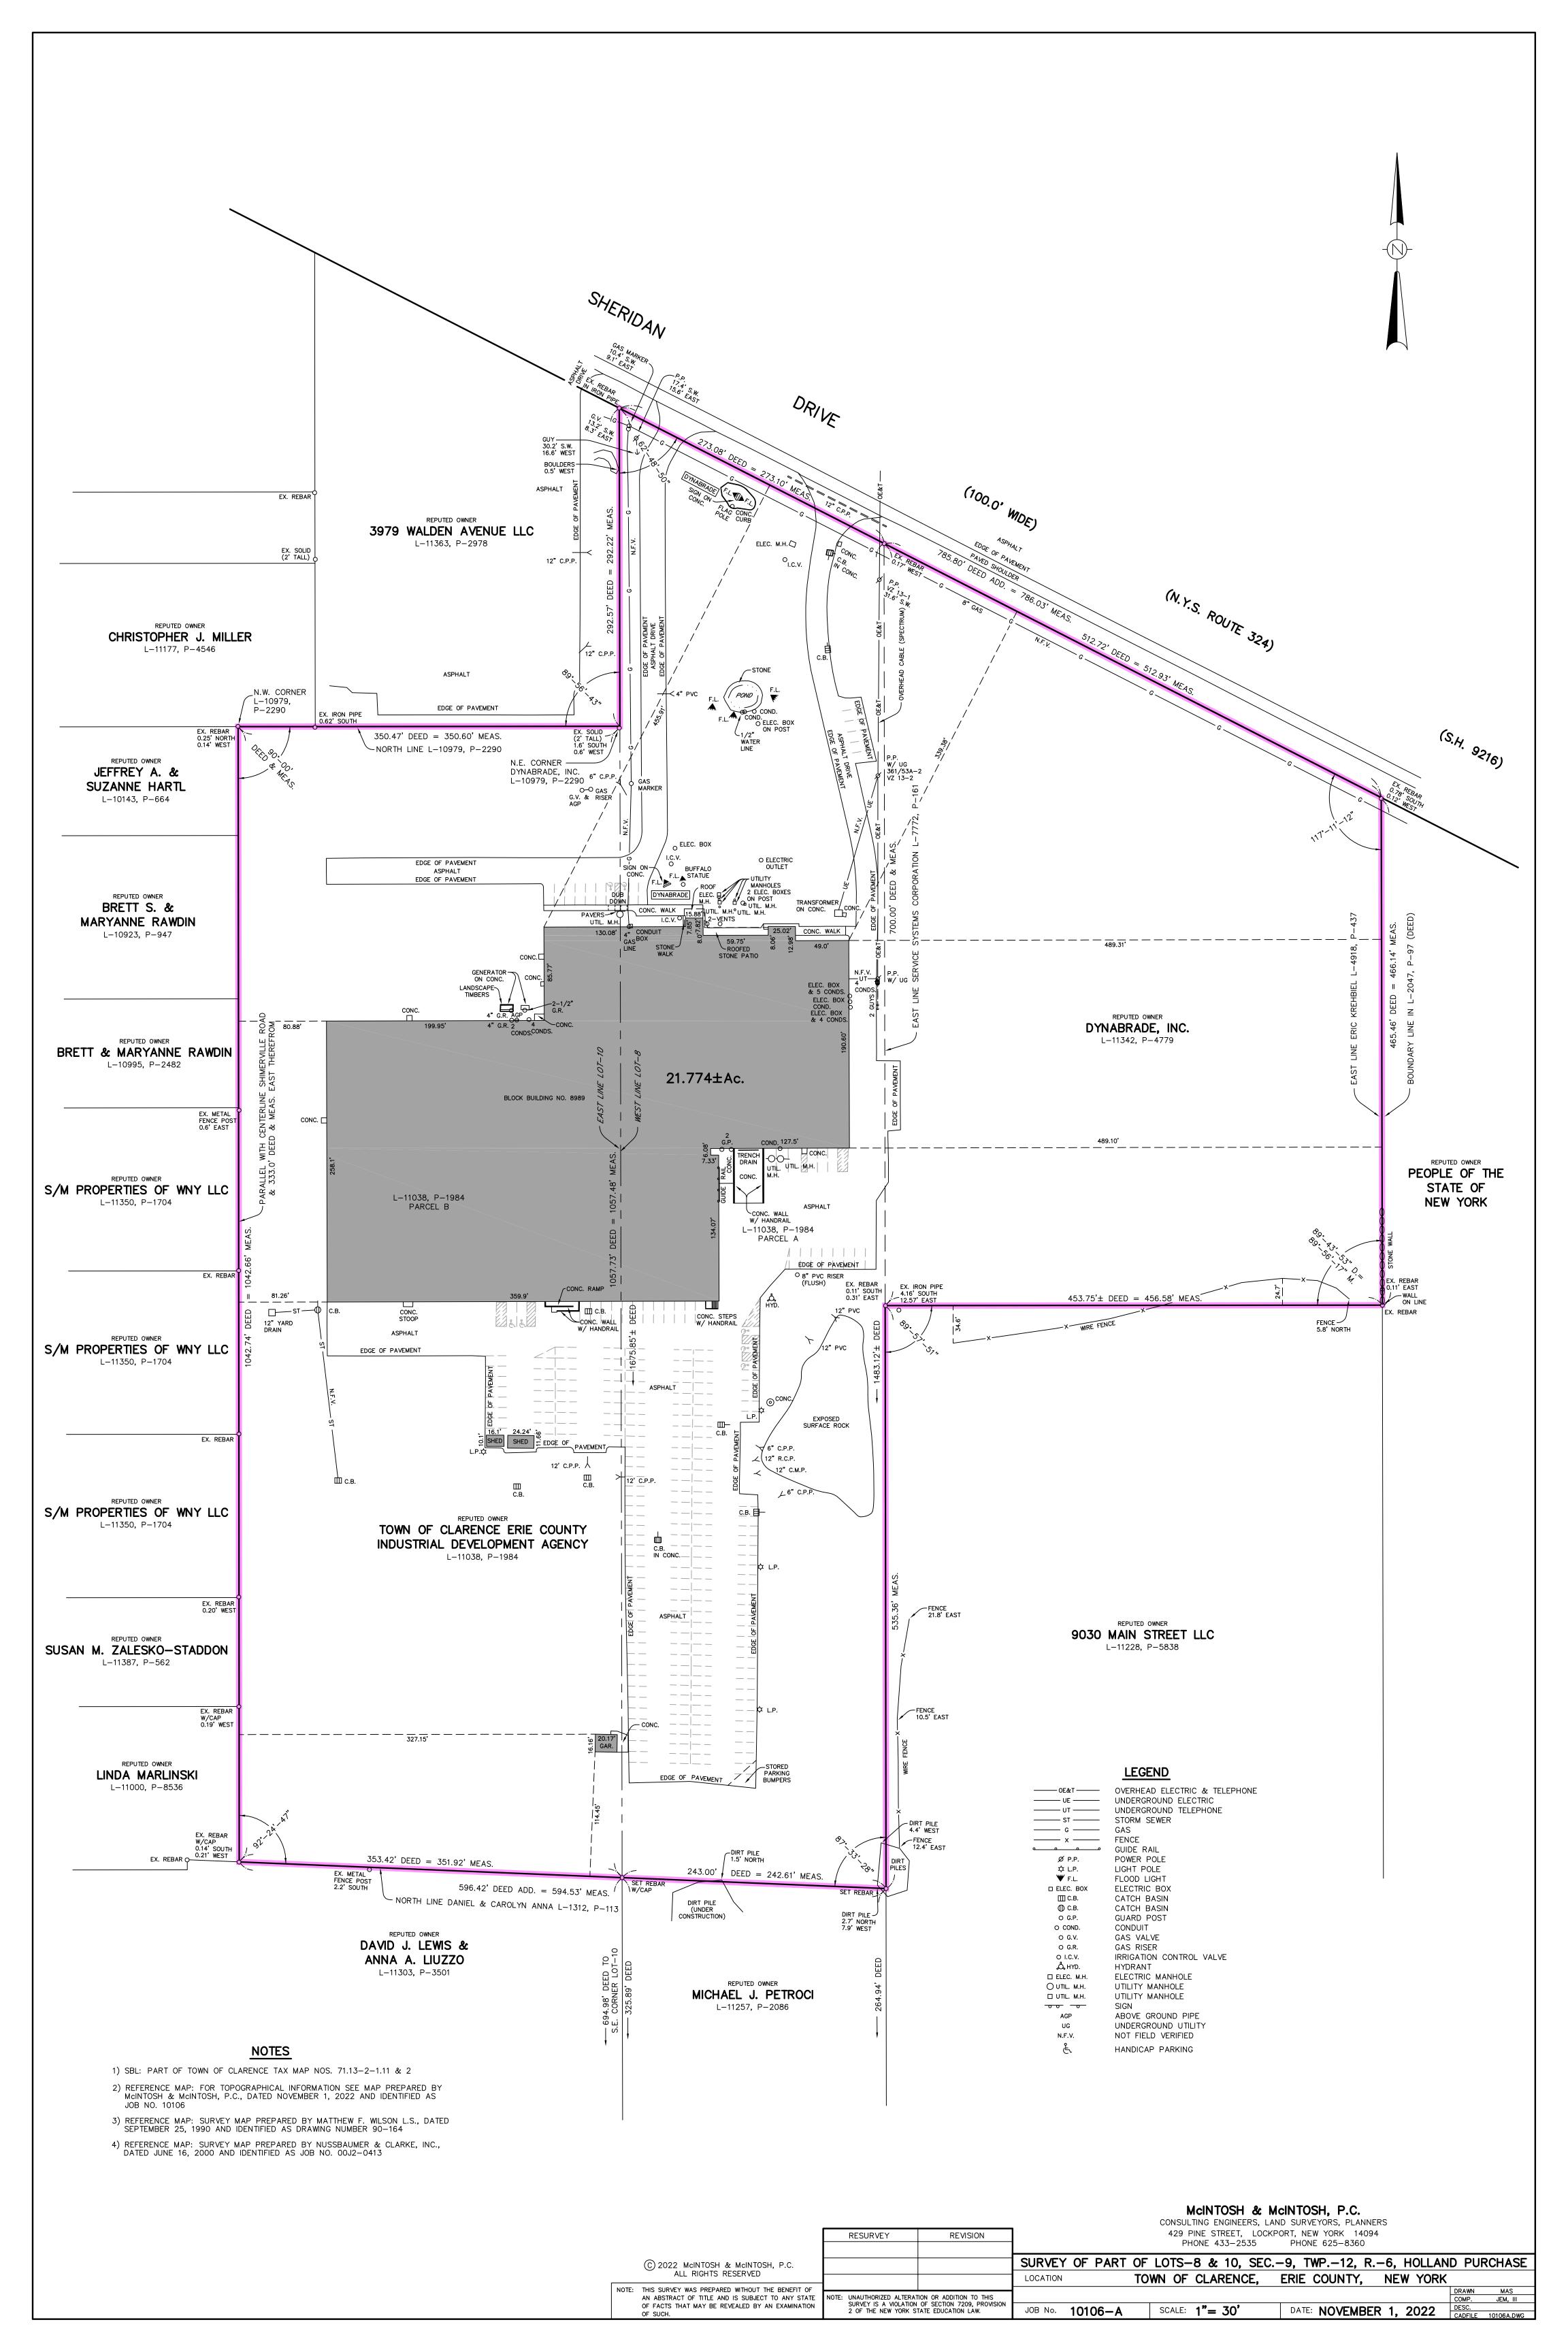

Full Environmental Assessment Form Part 1 - Project and Setting

Instructions for Completing Part 1

Part 1 is to be completed by the applicant or project sponsor. Responses become part of the application for approval or funding, are subject to public review, and may be subject to further verification.

Complete Part 1 based on information currently available. If additional research or investigation would be needed to fully respond to any item, please answer as thoroughly as possible based on current information; indicate whether missing information does not exist, or is not reasonably available to the sponsor; and, when possible, generally describe work or studies which would be necessary to update or fully develop that information.

Applicants/sponsors must complete all items in Sections A & B. In Sections C, D & E, most items contain an initial question that must be answered either "Yes" or "No". If the answer to the initial question is "Yes", complete the sub-questions that follow. If the answer to the initial question is "No", proceed to the next question. Section F allows the project sponsor to identify and attach any additional information. Section G requires the name and signature of the applicant or project sponsor to verify that the information contained in Part 1 is accurate and complete.

A. Project and Applicant/Sponsor Information.

Name of Action or Project:		
Dynabrade - New 90,000 sf Building & Site Improvements		
Project Location (describe, and attach a general location map):		
8989 Sheridan Drive, Clarence, NY 14031		
Brief Description of Proposed Action (include purpose or need):		
The applicant is proposing to construct a 90,000 square foot, single-story manufactur will include asphalt paved parking lots for 99 vehicles (including 6 ADA accessible sp Site utilities include a stormwater management system, new septic system and new or septic system.	aces), two (2) deep docks, 1 at-g	rade loading dock and site utilities.
Name of Applicant/Sponsor:	Telephone: 716-631-	0100 ext. 109
Dyanbrade, Inc. (contact: Colin Brogan)	E-Mail: colin.brogan(@dynabrade.com
Address: 8989 Sheridan Drive		
City/PO: Clarence	State: NY	Zip Code: 14031
Project Contact (if not same as sponsor; give name and title/role):	Telephone: 716-955-	3013
C&S Engineers, Inc. (contact: Jason Utzig, P.E.)	E-Mail: jutzig@cscos	com
Address: 141 Elm Street, Suite 100		
City/PO:	State:	Zip Code:
Buffalo	NY	14203
Property Owner (if not same as sponsor):	Telephone:	1
	E-Mail:	
Address:		
City/PO:	State:	Zip Code:

B. Government Approvals

B. Government Approvals, Funding, or Spor assistance.)	nsorship. ("Funding" includes grants, loans, ta	ax relief, and any other	r forms of financial
Government Entity	If Yes: Identify Agency and Approval(s) Required	Application Date (Actual or projected)	
a. City Counsel, Town Board, ✓ Yes□No or Village Board of Trustees	Site Plan Approval	August 2024	
b. City, Town or Village ✓ Yes No Planning Board or Commission	Site Plan Approval	August 2024	
c. City, Town or ☐Yes ☑No Village Zoning Board of Appeals			
d. Other local agencies ∠ Yes No	Erie County Water Authority - Backflow Prevention	September 2024	
e. County agencies ∠ Yes N o	Erie County Health Dept - Septic System Approval	September 2024	
f. Regional agencies ☐Yes ☑No			
g. State agencies ✓ Yes□No	NYSDOT - Perm 33-COM (Curb Cut) NYSDEC - SPDES Permit	September 2024	
h. Federal agencies □Yes ☑No			
 i. Coastal Resources. i. Is the project site within a Coastal Area, or the waterfront area of a Designated Inland Waterway? ii. Is the project site located in a community with an approved Local Waterfront Revitalization Program? iii. Is the project site within a Coastal Erosion Hazard Area? 			☐ Yes ✓ No ☐ Yes ✓ No ☐ Yes ✓ No
C. Planning and Zoning			
C.1. Planning and zoning actions.			
 Will administrative or legislative adoption, or an only approval(s) which must be granted to enable of the sections C, F and G. If No, proceed to question C.2 and con 			□Yes Z No
C.2. Adopted land use plans.			
a. Do any municipally- adopted (city, town, village or county) comprehensive land use plan(s) include the site where the proposed action would be located? If Yes, does the comprehensive plan include specific recommendations for the site where the proposed action would be located?			Z Yes□No Z Yes□No
b. Is the site of the proposed action within any I Brownfield Opportunity Area (BOA); design or other?) If Yes, identify the plan(s): NYS Heritage Areas:West Erie Canal Corridor	ocal or regional special planning district (for e ated State or Federal heritage area; watershed		∠ Yes□No
c. Is the proposed action located wholly or part or an adopted municipal farmland protection If Yes, identify the plan(s):		pal open space plan,	□Yes ✓ No

If Yes, what is the zoning classification(s) including any applicable overlay district? Commercial Yes New Commercial	C.3. Zoning	
c. Is a zoning change requested as part of the proposed action? Yes \overline{\textsf{N}} Yes If Yes, What is the proposed new zoning for the site? C.4. Existing community services. a. In what school district is the project site located? Clarence Central School District b. What police or other public protection forces serve the project site?	a. Is the site of the proposed action located in a municipality with an adopted zoning law If Yes, what is the zoning classification(s) including any applicable overlay district? Commercial	v or ordinance. ✓ Yes□No
If Yes, i. What is the proposed new zoning for the site? C.4. Existing community services. a. In what school district is the project site located? Clarence Central School District b. What police or other public protection forces serve the project site? Vew York State Police and Erie County Sheriff c. Which fire protection and emergency medical services serve the project site? Indians Hill Fire Company d. What parks serve the project site? Thompson Road Park, Town Place Park, Harris Hill Park D. Project Details D.I. Proposed and Potential Development a. What is the general nature of the proposed action (e.g., residential, industrial, commercial, recreational; if mixed, include all components)? Commercial, Warehouse, Office b. a. Total acreage of the site of the proposed action? b. Total acreage (project site and any contiguous properties) owned or controlled by the applicant or project sponsor? c. Is the proposed action an expansion of an existing project or use? i. If Yes, what is the approximate percentage of the proposed expansion and identify the units (e.g., acres, miles, housing units square feet)? i. Is a proposed action a subdivision, or does it include a subdivision? If Yes, i. Purpose or type of subdivision? (e.g., residential, industrial, commercial; if mixed, specify types) ii. Is a cluster/conservation layout proposed? iii. Number of lots proposed action be constructed in multiple phases? In Yes, In Yes, Will the proposed action be constructed in multiple phases? In Yes In Yes,	b. Is the use permitted or allowed by a special or conditional use permit?	✓ Yes No
a. In what school district is the project site located? Clarence Central School District b. What police or other public protection forces serve the project site? New York State Police and Eric County Sheriff c. Which fire protection and emergency medical services serve the project site? Interpretation and emergency medical services serve the project site? Interpretation and emergency medical services serve the project site? Interpretation and emergency medical services serve the project site? Interpretation and emergency medical services serve the project site? Interpretation and Protection and emergency medical services serve the project site? Interpretation and Protection and emergency medical services serve the project site? Interpretation and Protection and emergency medical services serve the project site? Interpretation and Protection and emergency medical services serve the project site? Interpretation and Protection and emergency medical services serve the project site? Interpretation and Protection and emergency medical services serve the project site? Interpretation and Protection and emergency medical services serve the project site? Interpretation and Protection and emergency medical services serve the project site? Interpretation and Protection and emergency medical services serve the project site? Interpretation and emergency medical services serve the project site? Interpretation and emergency medical services serve the project site? Interpretation and emergency medical services serve the project site? Interpretation and emergency medical services serve the project site? Interpretation and emergency medical services serve the project site? Interpretation and emergency medical services serve the project site? Interpretation and emergency medical services serve the project site? Interpretation and emergency medical services serve the project site? Interpretation and emergency medical services serve the project site? Interpretation and emergency medical services serve the p	c. Is a zoning change requested as part of the proposed action? If Yes, i. What is the proposed new zoning for the site?	☐ Yes Z No
b. What police or other public protection forces serve the project site? New York State Police and Eric County Sheriff c. Which fire protection and emergency medical services serve the project site? Idarris Hill Fire Company d. What parks serve the project site? Thompson Road Park, Town Place Park, Harris Hill Park D. Project Details D.I. Proposed and Potential Development a. What is the general nature of the proposed action (e.g., residential, industrial, commercial, recreational; if mixed, include all components)? Commercial, Warehouse, Office b. a. Total acreage of the site of the proposed action? b. Total acreage of the site of the proposed action? c. Total acreage (project site and any contiguous properties) owned or controlled by the applicant or project sponsor? c. Is the proposed action an expansion of an existing project or use? i. If Yes, what is the approximate percentage of the proposed expansion and identify the units (e.g., acres, miles, housing units square feet)? d. Is the proposed action a subdivision, or does it include a subdivision? If Yes, i. Purpose or type of subdivision? (e.g., residential, industrial, commercial; if mixed, specify types) ii. Is a cluster/conservation layout proposed? iii. Number of lots proposed? iv. Minimum and maximum proposed lot sizes? Minimum Maximum d. Whatinum and maximum proposed lot sizes? Minimum Maximum yes \infty Yes \infty Maximum yes \infty Yes \infty Yes \infty Yes \infty Will the proposed action be constructed in multiple phases?	C.4. Existing community services.	
New York State Police and Eric County Sheriff c. Which fire protection and emergency medical services serve the project site?	a. In what school district is the project site located? Clarence Central School District	
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b. Total acreage to be physically disturbed? c. Total acreage (project site and any contiguous properties) owned or controlled by the applicant or project sponsor? 21.83 acres c. Is the proposed action an expansion of an existing project or use? i. If Yes, what is the approximate percentage of the proposed expansion and identify the units (e.g., acres, miles, housing units square feet)? d. Is the proposed action a subdivision, or does it include a subdivision? If Yes, i. Purpose or type of subdivision? (e.g., residential, industrial, commercial; if mixed, specify types) ii. Is a cluster/conservation layout proposed? iii. Number of lots proposed? iii. Number of lots proposed? iii. Number of lots proposed? iii. Maximum Maximum Maximum proposed lot sizes? Minimum Maximum e. Will the proposed action be constructed in multiple phases?		cial, recreational; if mixed, include all
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 i. Purpose or type of subdivision? (e.g., residential, industrial, commercial; if mixed, specify types) ii. Is a cluster/conservation layout proposed? iii. Number of lots proposed?	d. Is the proposed action a subdivision, or does it include a subdivision?	Yes Z No
 iii. Number of lots proposed?		pecify types)
e. Will the proposed action be constructed in multiple phases? ☐ Yes ✓ N		□Yes□No
ii. If Yes:	e. Will the proposed action be constructed in multiple phases? i. If No, anticipated period of construction: ii. If Yes:	☐ Yes Z No months
 Total number of phases anticipated Anticipated commencement date of phase 1 (including demolition) month year Anticipated completion date of final phase month year Generally describe connections or relationships among phases, including any contingencies where progress of one phased determine timing or duration of future phases: 	 Anticipated commencement date of phase 1 (including demolition) Anticipated completion date of final phase Generally describe connections or relationships among phases, including any complete. 	monthyear ontingencies where progress of one phase may

	t include new resid				□Yes ☑ No
If Yes, show num	bers of units propo One Family	sed. Two Family	Three Family	Multiple Family (four or more)	
	One ranniy	1 wo ranniy	Three Family	Multiple Failing (Tour of more)	
Initial Phase					
At completion of all phases					
of an phases			<u> </u>		
	sed action include	new non-residentia	al construction (incl	uding expansions)?	∠ Yes N o
If Yes,	of structures	1			
i. Total number	in feet) of largest n	roposed structure:	30'-9 5/8" height	275 width; and 325 length	
<i>iii</i> . Approximate	extent of building	space to be heated	or cooled:	90,000 square feet	
				Il result in the impoundment of any	☐Yes Z No
				agoon or other storage?	
If Yes,					
<i>i</i> . Purpose of the	impoundment:	. 1		☐ Ground water ☐ Surface water stream	
ii. If a water impo	oundment, the prin	cipal source of the	water:	Ground water Surface water stream	ns Other specify:
iii. If other than w	vater, identify the ty	ype of impounded/o	contained liquids ar	d their source.	
· A	-:	1:	V-1		
v Dimensions of	size of the propose f the proposed dam	a impounament. Lor impounding str	volume:	million gallons; surface area:height;length	acres
vi. Construction	method/materials 1	for the proposed da	m or impounding st	ructure (e.g., earth fill, rock, wood, cond	crete):
		1 1			
D.2. Project Ope					
				luring construction, operations, or both?	□Yes ⊘ No
		ation, grading or in	stallation of utilities	s or foundations where all excavated	
materials will re If Yes:	emain onsite)				
	rnose of the excava	ation or dredging?			
ii. How much man	terial (including ro	ck, earth, sediment	s, etc.) is proposed	to be removed from the site?	
 Volume 	(specify tons or cu	bic yards):			
Over wh	at duration of time	?			
<i>iii</i> . Describe natui	e and characteristi	cs of materials to b	e excavated or dred	ged, and plans to use, manage or dispose	e of them.
		or processing of ex	cavated materials?		☐Yes ☐No
If yes, descril	oe				
w What is the to	tal area to be drade	rad or avagyated?		garas	
v. What is the to	tal area to be dredg aximum area to be	worked at any one	time?	acres acres	
vii. What would b	e the maximum de	oth of excavation of	or dredging?	feet	
	vation require blas				□Yes□No
1 117 114	1	47 4 45	· · · · ·		
			on of, increase or de ch or adjacent area	ecrease in size of, or encroachment	☐Yes No
If Yes:	ng wenanu, watero	ouy, shorenne, bea	on or aujacem area.		
	etland or waterbod	ly which would be	affected (by name,	water index number, wetland map numb	er or geographic
				т.	

<i>ii.</i> Describe how the proposed action would affect that waterbody or wetland, e.g. excavation, fill, placem alteration of channels, banks and shorelines. Indicate extent of activities, alterations and additions in sq	
··· Will the second of the sec	
<i>iii</i> . Will the proposed action cause or result in disturbance to bottom sediments? If Yes, describe:	□Yes□No
<i>iv.</i> Will the proposed action cause or result in the destruction or removal of aquatic vegetation?	☐Yes☐No
If Yes:	
acres of aquatic vegetation proposed to be removed:	
• purpose of proposed removal (e.g. beach clearing, invasive species control, boat access):	
proposed method of plant removal:	
 proposed method of plant removal: if chemical/herbicide treatment will be used, specify product(s): 	
v. Describe any proposed reclamation/mitigation following disturbance:	
,, become any proposed recamanion mangazion renewing distancement.	
c. Will the proposed action use, or create a new demand for water?	Z Yes □No
If Yes:	F 1 63140
i. Total anticipated water usage/demand per day: 840 gallons/day	
ii. Will the proposed action obtain water from an existing public water supply?	Z Yes □No
If Yes:	
Name of district or service area: Erie County Water Authority	
 Does the existing public water supply have capacity to serve the proposal? 	✓ Yes No
• Is the project site in the existing district?	∠ Yes No
• Is expansion of the district needed?	☐ Yes 🗹 No
Do existing lines serve the project site?	∠ Yes □ No
iii. Will line extension within an existing district be necessary to supply the project?	□Yes ∠ No
If Yes:	
Describe extensions or capacity expansions proposed to serve this project:	
Source(s) of supply for the district:	
<i>iv.</i> Is a new water supply district or service area proposed to be formed to serve the project site? If, Yes:	☐ Yes ☑ No
Applicant/sponsor for new district:	
Date application submitted or anticipated:	
 Proposed source(s) of supply for new district: v. If a public water supply will not be used, describe plans to provide water supply for the project: 	
v. If a public water supply will not be used, describe plans to provide water supply for the project:	
vi. If water supply will be from wells (public or private), what is the maximum pumping capacity:	gallons/minute.
d. Will the proposed action generate liquid wastes?	✓ Yes □No
If Yes:	
i. Total anticipated liquid waste generation per day:840 gallons/day	
ii. Nature of liquid wastes to be generated (e.g., sanitary wastewater, industrial; if combination, describe al	
approximate volumes or proportions of each):	
sanitary wastewater	
iii. Will the proposed action use any existing public wastewater treatment facilities? If Yes:	□Yes ⊘ No
Name of wastewater treatment plant to be used:	
Name of district: Name of district:	
 Does the existing wastewater treatment plant have capacity to serve the project? 	□Yes□No
 Is the project site in the existing district? 	□ Yes □No
 Is expansion of the district needed? 	□ Yes □No
1	

Do existing sewer lines serve the project site?	□Yes□No
 Will a line extension within an existing district be necessary to serve the project? If Yes: 	□Yes□No
 Describe extensions or capacity expansions proposed to serve this project: 	
<i>iv.</i> Will a new wastewater (sewage) treatment district be formed to serve the project site? If Yes:	☐Yes Z No
Applicant/sponsor for new district:	
Date application submitted or anticipated:	
What is the receiving water for the wastewater discharge?	
v. If public facilities will not be used, describe plans to provide wastewater treatment for the project, including speci receiving water (name and classification if surface discharge or describe subsurface disposal plans):	fying proposed
a new onsite wastewater treatment system/ septic system will be installed consisting of a bottomless sand filter with underlying di	scharge system to
bedrock	
vi. Describe any plans or designs to capture, recycle or reuse liquid waste:	
<u>N/A</u>	
Will discuss of the district o	
e. Will the proposed action disturb more than one acre and create stormwater runoff, either from new point sources (i.e. ditches, pipes, swales, curbs, gutters or other concentrated flows of stormwater) or non-point	Z Yes □No
source (i.e. sheet flow) during construction or post construction?	
If Yes:	
 i. How much impervious surface will the project create in relation to total size of project parcel? Square feet or 3.58 acres (impervious surface) 	
Square feet or 6.08 acres (impervious surface)	
ii. Describe types of new point sources. stormwater runoff	
iii. Where will the stormwater runoff be directed (i.e. on-site stormwater management facility/structures, adjacent pr	operties
groundwater, on-site surface water or off-site surface waters)?	operues,
on-site stormwater management facility. The existing on-site stormwater dry detention basin will be expanded to limit the storm	water runoff from the
proposed improvements to the existing runoff rates.	
 If to surface waters, identify receiving water bodies or wetlands: stormwater discharges through fissures in the bedrock within the existing detention basin and through three (3) existing s 	tormwater injection
wells.	.commuter injection
Will stormwater runoff flow to adjacent properties?	☐ Yes No
iv. Does the proposed plan minimize impervious surfaces, use pervious materials or collect and re-use stormwater?	
f. Does the proposed action include, or will it use on-site, one or more sources of air emissions, including fuel combustion, waste incineration, or other processes or operations?	□Yes ☑ No
If Yes, identify:	
i. Mobile sources during project operations (e.g., heavy equipment, fleet or delivery vehicles)	
:: Chatianam assumes during construction (a.g. normal construction atmost well heating heating heating heating	
ii. Stationary sources during construction (e.g., power generation, structural heating, batch plant, crushers)	
iii. Stationary sources during operations (e.g., process emissions, large boilers, electric generation)	
g. Will any air emission sources named in D.2.f (above), require a NY State Air Registration, Air Facility Permit,	Yes ☑ No
or Federal Clean Air Act Title IV or Title V Permit?	
If Yes:	
i. Is the project site located in an Air quality non-attainment area? (Area routinely or periodically fails to meet	
	□Yes□No
ambient air quality standards for all or some parts of the year)	□Yes□No
ambient air quality standards for all or some parts of the year) ii. In addition to emissions as calculated in the application, the project will generate:	□Yes□No
ambient air quality standards for all or some parts of the year) ii. In addition to emissions as calculated in the application, the project will generate:	□Yes□No
ambient air quality standards for all or some parts of the year) ii. In addition to emissions as calculated in the application, the project will generate: Tons/year (short tons) of Carbon Dioxide (CO ₂) Tons/year (short tons) of Nitrous Oxide (N ₂ O) Tons/year (short tons) of Perfluorocarbons (PFCs)	□Yes□No
ambient air quality standards for all or some parts of the year) ii. In addition to emissions as calculated in the application, the project will generate: Tons/year (short tons) of Carbon Dioxide (CO ₂) Tons/year (short tons) of Nitrous Oxide (N ₂ O)	□Yes□No

h. Will the proposed action generate or emit methane (included landfills, composting facilities)? If Yes: i. Estimate methane generation in tons/year (metric):	ling, but not limited to, sewage treatment plants,	∐Yes ☑ No
ii. Describe any methane capture, control or elimination measure electricity, flaring):		enerate heat or
i. Will the proposed action result in the release of air pollutar quarry or landfill operations? If Yes: Describe operations and nature of emissions (e.g., die		□Yes ☑ No
 j. Will the proposed action result in a substantial increase in new demand for transportation facilities or services? If Yes: i. When is the peak traffic expected (Check all that apply): Randomly between hours of	☐ Morning ☐ Evening ☐ Weekend	Yes Z No
 iii. Parking spaces: Existing	g? sting roads, creation of new roads or change in existing available within ½ mile of the proposed site? ortation or accommodations for use of hybrid, electric	□Yes□No
 k. Will the proposed action (for commercial or industrial profor energy? If Yes: i. Estimate annual electricity demand during operation of the Unknown ii. Anticipated sources/suppliers of electricity for the project other): NYSEG iii. Will the proposed action require a new, or an upgrade, to 	ne proposed action:t (e.g., on-site renewable, via grid/lo	
1. Hours of operation. Answer all items which apply. i. During Construction: Monday - Friday: 7am-5pm Saturday: N/A Sunday: N/A Holidays: N/A	 ii. During Operations: Monday - Friday: Saturday: Sunday: Holidays: 	

	Will the proposed action produce noise that will exceed existing ambient noise levels during construction, operation, or both?	Z Yes □No
If y	ves:	
i.	Provide details including sources, time of day and duration:	
davt	The use of construction equipment and construction activities during the construction of this project will result in unavoidable not ime hours.	se impacts during
ii.	Will the proposed action remove existing natural barriers that could act as a noise barrier or screen? Describe:	☐ Yes Z No
n. '	Will the proposed action have outdoor lighting?	✓ Yes □No
	yes:	
	Describe source(s), location(s), height of fixture(s), direction/aim, and proximity to nearest occupied structures:	
New	exterior lighting to comply with the Town of Clarence Town Code.	
,,	Will an and a discount and the control bearing that and a discount	☐ Yes ☑ No
	Will proposed action remove existing natural barriers that could act as a light barrier or screen?	□ Yes ≥ INO
	Describe:	
0.	Does the proposed action have the potential to produce odors for more than one hour per day?	☐ Yes Z No
	If Yes, describe possible sources, potential frequency and duration of odor emissions, and proximity to nearest occupied structures:	
	occupied structures:	
	Will the proposed action include any bulk storage of petroleum (combined capacity of over 1,100 gallons)	☐ Yes ☑ No
	or chemical products 185 gallons in above ground storage or any amount in underground storage? Yes:	
	Dog dyat(s) to be stored	
ii.	Volume(s) per unit time (e.g., month, year)	
iii.	Generally, describe the proposed storage facilities:	
	Will the proposed action (commercial, industrial and recreational projects only) use pesticides (i.e., herbicides,	☐ Yes ☑ No
	insecticides) during construction or operation?	
	Yes:	
ı	i. Describe proposed treatment(s):	
	Will the proposed action use Integrated Pest Management Practices?	☐ Yes ☐No
	Will the proposed action (commercial or industrial projects only) involve or require the management or disposal	✓ Yes □No
	of solid waste (excluding hazardous materials)?	
	Yes: Describe any solid waste(s) to be generated during construction or operation of the facility:	
ι.	Construction: to be determined tons per (unit of time)	
	Operation:	
ii.	Describe any proposals for on-site minimization, recycling or reuse of materials to avoid disposal as solid waste:	
	Construction: Recycling of salvageable construction items.	
	Operation: Recycling programs by use.	
,,,	Duamaged diamaged matheds/facilities for solid wests conserted as a site.	
111.	Proposed disposal methods/facilities for solid waste generated on-site: Construction: Via agreement with waste disposal company.	
	Via agreement with waste disposal company.	
	Operation: Via agreement with waste disposal company.	


s. Does the proposed action include construction or mod	ification of a solid waste mana	gement facility?	☐ Yes 🗹 No	
If Yes: i. Type of management or handling of waste proposed for the site (e.g., recycling or transfer station, composting, landfill, or				
other disposal activities):				
ii. Anticipated rate of disposal/processing:				
• Tons/month, if transfer or other non-		, or		
•Tons/hour, if combustion or thermal <i>iii</i> . If landfill, anticipated site life:				
iii. If landfill, anticipated site life:				
t. Will the proposed action at the site involve the comme waste?	rcial generation, treatment, sto	orage, or disposal of hazard	ous∐Yes No	
If Yes:				
i. Name(s) of all hazardous wastes or constituents to be	e generated, handled or manag	ed at facility:		
		-		
Conquelly describe magazasa on activities involving l	hazandana maataa an aanatitnar	ata.		
ii. Generally describe processes or activities involving l	nazardous wastes of constituer	its:		
-				
iii. Specify amount to be handled or generatedt	ons/month			
iv. Describe any proposals for on-site minimization, rec	cycling or reuse of hazardous of	constituents:		
v. Will any hazardous wastes be disposed at an existing	g offsite hazardous waste facil	itv?	□Yes□No	
707				
If No: describe proposed management of any hazardous	wastes which will not be sent	to a hazardous waste facilit	y:	
E. Site and Setting of Proposed Action				
E.1. Land uses on and surrounding the project site				
a. Existing land uses.				
i. Check all uses that occur on, adjoining and near the				
 □ Urban □ Industrial ☑ Commercial ☑ Residential (suburban) □ Rural (non-farm) □ Agriculture □ Aquatic ☑ Other (specify): Institutional (Sheridan Hill Elementary), Sheridan Driving Range 				
ii. If mix of uses, generally describe:	(specify). Institutional (Sherida)	Trilli Elementary), Shendan Di	iving range	
b. Land uses and covertypes on the project site.				
Land use or	Current	Acreage After	Change	
Covertype	Acreage	Project Completion	(Acres +/-)	
Roads, buildings, and other paved or impervious	0	3.58	+3.58	
surfaces				
• Forested	5.68	0.67	-5.01	
 Meadows, grasslands or brushlands (non- agricultural, including abandoned agricultural) 	0.40	0	-0.40	
Agricultural				
(includes active orchards, field, greenhouse etc.)	0	0	0	
Surface water features				
(lakes, ponds, streams, rivers, etc.)	0	0	0	
Wetlands (freshwater or tidal)	0	0	0	
Non-vegetated (bare rock, earth or fill)	0		0	
• Other				
Describe: lawn & landscaping	0	1.83	+1.83	
	-			

c. Is the project site presently used by members of the community for public recreation? i. If Yes: explain:	□Yes☑No
d. Are there any facilities serving children, the elderly, people with disabilities (e.g., schools, hospitals, licensed day care centers, or group homes) within 1500 feet of the project site? If Yes, i. Identify Facilities: Sheridan Hill Elementary School,	✓ Yes□No
e. Does the project site contain an existing dam?	☐ Yes ✓ No
If Yes:	1 03 1 100
i. Dimensions of the dam and impoundment:	
• Dam height: feet	
• Dam length: feet	
 Surface area: acres Volume impounded: gallons OR acre-feet 	
ii. Dam's existing hazard classification:	
iii. Provide date and summarize results of last inspection:	
<u> </u>	
f. Has the project site ever been used as a municipal, commercial or industrial solid waste management facility, or does the project site adjoin property which is now, or was at one time, used as a solid waste management facility Yes:	□Yes ☑ No lity?
i. Has the facility been formally closed?	☐Yes☐ No
• If yes, cite sources/documentation:	
<i>ii.</i> Describe the location of the project site relative to the boundaries of the solid waste management facility:	
Describe and describe and describe and the describe and a second describe and descr	
iii. Describe any development constraints due to the prior solid waste activities:	
The standard control of the standard forms of the standard for the standard forms of the	□Yes ✓ No
g. Have hazardous wastes been generated, treated and/or disposed of at the site, or does the project site adjoin property which is now or was at one time used to commercially treat, store and/or dispose of hazardous waste?	∐ Y es v No
If Yes:	
i. Describe waste(s) handled and waste management activities, including approximate time when activities occurre	ed:
h. Potential contamination history. Has there been a reported spill at the proposed project site, or have any	☐Yes Z No
remedial actions been conducted at or adjacent to the proposed site? If Yes:	
<i>i.</i> Is any portion of the site listed on the NYSDEC Spills Incidents database or Environmental Site	□Yes□No
Remediation database? Check all that apply:	
Yes – Spills Incidents database Provide DEC ID number(s): Provide DEC ID number(s):	
Yes – Environmental Site Remediation database Provide DEC 1D number(s):	
☐ Neither database	
ii. If site has been subject of RCRA corrective activities, describe control measures:	
iii. Is the project within 2000 feet of any site in the NYSDEC Environmental Site Remediation database?	□Yes•No
If yes, provide DEC ID number(s):	
iv. If yes to (i), (ii) or (iii) above, describe current status of site(s):	

v. Is the project site subject to an institutional control	* · · ·	□Yes•No
If yes, DEC site ID number:		
Describe the type of institutional control (e.g.	g., deed restriction or easement):	
Describe any use limitations: Describe any engineering controls:		
 Will the project affect the institutional or engineering 	gineering controls in place?	□Yes□No
• Explain:		
E.2. Natural Resources On or Near Project Site		
a. What is the average depth to bedrock on the project	site? 2.5 - 5 feet	
b. Are there bedrock outcroppings on the project site?		☐ Yes Z No
If Yes, what proportion of the site is comprised of bed	drock outcroppings?%	
c. Predominant soil type(s) present on project site:	Benson very channery loam 48 %	
	Wassaic silt loam 29 %	
	Newstead loam 23 %	o de la companya de l
d. What is the average depth to the water table on the	project site? Average: 5 feet	
e. Drainage status of project site soils: ✓ Well Draine	d: 77 % of site	
	Well Drained: % of site	
	ned 23 % of site	
f. Approximate proportion of proposed action site with	h slopes: 2 0-10%:	
	☐ 10-15%:% of site ☐ 15% or greater:% of site	
g. Are there any unique geologic features on the proje If Yes, describe:		□Yes ✓ No
ii i es, describe.		
		_
h. Surface water features.i. Does any portion of the project site contain wetlan.	ds or other waterbodies (including streams, rivers,	✓Yes□No
ponds or lakes)?		
ii. Do any wetlands or other waterbodies adjoin the process of the	roject site?	Z Yes□No
If Yes to either <i>i</i> or <i>ii</i> , continue. If No, skip to E.2.i.		
<i>iii.</i> Are any of the wetlands or waterbodies within or a state or local agency?	adjoining the project site regulated by any federal,	Z Yes □No
· •	dy on the project site, provide the following information:	
• Streams: Name	Classification	
• Lakes or Ponds: Name	Classification Approximate Size	
• Wetlands: Name Federal Waters	Approximate Size	
• Wetland No. (if regulated by DEC)		
v. Are any of the above water bodies listed in the mos waterbodies?	st recent compilation of NYS water quality-impaired	☐Yes Z No
	for listing as impaired:	
if yes, name of impaned water body/bodies and basis	ioi iisting as impaned.	
i. Is the project site in a designated Floodway?		□Yes ☑ No
j. Is the project site in the 100-year Floodplain?		□Yes Z No
k. Is the project site in the 500-year Floodplain?		□Yes ☑ No
1. Is the project site located over, or immediately adjoin	ning, a primary, principal or sole source aquifer?	□Yes ☑ No
If Yes:	-	
i. Name of aquifer:		

T1 (10 d 1			. •.		
	ninant wildlife species tha			an dural	
White tailed deer		ccoon		squirrel	
eastern chipmunk	s	kunk		woodchuck	
field mice		ommon garter snake		red fox	
If Yes:	e contain a designated sign at/community (compositio	·			Z Yes □No
ii. Source(s) of descri	ption or evaluation:				
<i>iii</i> . Extent of commun	itv/habitat:				
• Currently:	105, 1140 1440		70.0 acres		
	mpletion of project as proj	nosed:			
_	indicate + or -):	· · · · · · · · · · · · · · · · · · ·			
• Gain of 1088 (marcate + or -).		acres		
If Yes:	ened, or does it contain are	y areas racinimea as naoi	_	-	
special concern? If Yes:	e contain any species of p		•	or as a species of	□Yes ☑ No
	adjoining area currently u				∐Yes ✓No
E.3. Designated Pub	lic Resources On or Near	· Project Site			
Agriculture and Ma	any portion of it, located orkets Law, Article 25-AA or plus district name/number	, Section 303 and 304?	al district certified	pursuant to	∐Yes ☑ No
i. If Yes: acreage(s)	ds consisting of highly pro on project site?ating(s):				∐Yes ✓ No
Natural Landmark? If Yes: i. Nature of the nature.	e contain all or part of, or ral landmark:	ological Community	☐ Geological I	Feature	∐Yes Z No
If Yes:i. CEA name:ii. Basis for designat	cated in or does it adjoin a ion: cy and date:				□Yes ☑ No

e. Does the project site contain, or is it substantially contiguous to, a building, archaeological site, or district which is listed on the National or State Register of Historic Places, or that has been determined by the Commission Office of Parks, Recreation and Historic Preservation to be eligible for listing on the State Register of Historic Platif Yes: i. Nature of historic/archaeological resource: Archaeological Site Historic Building or District ii. Name: iii. Brief description of attributes on which listing is based:	
f. Is the project site, or any portion of it, located in or adjacent to an area designated as sensitive for archaeological sites on the NY State Historic Preservation Office (SHPO) archaeological site inventory?	✓ Yes □No
g. Have additional archaeological or historic site(s) or resources been identified on the project site? If Yes: i. Describe possible resource(s): ii. Basis for identification:	□Yes ☑ No
h. Is the project site within fives miles of any officially designated and publicly accessible federal, state, or local scenic or aesthetic resource? If Yes: i. Identify resource:	□Yes Z No
ii. Nature of, or basis for, designation (e.g., established highway overlook, state or local park, state historic trail or	scenic byway,
iii. Distance between project and resource: miles.	
etc.): miles. iii. Distance between project and resource: miles. i. Is the project site located within a designated river corridor under the Wild, Scenic and Recreational Rivers Program 6 NYCRR 666? If Yes: i. Identify the name of the river and its designation:	☐ Yes No
i. Identify the name of the river and its designation:	∐Yes∏No
F. Additional Information Attach any additional information which may be needed to clarify your project. If you have identified any adverse impacts which could be associated with your proposal, please describe those immeasures which you propose to avoid or minimize them.	npacts plus any
G. Verification I certify that the information provided is true to the best of my knowledge.	
Applicant/Sponsor Name Jason Utzig(C&S Engineers) on behalf of owner Date August 5, 2024	
Signature Title Senior Project Engineer	

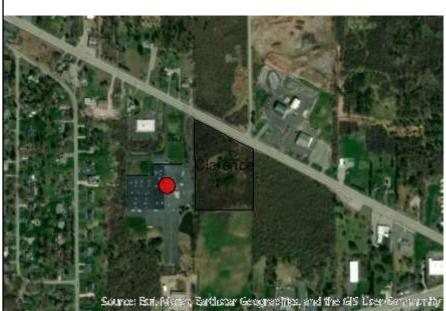


Disclaimer: The EAF Mapper is a screening tool intended to assist project sponsors and reviewing agencies in preparing an environmental assessment form (EAF). Not all questions asked in the EAF are answered by the EAF Mapper. Additional information on any EAF question can be obtained by consulting the EAF Workbooks. Although the EAF Mapper provides the most up-to-date digital data available to DEC, you may also need to contact local or other data sources in order to obtain data not provided by the Mapper. Digital data is not a substitute for agency determinations.




B.i.i [Coastal or Waterfront Area]	No
B.i.ii [Local Waterfront Revitalization Area]	No
C.2.b. [Special Planning District]	Yes - Digital mapping data are not available for all Special Planning Districts. Refer to EAF Workbook.
C.2.b. [Special Planning District - Name]	NYS Heritage Areas:West Erie Canal Corridor
E.1.h [DEC Spills or Remediation Site - Potential Contamination History]	Digital mapping data are not available or are incomplete. Refer to EAF Workbook.
E.1.h.i [DEC Spills or Remediation Site - Listed]	Digital mapping data are not available or are incomplete. Refer to EAF Workbook.
E.1.h.i [DEC Spills or Remediation Site - Environmental Site Remediation Database]	Digital mapping data are not available or are incomplete. Refer to EAF Workbook.
E.1.h.iii [Within 2,000' of DEC Remediation Site]	No
E.2.g [Unique Geologic Features]	No
E.2.h.i [Surface Water Features]	Yes
E.2.h.ii [Surface Water Features]	Yes
E.2.h.iii [Surface Water Features]	Yes - Digital mapping information on local and federal wetlands and waterbodies is known to be incomplete. Refer to EAF Workbook.
E.2.h.iv [Surface Water Features - Wetlands Name]	Federal Waters
E.2.h.v [Impaired Water Bodies]	No
E.2.i. [Floodway]	No
E.2.j. [100 Year Floodplain]	No
E.2.k. [500 Year Floodplain]	No
E.2.I. [Aquifers]	No
E.2.n. [Natural Communities]	Yes


E.2.n.i [Natural Communities - Name]	Oak Openings
E.2.n.i [Natural Communities - Acres]	70.0
E.2.o. [Endangered or Threatened Species]	No
E.2.p. [Rare Plants or Animals]	No
E.3.a. [Agricultural District]	No
E.3.c. [National Natural Landmark]	No
E.3.d [Critical Environmental Area]	No
E.3.e. [National or State Register of Historic Places or State Eligible Sites]	Digital mapping data are not available or are incomplete. Refer to EAF Workbook.
E.3.f. [Archeological Sites]	Yes
E.3.i. [Designated River Corridor]	No

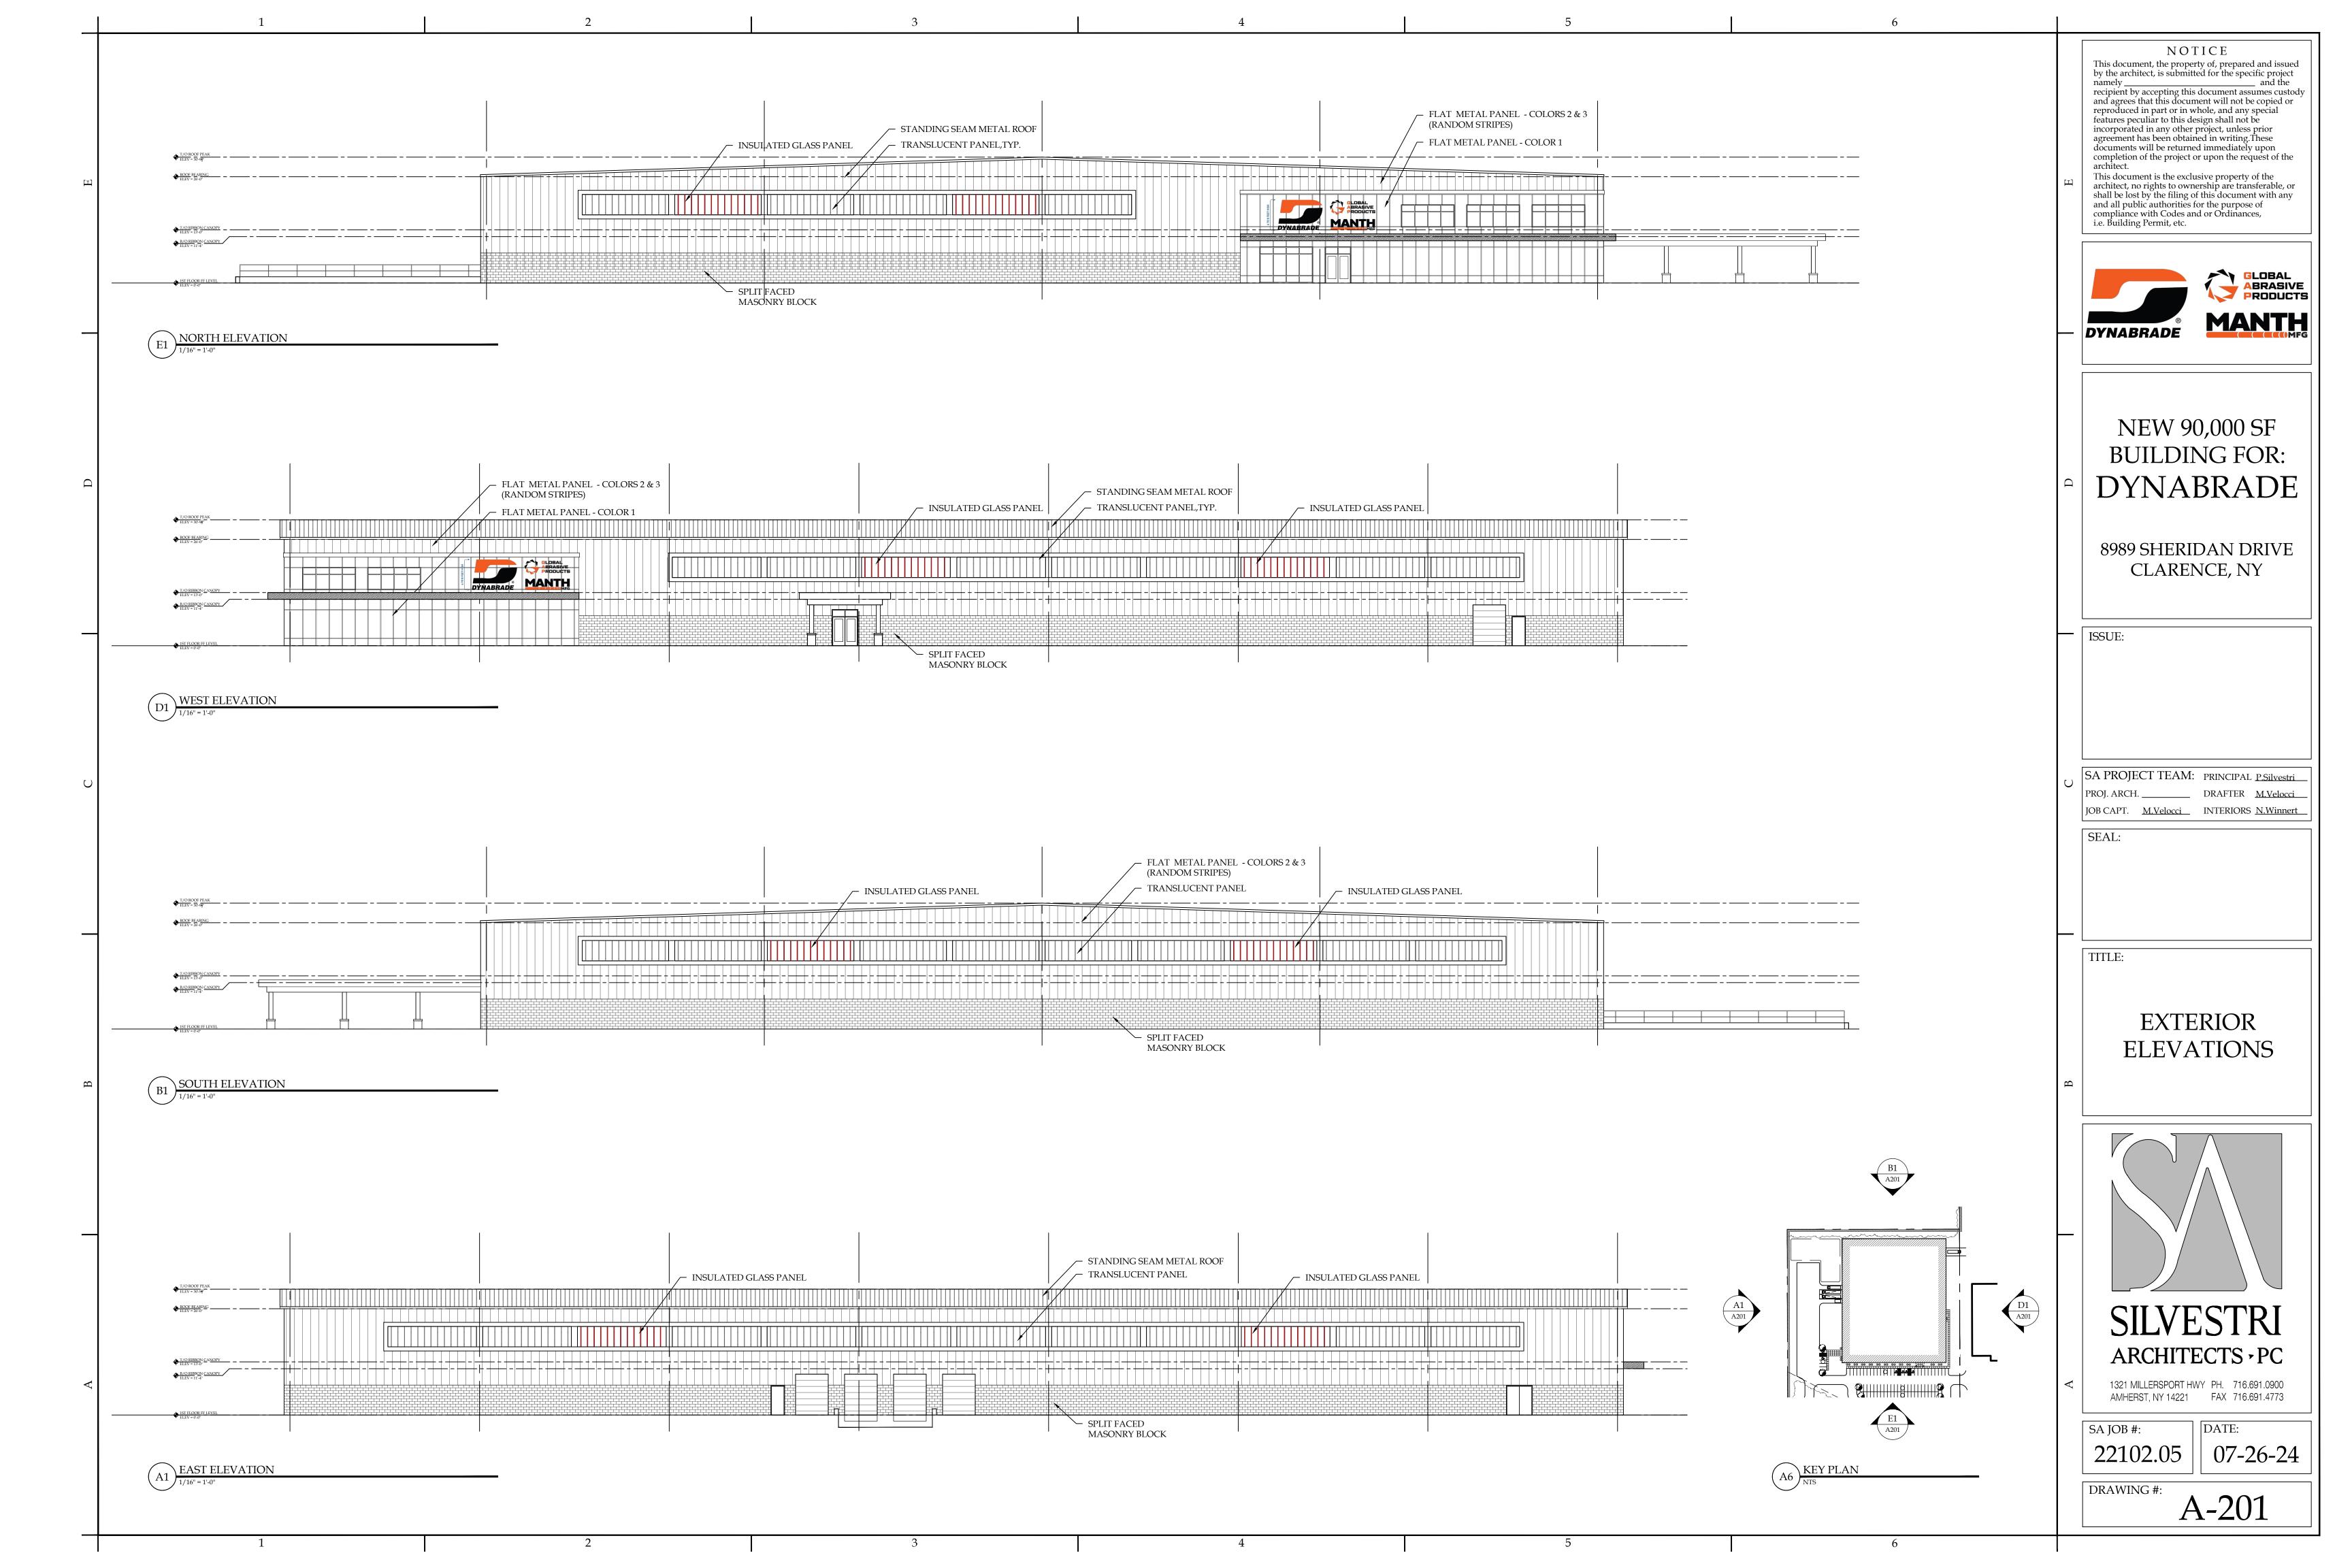







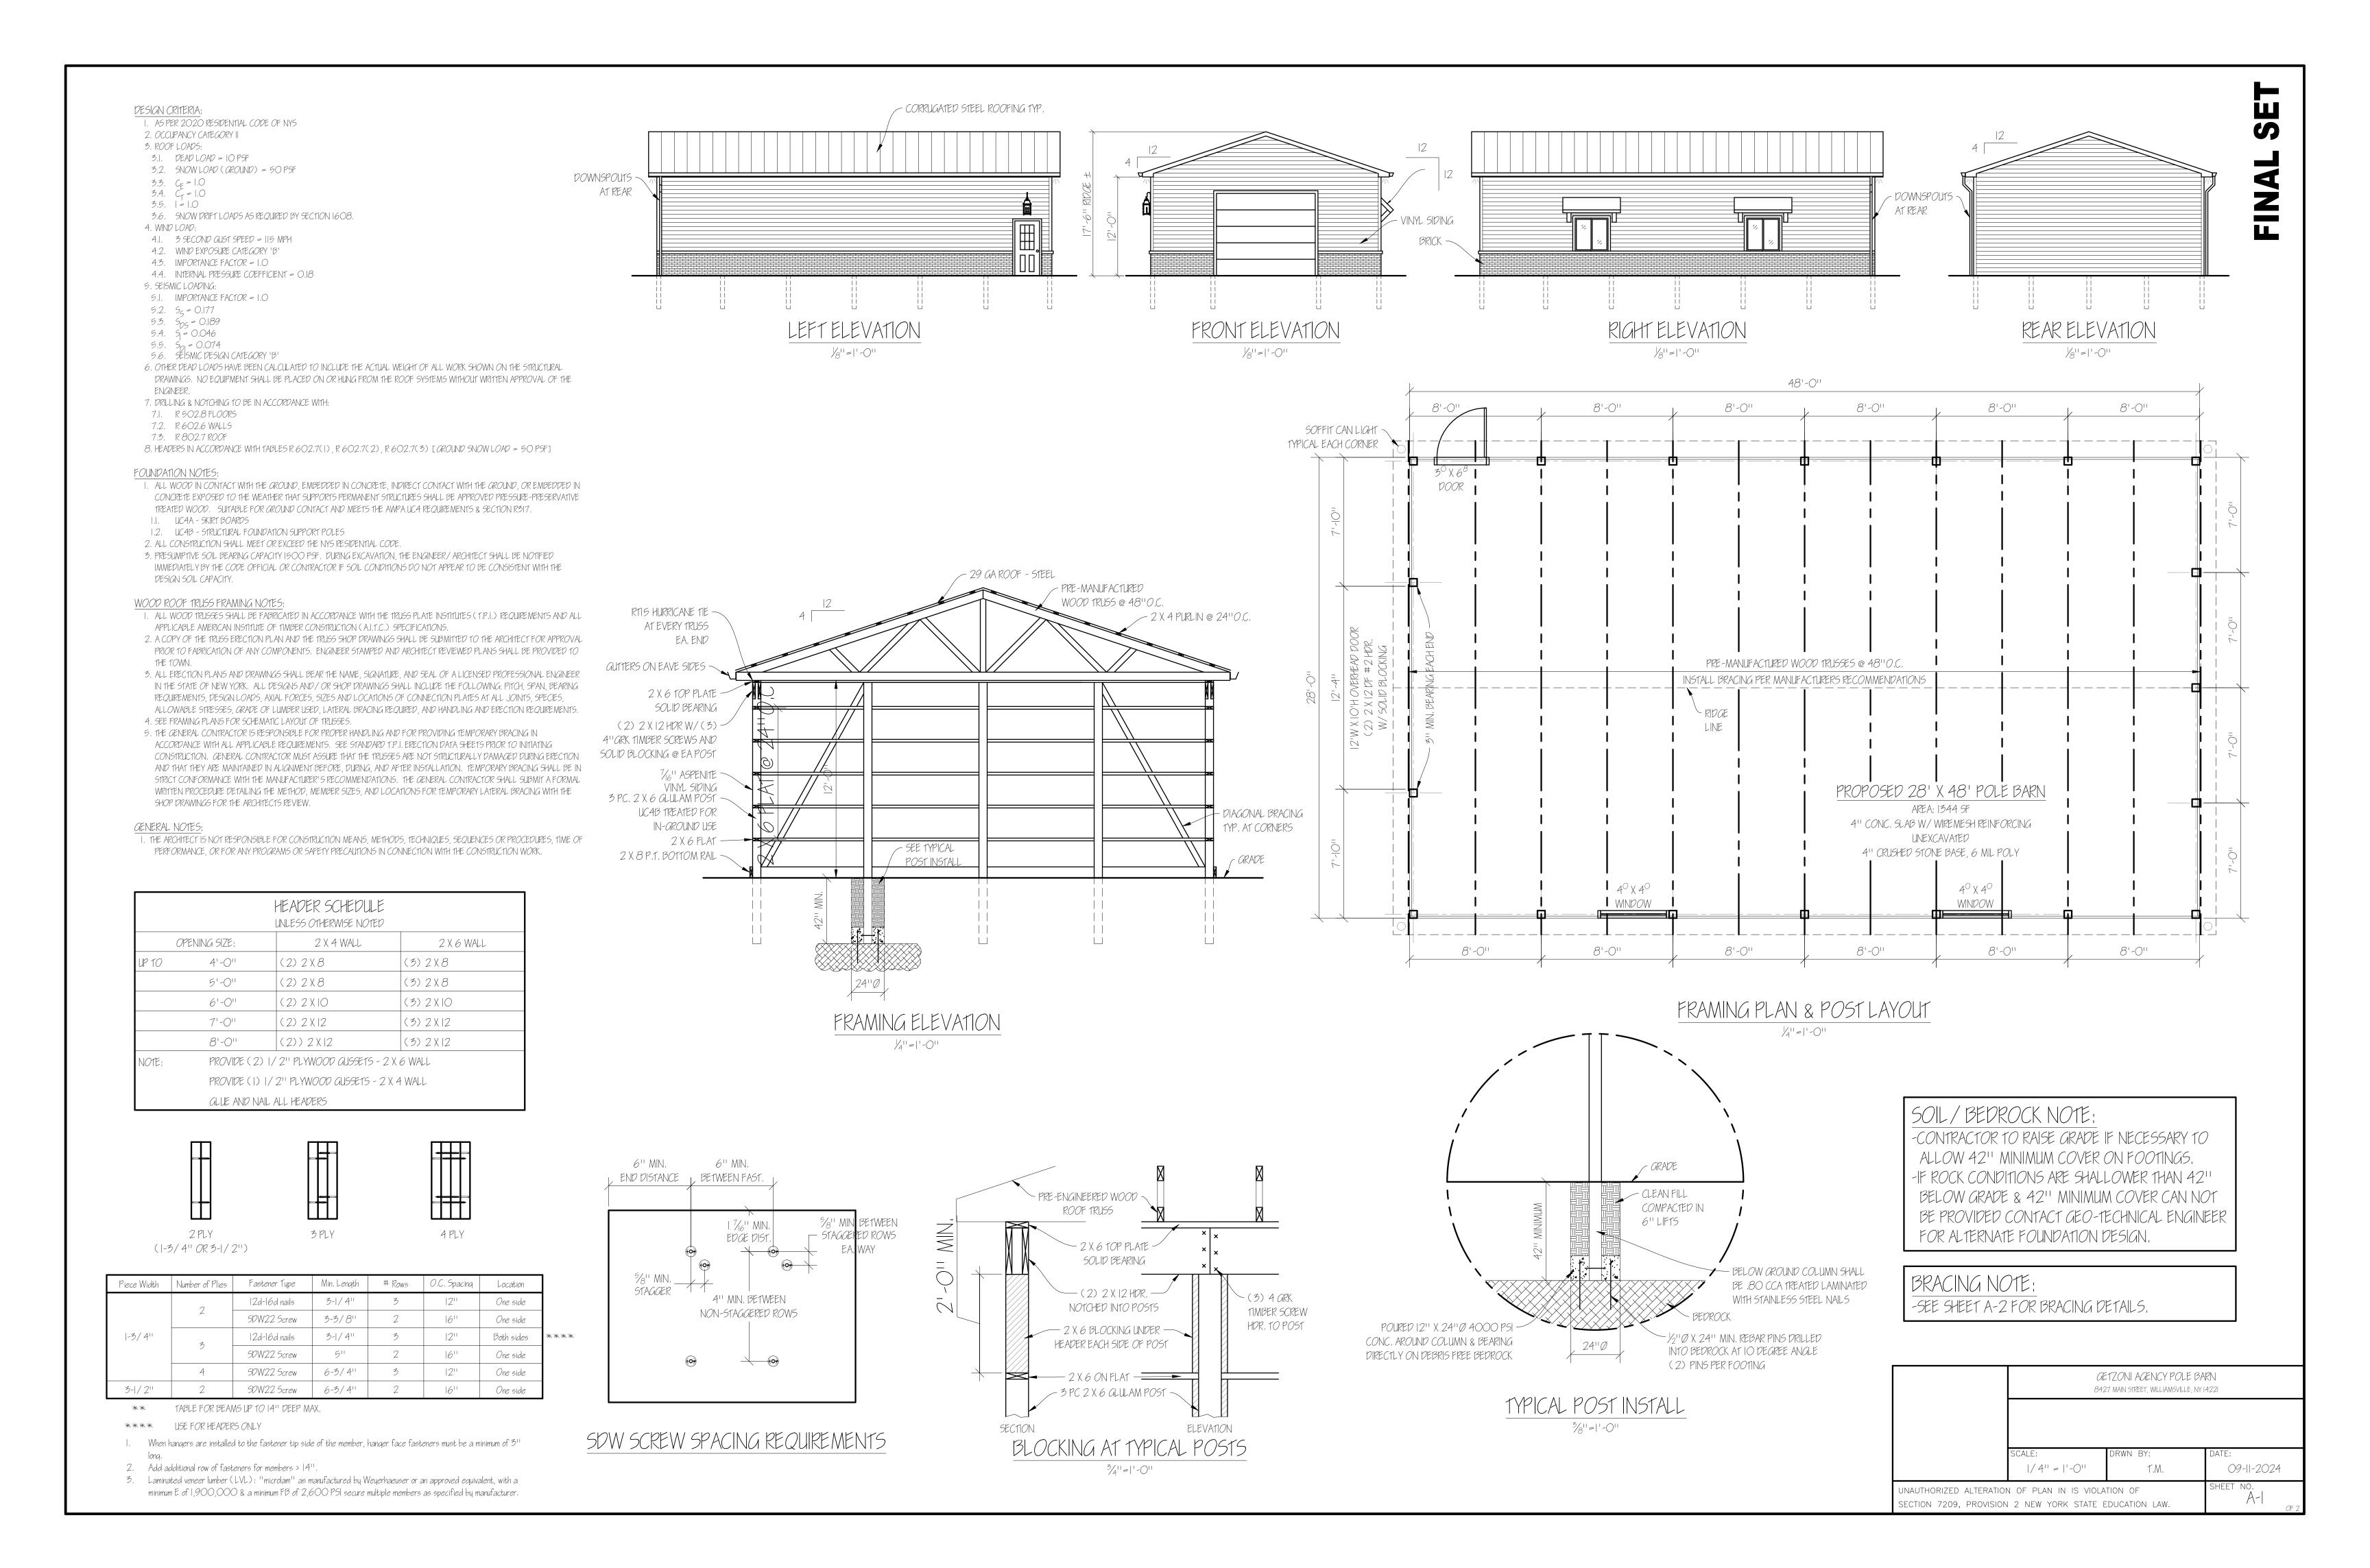

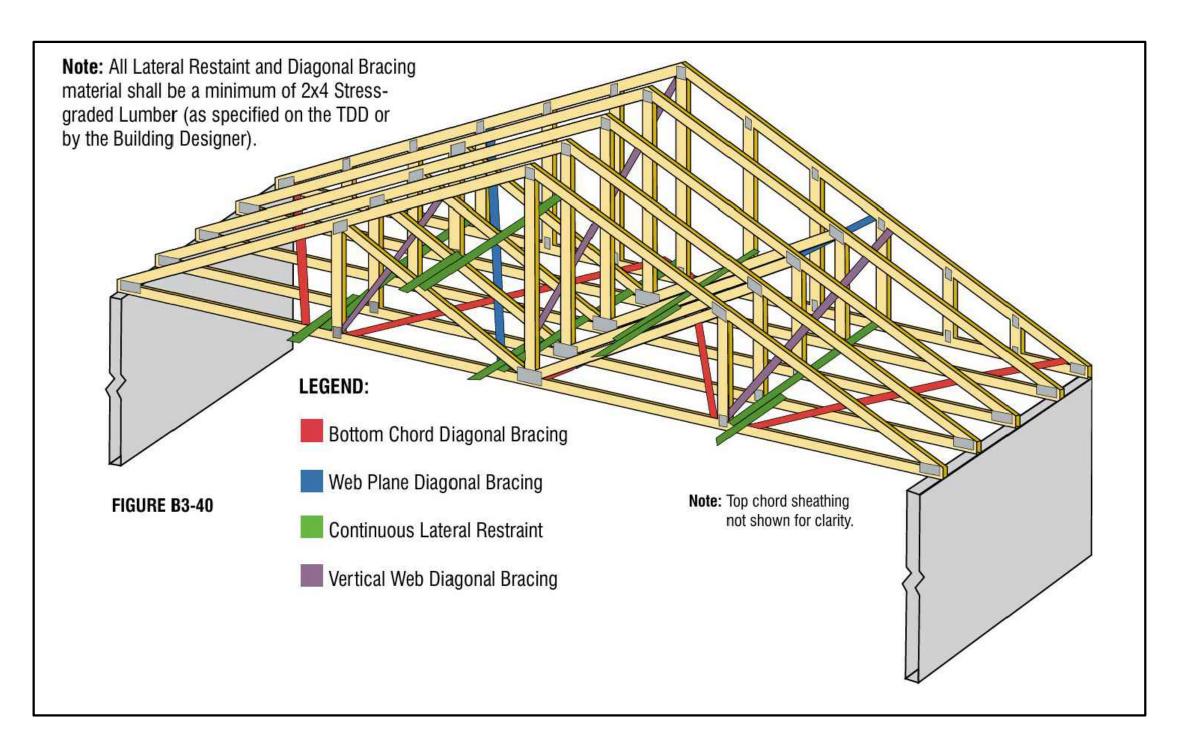

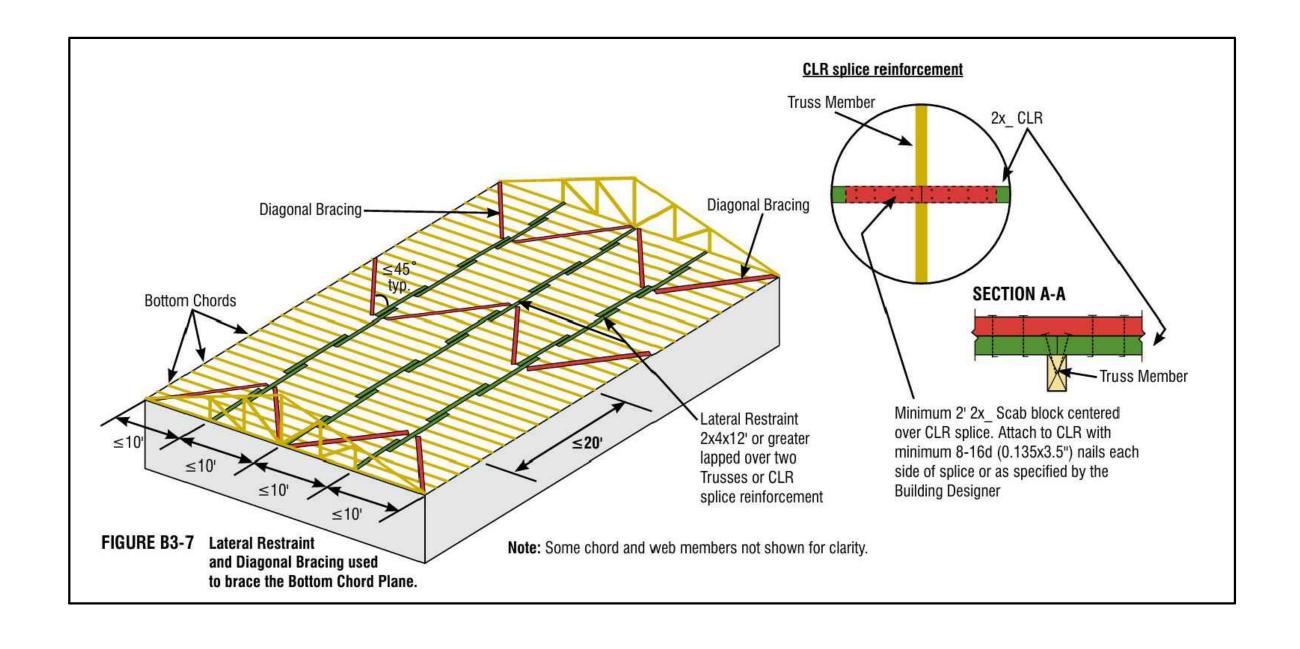

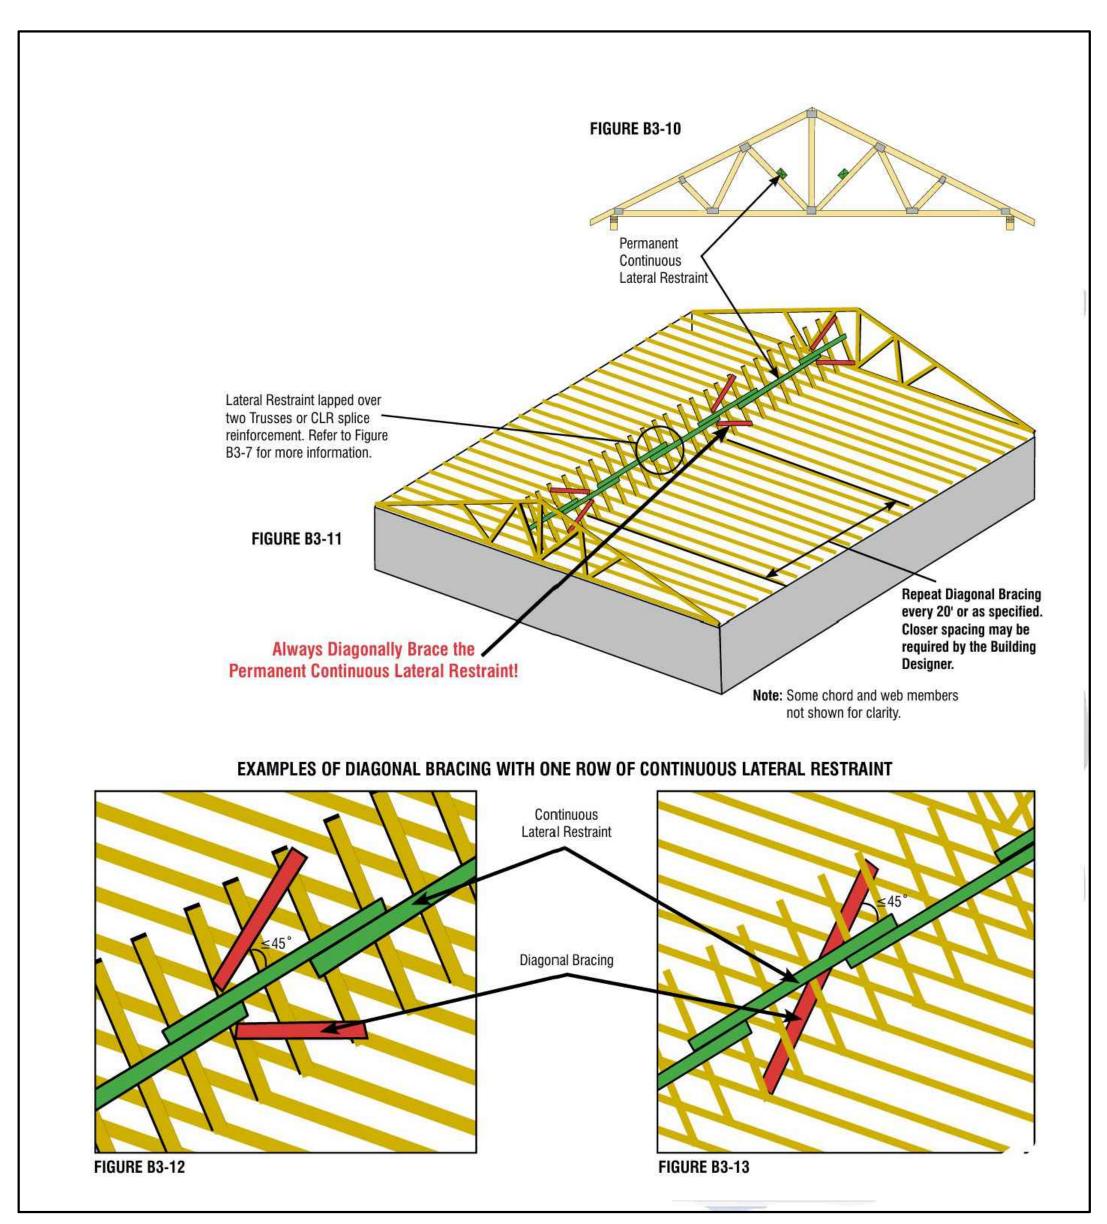

Note: Top Chord sheathing not shown for clarity. FIGURE B3-34 Diagonal Brace to roof Diaphragm Blocking Roof Diaphragm Blocking Bottom Chord Permanent Continuous Lateral Restraint Gable end wall permanent Diagonal Bracing. Locate in line with Bottom Chord permanent CLR or as specified in the Construction Documents (see Figure B3-40, page 50). FIGURE B3-35

BRACING NOTES:

I. TEMPORARY BRACING OF TRUSS IS CONSIDERED WAYS & MEANS AND WILL BE CONTRACTORS RESPONSIBILITY.

	GETZONI AGENCY POLE BARN 8427 MAIN STREET, WILLIAMSVILLE, NY 14221					
SCALE: $ /4 ' = '-0 '$	DRWN BY: 1.M.	DATE: 05-06-2024				
ATION OF PLAN IN IS VIOL SION 2 NEW YORK STATE		SHEET NO. A-2				

The Getzoni Agency, Inc. 8427 Main Street Williamsville, NY 14221 Tel: (716) 631-0363

Town of Clarence 6221 Goodrich Road Clarence Center, NY 14032

RE: Intended Use of Accessory Building

August 22, 2024

To Whom It May Concern,

I am writing to formally document our intent to utilize the proposed accessory building at 8427 Main Street for the purpose of cold storage of office and property maintenance equipment.

This facility has been specifically designed to accommodate our storage needs, ensuring that our equipment is kept in an optimal environment that preserves its functionality and value. By centralizing these assets in this dedicated space, we aim to enhance our operational efficiency and streamline our maintenance processes.

We intend to use the building exclusively for the storage of items related to our office operations and property maintenance. This will include, but is not limited to, office furniture, tools, machinery, and other essential equipment necessary for the upkeep of our property and the smooth functioning of our office operations.

We believe that this dedicated storage solution will contribute significantly to our overall operational effectiveness and asset management strategy.

Should you require any additional information or have any concerns, feel free to reach out to me directly. Thank you for your attention to this matter.

Sincerely,

Grant L. Getzoni President/Owner

The Getzoni Agency, Inc. 8427 Main Street Williamsville, NY 14221 Tel: (716) 631-0363

Town of Clarence 6221 Goodrich Road Clarence Center, NY 14032

RE: Intent to Re-Tree Clarence with Building Construction

August 22, 2024

To Whom It May Concern.

I am writing to formally express our intent to re-tree Clarence during the final grading process after the construction of our accessory building. We recognize the importance of maintaining and enhancing the environmental quality of the area and are committed to restoring the green space in Clarence with appropriate tree species once the grading is finished.

Our plan involves working closely with environmental experts to ensure that the re-treeing process is conducted effectively and in accordance with local regulations and best practices. The selected tree species will be chosen to align with the area's ecosystem, promote biodiversity, and contribute positively to the local environment. Please find attached the proposal for the project.

We understand that re-treeing is a critical step in restoring the landscape and are fully dedicated to following through with this commitment. Thank you for your attention to this matter. Please feel free to contact me with any questions or if further information is required.

Sincerely,

Grant L Getzoni President/Owner



Estimate for Installation of Chestnut Trees and Yard Grading

Date: August 22, 2024

THE GETZONI AGENCY

8427 MAIN ST

WILLIAMSVILLE NY 14221

Scope of Work:

Installation of 2 Chestnut Trees

Grading and Reseeding of Yard

Cost Breakdown:

Chestnut Trees:

Cost of Chestnut Trees: 2 trees x \$249 = \$498

Installation Fee: 2 trees x \$100 = \$200

Total for Chestnut Trees: \$498 + \$200 = \$698

Grading and Reseeding of Yard:

Grading and Reseeding: \$2600

Total Estimated Cost:

Chestnut Trees Installation: \$698

Grading and Reseeding of Yard: \$2600

Grand Total: \$3298

Terms and Conditions:Payment Terms: [Specify payment terms, e.g., 50% deposit upon acceptance of estimate, balance due upon completion]

Validity: This estimate is valid for 30 days from the date of issuance.

Scope Limitation: This estimate covers only the items specified above. Any additional work required will be subject to further discussion and agreement. Note: Prices are based on current rates and may be subject to adjustment based on unforeseen circumstances or additional client requirements.

Please do not hesitate to contact us if you have any questions or require further clarification. We look forward to the opportunity to work with you.

Sincerely,

PAUL GUSTAS

510 AURORA ST

LANCASTER NY 14086

0740-71 '97 90P "1-81-8 : HEU KANNS 20916 : 1 "= 40 " Phone: (716) 837-5082 TOWN OF CISTENCE POINTY OF ENE, MEW YORK POINT OF CISTENCE POWN OF CISTENCE Amherst, N.Y. 14226 189 Lamont Drive N.Y.S. License No. 050151 Licensed Land Surveyor CParallel with Kenneth M. Hahn 3,40° 34,5° 3002/ -0'08-1,100 3,1'50. 0,8'W. 2,1'No. 7,1'No. W. Line of Lot 6 2011-00 ,844 ,45% 10 30, LINE 02 7.32 MAIN 52.7 - 2 707 fo -0'08 - 540,22 'to W. LINE 301M,066 NIHW

Altering any item on this map is in violation of the law, excepting as provided in Section 7279, part 2 of the New York State Education Law

This survey was prepared without the benefit of an abstract of title and is subject to any state of facts that may be revealed by an examination of survh

BARCLAY DAMON^{LIP}

Ari M. Goldberg Counsel

July 10, 2024

VIA OVERNIGHT MAIL VIA ELECTRONIC MAIL

Town of Clarence
Planning Board
c/o Jonathan Bleuer, Director of Community Development
One Town Place
Clarence, NY 14031
jbleuer@clarence.ny.us

Re: <u>James Ryan Parkway & County Road</u>

Mattina Development LLC

Third Supplemental Submission | Subdivision

Dear Members of the Planning Board:

Barclay Damon LLP represents Mattina Development, LLC ("Applicant") with respect to its proposed retail plaza ("Development") at the southeast corner of County Road and James Ryan Parkway, SBL 44.00-1-21.121 ("Property"). In follow up to our most recent appearance before the Planning Board Executive Committee meeting on July 1, 2024, Applicant hereby amends its request for action to include subdivisions associated with the Development.

Enclosed, please find the following:

- 1. Cimato Family Business Park Subdivision Plat and Drawing Set
- 2. Revised Site Plan Set prepared by Carmina Wood Design

Applicant is purchasing Lots 1, 2, 9, 10, 11, and the Stormwater Detention Basin Lot shown in the Subdivision Plat enclosed. The Applicant's subdivision request includes:

- Subdivision of Lots 1 and 2 from the Property and merger of Lots 1 and 2 to form a separate, standalone parcel.
- Subdividing Lot 9 from the Property to form a standalone parcel.
- Subdivision of Lots 10, 11, and the Stormwater Detention Basin Lot from the Property and merger of the same to form a separate, standalone parcel containing the Development.

Mattina | James Ryan Parkway & County – Revised Concept Plan July 10, 2024 Page 2

We look forward to discussing the Development with the Planning Board at its July 31, 2024 meeting. If anything additional is required, please do not hesitate to reach out. Thank you for your consideration.

Very truly yours,

Ari M. Goldberg

cc: Chris Wood, Carmina Wood Design Mattina Development, LLC

Exhibit 1


Property Subdivision Plat and Drawing Set

CIMATO FAMILY BUSINESS PARK

(FORMERLY LAKESIDE INDUSTRIAL PARK) PART OF LOT 1, TOWNSHIP 12, SECTION 12, RANGE 6 TOWN OF CLARENCE - ERIE COUNTY - NEW YORK

GENERAL NOTES

- 1. ALL SANITARY SEWER CONSTRUCTION SHALL BE IN ACCORDANCE WITH CLARENCE SEWER DISTRICT NO. 2 AND ERIE COUNTY SEWER DISTRICT NO. 5 RULES, REGULATIONS AND STANDARD DETAILS. THE TOWN OF CLARENCE WILL ARRANGE AND HOLD A PRE-CONSTRUCTION MEETING PRIOR TO THE START OF CONSTRUCTION.
- 2. ALL CONSTRUCTION SHALL BE IN ACCORDANCE WITH TOWN OF CLARENCE STANDARD CONSTRUCTION SPECIFICATIONS AND/OR SUBJECT TO THE LATEST REVISIONS APPROVED BY THE TOWN ENGINEER. THE CONTRACTOR IS REQUIRED TO SUBMIT SHOP DRAWINGS TO THE TOWN OF CLARENCE TOWN ENGINEER PRIOR TO THE START OF CONSTRUCTION.
- 3. ALL WATER MAIN CONSTRUCTION SHALL BE IN ACCORDANCE WITH ERIE COUNTY WATER AUTHORITY STANDARD SPECIFICATIONS AND DETAILS. THE CONTRACTOR IS REQUIRED TO ADHERE TO ALL REQUIREMENTS OF RESPECTIVE ECWA BUILDER-CONTRACTOR-DEVELOPER (BCD) AGREEMENT INCLUDING SUBMIT SHOP DRAWINGS TO THE ERIE COUNTY WATER AUTHORITY PRIOR TO THE START OF CONSTRUCTION
- 4. ALL WORK WITHIN ROW OF COUNTY ROAD (CR #282) IS SUBJECT TO A WORK PERMIT TO BE ISSUED BY ECDPW DIVISION OF HIGHWAYS TO THE CONTRACTOR.
- 5. ALL WORK IN THE VICINITY OF NATIONAL FUEL GAS PROPERTY/FACILITIES IS SUBJECT TO PROVISIONS OF RESPECTIVE NFG LICENSE AGREEMENT
- 6. THE LOCATION OF UTILITIES AND OTHER FEATURES, AS SHOWN ON THE PLANS, ARE FROM THE BEST INFORMATION AVAILABLE, IT IS THE CONTRACTOR'S RESPONSIBILITY TO FIELD INVESTIGATE AND DETERMINE THE EXACT LOCATIONS OF UTILITIES PRIOR TO CONSTRUCTION IN ORDER TO AVOID CONFLICTS. IT IS THE CONTRACTOR'S RESPONSIBILITY TO LOCATE, PROTECT, SUPPORT AND MAINTAIN ALL EXISTING UTILITIES DURING THE COURSE OF HIS OPERATIONS. DAMAGE TO EXISTING UTILITIES SHALL BE REPAIRED AT THE CONTRACTOR'S EXPENSE.
- 7. ALL PROVISIONS OF THE NEW YORK STATE INDUSTRIAL CODE RULE 53 AND THE NEW YORK STATE VOLTAGE PROXIMITY ACT MUST BE FOLLOWED. THE CONTRACTOR SHALL BE RESPONSIBLE TO ADVISE ALL UTILITIES AND AGENCIES OF HIS PROPOSED OPERATIONS.
- 8. ANY DAMAGE CAUSED BY THE CONTRACTOR'S OPERATIONS TO EXISTING PAVEMENT, SHOULDERS, DRIVES AND STORM DRAINAGE FACILITIES SHALL BE REPAIRED OR REPLACED IN KIND BY THE CONTRACTOR AT HIS EXPENSE. ALL REPAIRS OR REPLACEMENTS MADE BY THE CONTRACTOR SHALL BE ACCEPTABLE TO THE OWNER OR AGENCY HAVING JURISDICTION.
- 9. THE CONTRACTOR SHALL TAKE ANY PRECAUTIONS NECESSARY TO PROTECT TREES AND SHRUBBERY FROM DAMAGE, UNLESS SPECIFICALLY ORDERED FOR CLEARING.
- 10. THE CONTRACTOR SHALL BE AWARE THAT SOIL CONDITIONS ARE UNKNOWN AND ASSUMED TO VARY AT DIFFERENT DEPTHS AND LOCATIONS.
- 11. ALL UTILITY OPEN CUT ROAD CROSSINGS SHALL BE BACKFILLED WITH NO. 2 RUN OF CRUSHER STONE AND COMPACTED TO A MINIMUM OF 95% MAXIMUM DENSITY ASTM D-1557 PER TRENCH DETAILS. SELECT BACKFILL MATERIAL SHALL EXTEND A MINIMUM OF 5-FEET BEYOND EDGE OF PAVEMENT.
- 12. CONTRACTOR SHALL COMPLY WITH ALL APPLICABLE FEDERAL, STATE AND LOCAL STATUTES REGARDING THE PREVENTION AND ABATEMENT OF SOIL EROSION, SEDIMENTATION AND WATER POLLUTION.
- 13. THE PLANS AND SPECIFICATIONS FOR THIS PROJECT HAVE BEEN PREPARED WITH CARE AND ARE INTENDED TO SHOW AS CLEARLY AS IS PRACTICABLE THE WORK REQUIRED TO BE DONE. THE CONTRACTOR MUST REALIZE, HOWEVER, THAT CONSTRUCTION DETAILS CAN NOT ALWAYS BE ACCURATELY ANTICIPATED AND THAT IN EXECUTING THE WORK, FIELD CONDITIONS MAY REQUIRE REASONABLE MODIFICATIONS IN THE DETAILS OF PLANS AND QUANTITIES OF WORK INVOLVED. ALL WORK MUST BE CARRIED OUT TO MEET ACTUAL FIELD CONDITIONS TO THE SATISFACTION OF THE TOWN ENGINEER AND OWNER IN ACCORDANCE WITH THEIR INSTRUCTIONS.

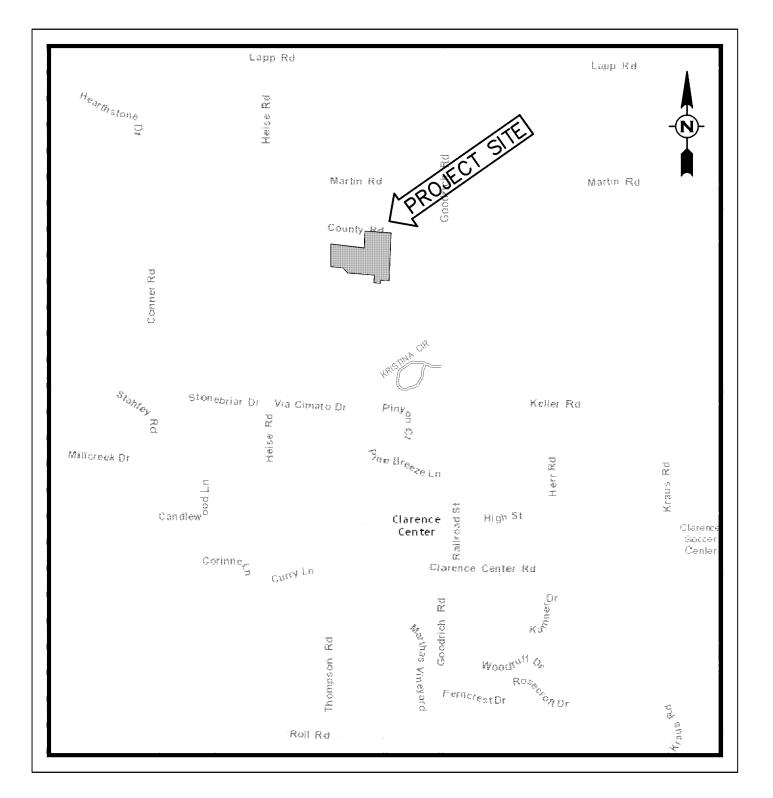

LOCATION MAP

SHEET INDEX

BOUNDARY AND TOPOGRAPHIC SURVEY SITE LAYOUT PLAN FORCEMAIN PLAN AND PROFILE . ECWA WATER MAIN DETAILS SANITARY SEWER NOTES SANITARY SEWER DETAILS . SANITARY SEWER AND PUMP STATION/FORCEMAIN DETAILS . PAVING AND DRAINAGE PLAN PD2. .. PAVING AND DRAINAGE PROFILES . RETENTION POND SECTIONS PD4. .. PAVING AND DRAINAGE DETAILS .. PAVING AND DRAINAGE DETAILS . GRADING PLAN . STORMWATER POLLUTION PREVENTION PLAN . STORMWATER POLLUTION PREVENTION DETAILS


WM SCHUTT ASSOCIATES

37 CENTRAL AVE.
LANCASTER, NY 14086-2143
PH. 716-683-5961
FAX 716-683-0169
WWW.WMSCHUTT.COM

OWNER/DEVELOPER:

CIMATO & SONS, INC. 9220 TRANSIT ROAD EAST AMHERST, NEW YORK 14051

_____ DATE:___

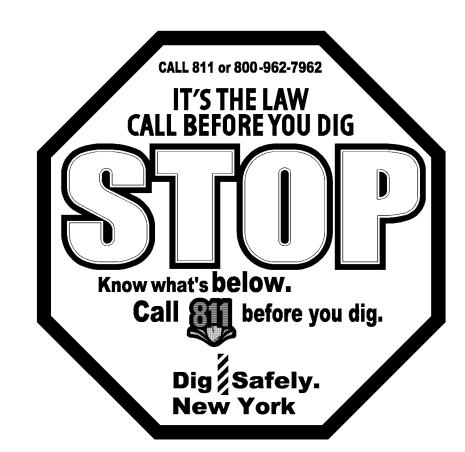

THIS SHEET ISSUED FEBRUARY 25, 2016


CVR


WSA PROJECT NO. 05008D

ITEM DATE DESCRIPTION

DRAWING REVISIONS

WM. SCHUTT AND ASSOCIATES, P.C. (THE "CONSULTANTS") REPRESENTS AND CERTIFIES THAT, IN THE CONSULTANT'S PROFESSIONAL OPINION, THE ATTACHED PLANS COMPLY WITH THE AMERICANS WITH DISABILITIES ACT AND WITH ALL APPLICABLE STATE AND LOCAL ACCESSIBILITY REQUIREMENTS.

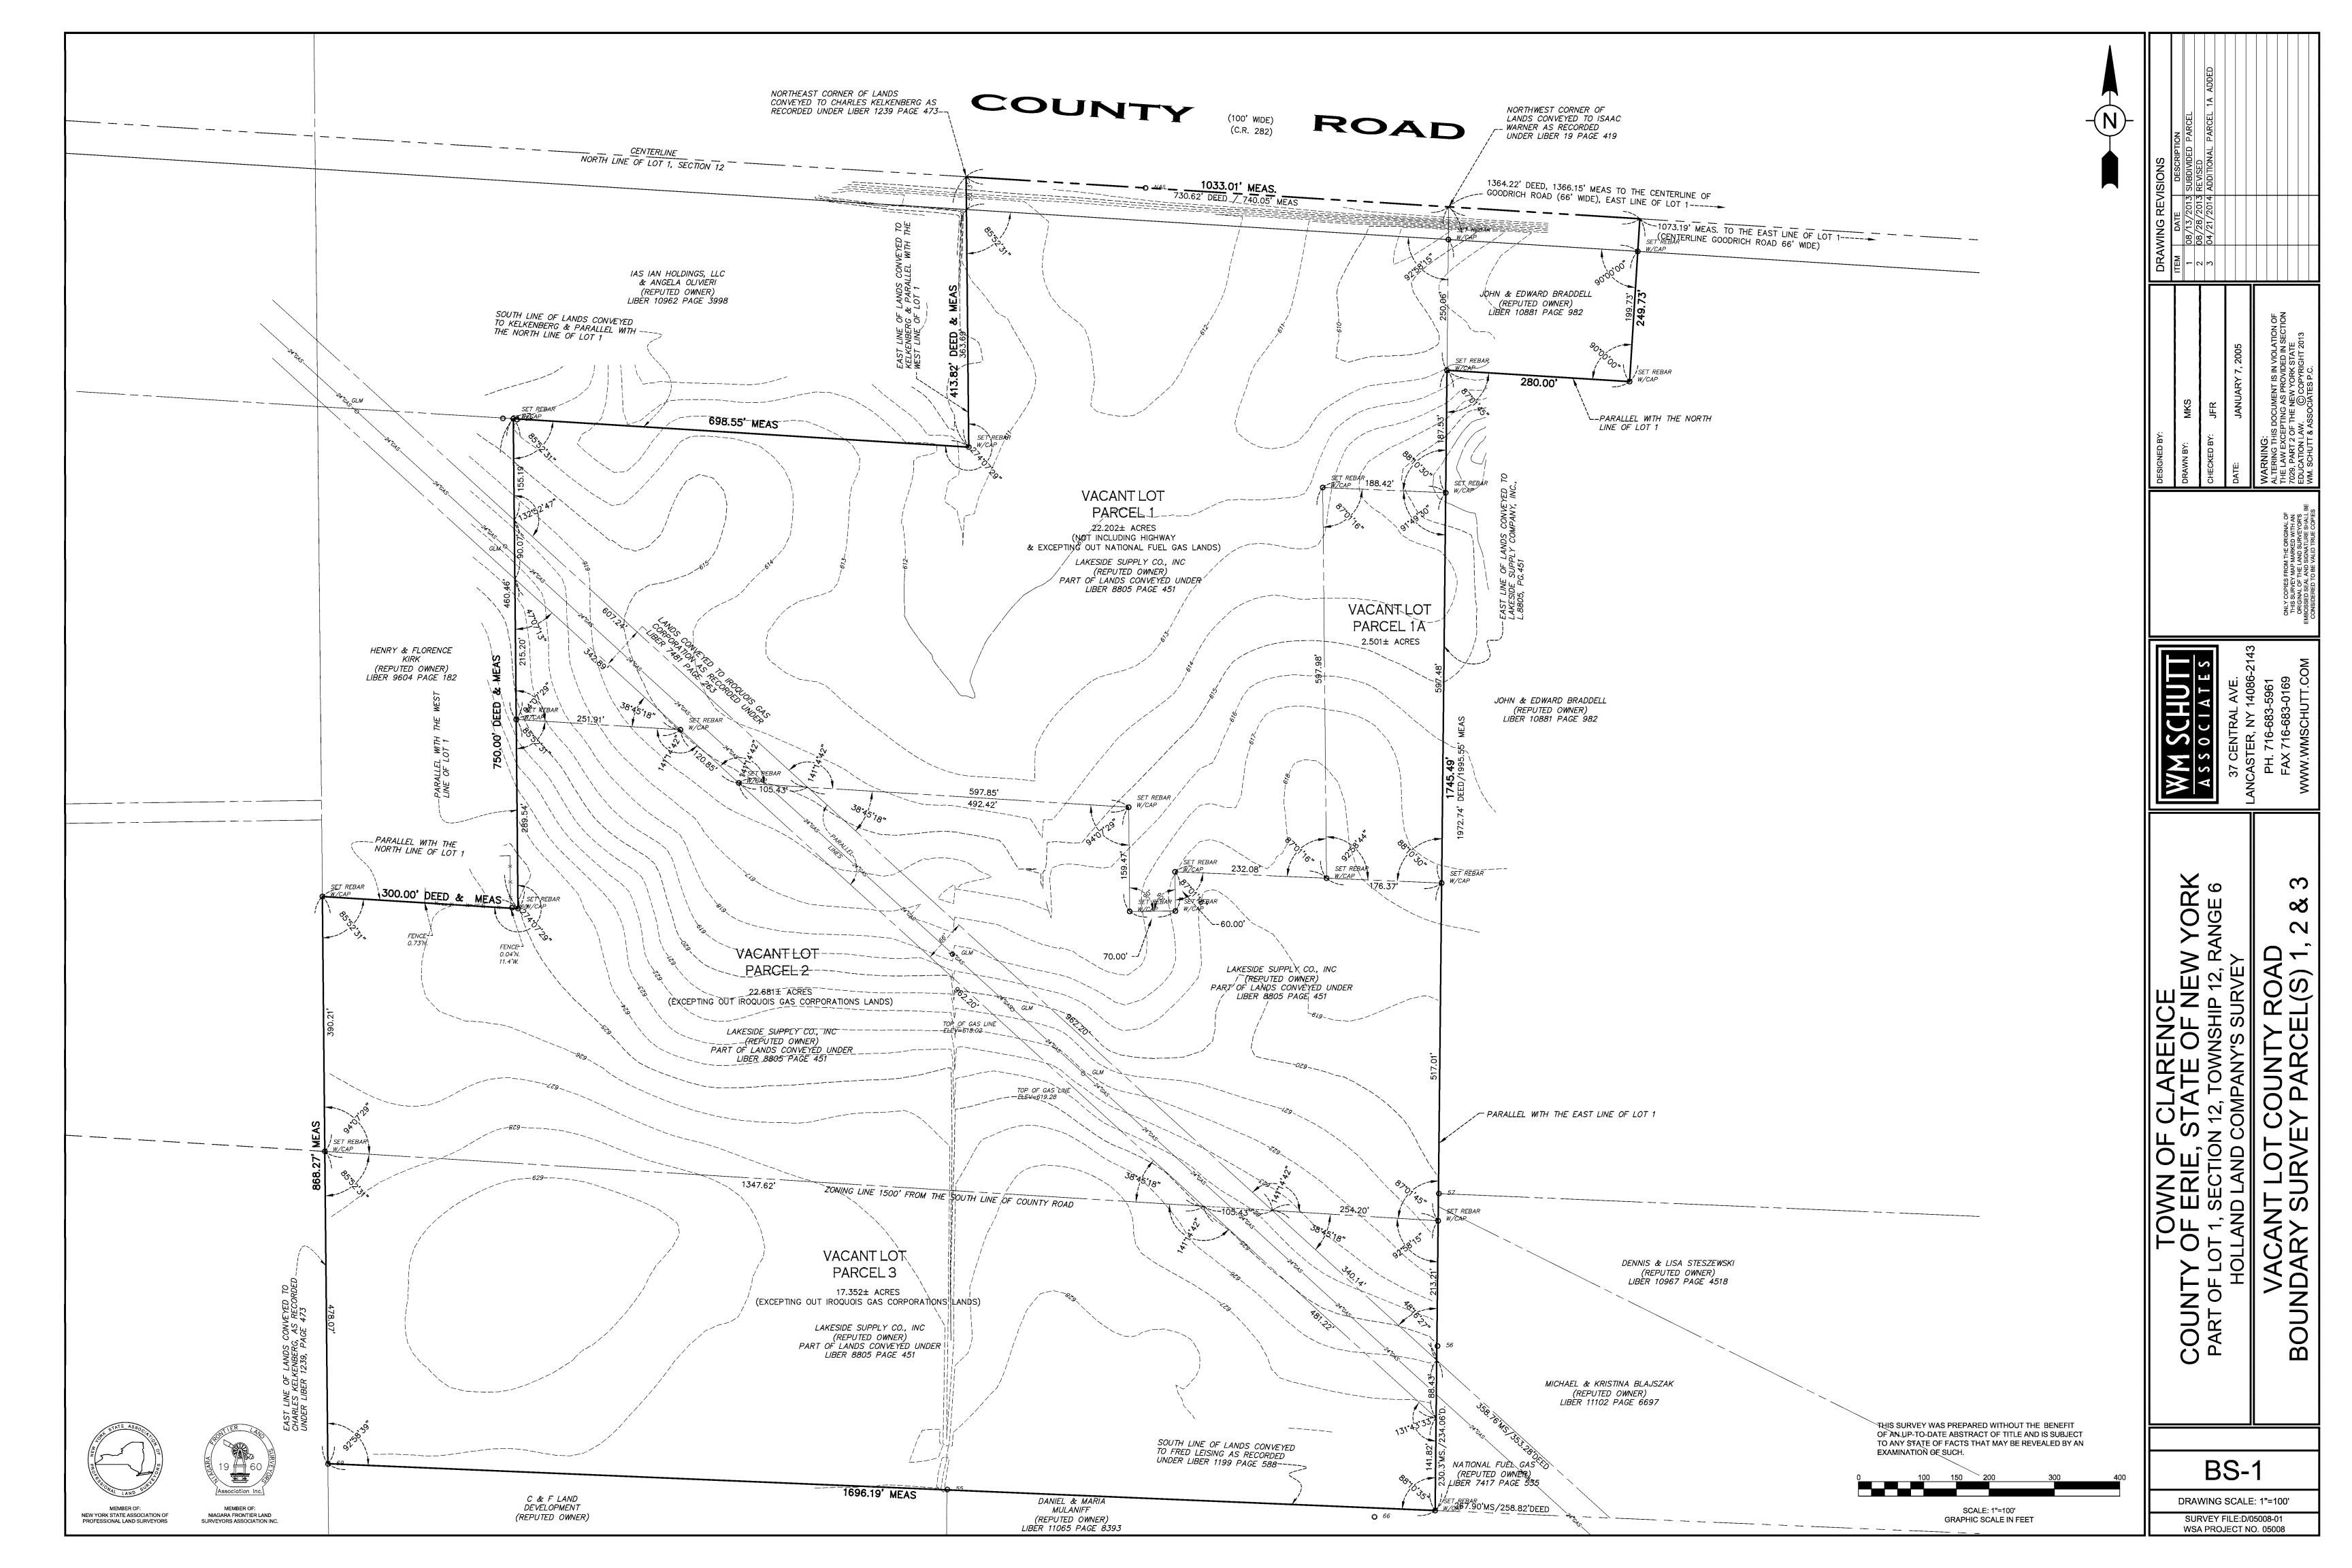

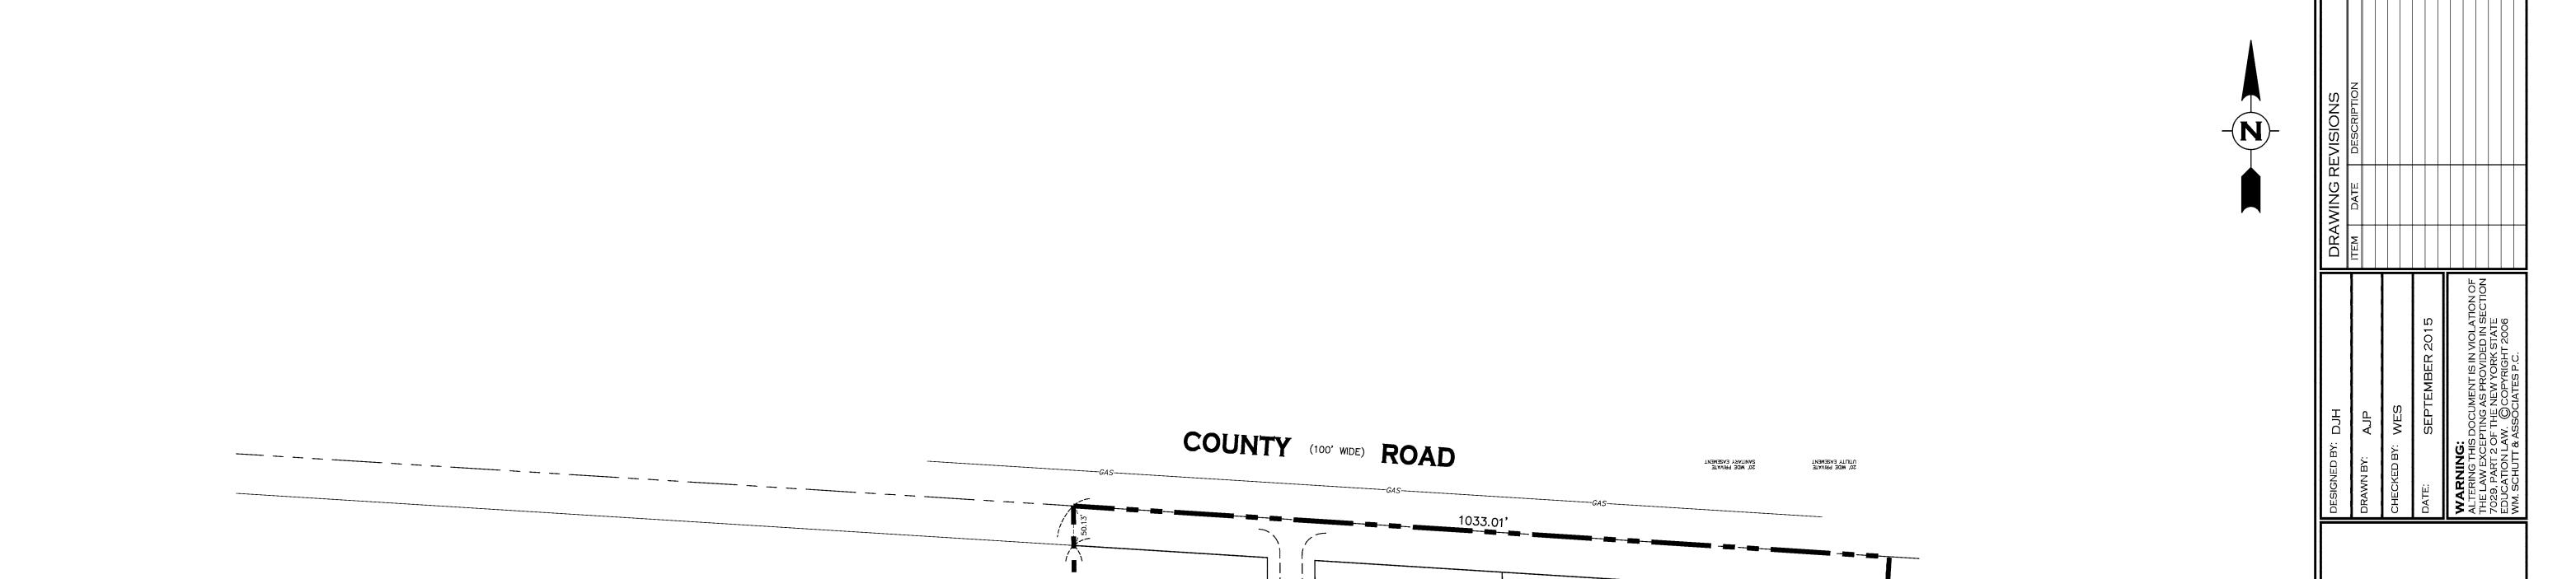

10

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8

JOHN & EDWARD BRADDELL (REPUTED OWNER) LIBER 11104 PAGE 1371 STORM WATER RETENTION AREA

JOHN & EDWARD BRADDELL (REPUTED OWNER) LIBER 11104 PAGE 1371

1

4

5

6

JOHN & EDWARD BRADDELL (REPUTED OWNER) LIBER 11104 PAGE 1371

D FAMILY BUSINESS PARK TOWNSHIP 12 SECTION 12 RANGE 6

CIMATO FAMILY BUSINESS PARK
ART OF LOT 1, TOWNSHIP 12, SECTION 12, RANG
TOWN OF CLARENCE - ERIE COUNTY - NEW YOR


THIS SHEET ISSUED FEBRUARY 25, 2016


SP1


DRAWING SCALE: 1"=10


DRAWING SCALE: 1"=100'
WSA PROJECT NO. 05008D

SCALE: 1"=100' GRAPHIC SCALE IN FEET

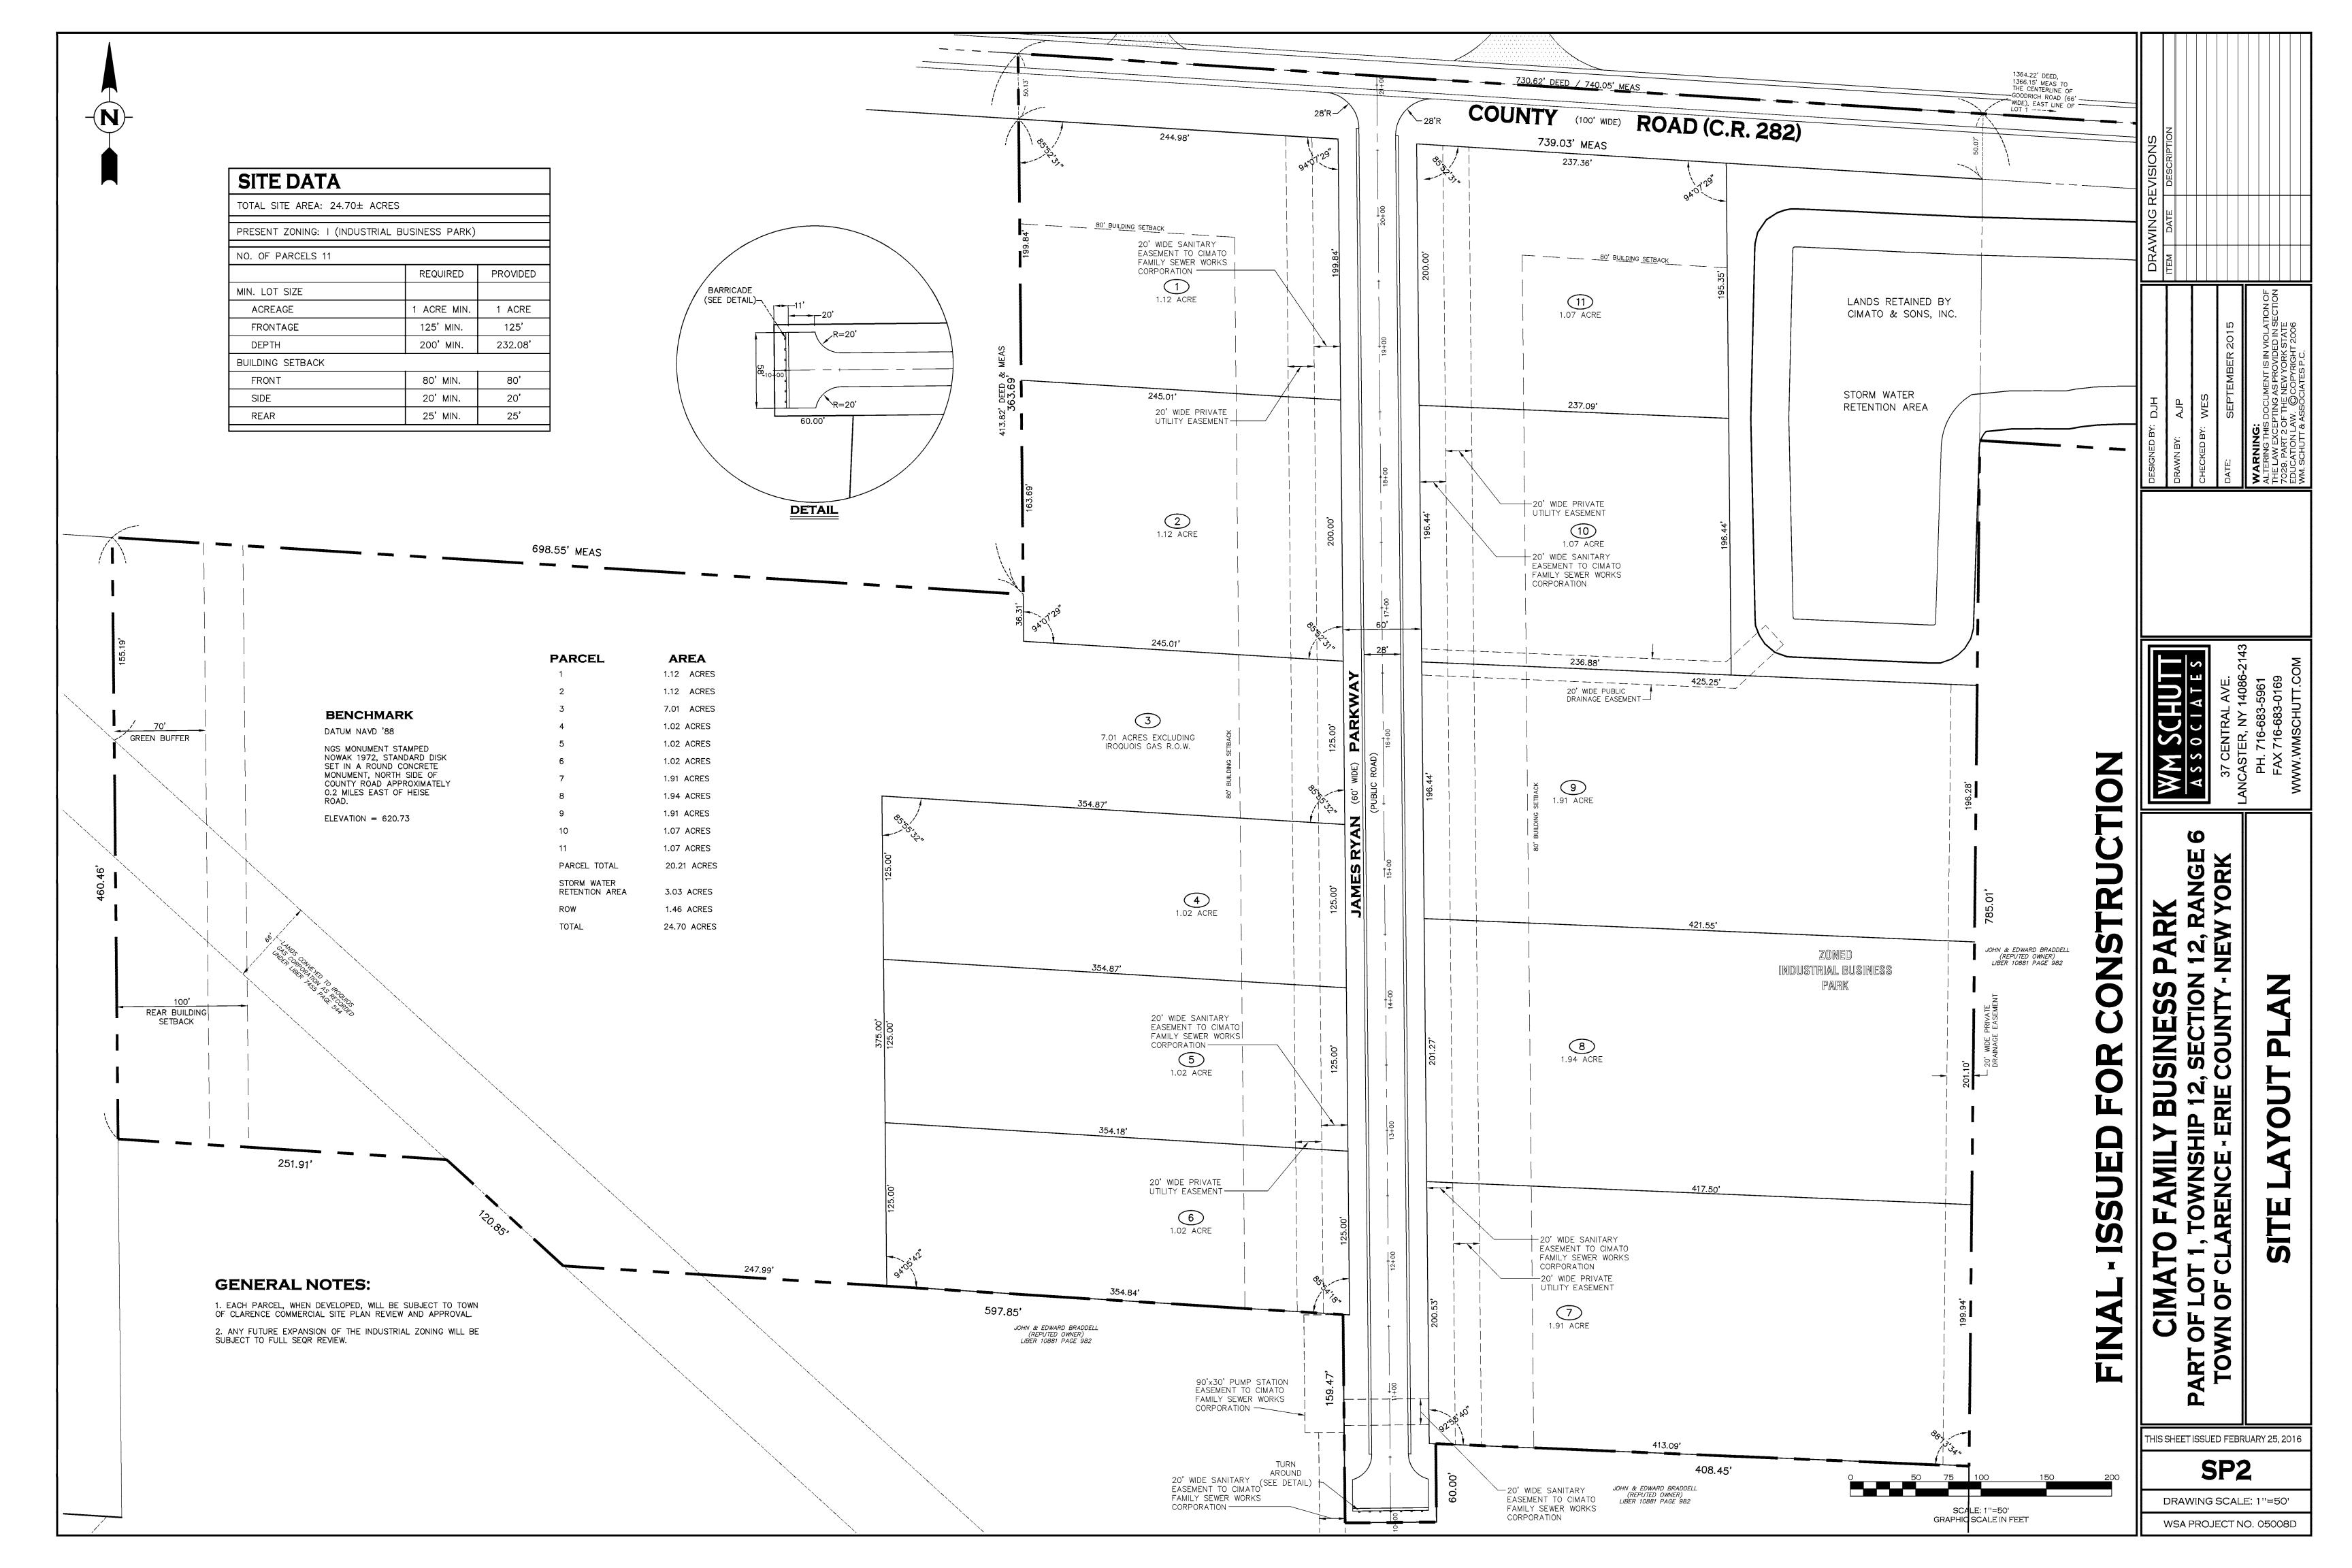

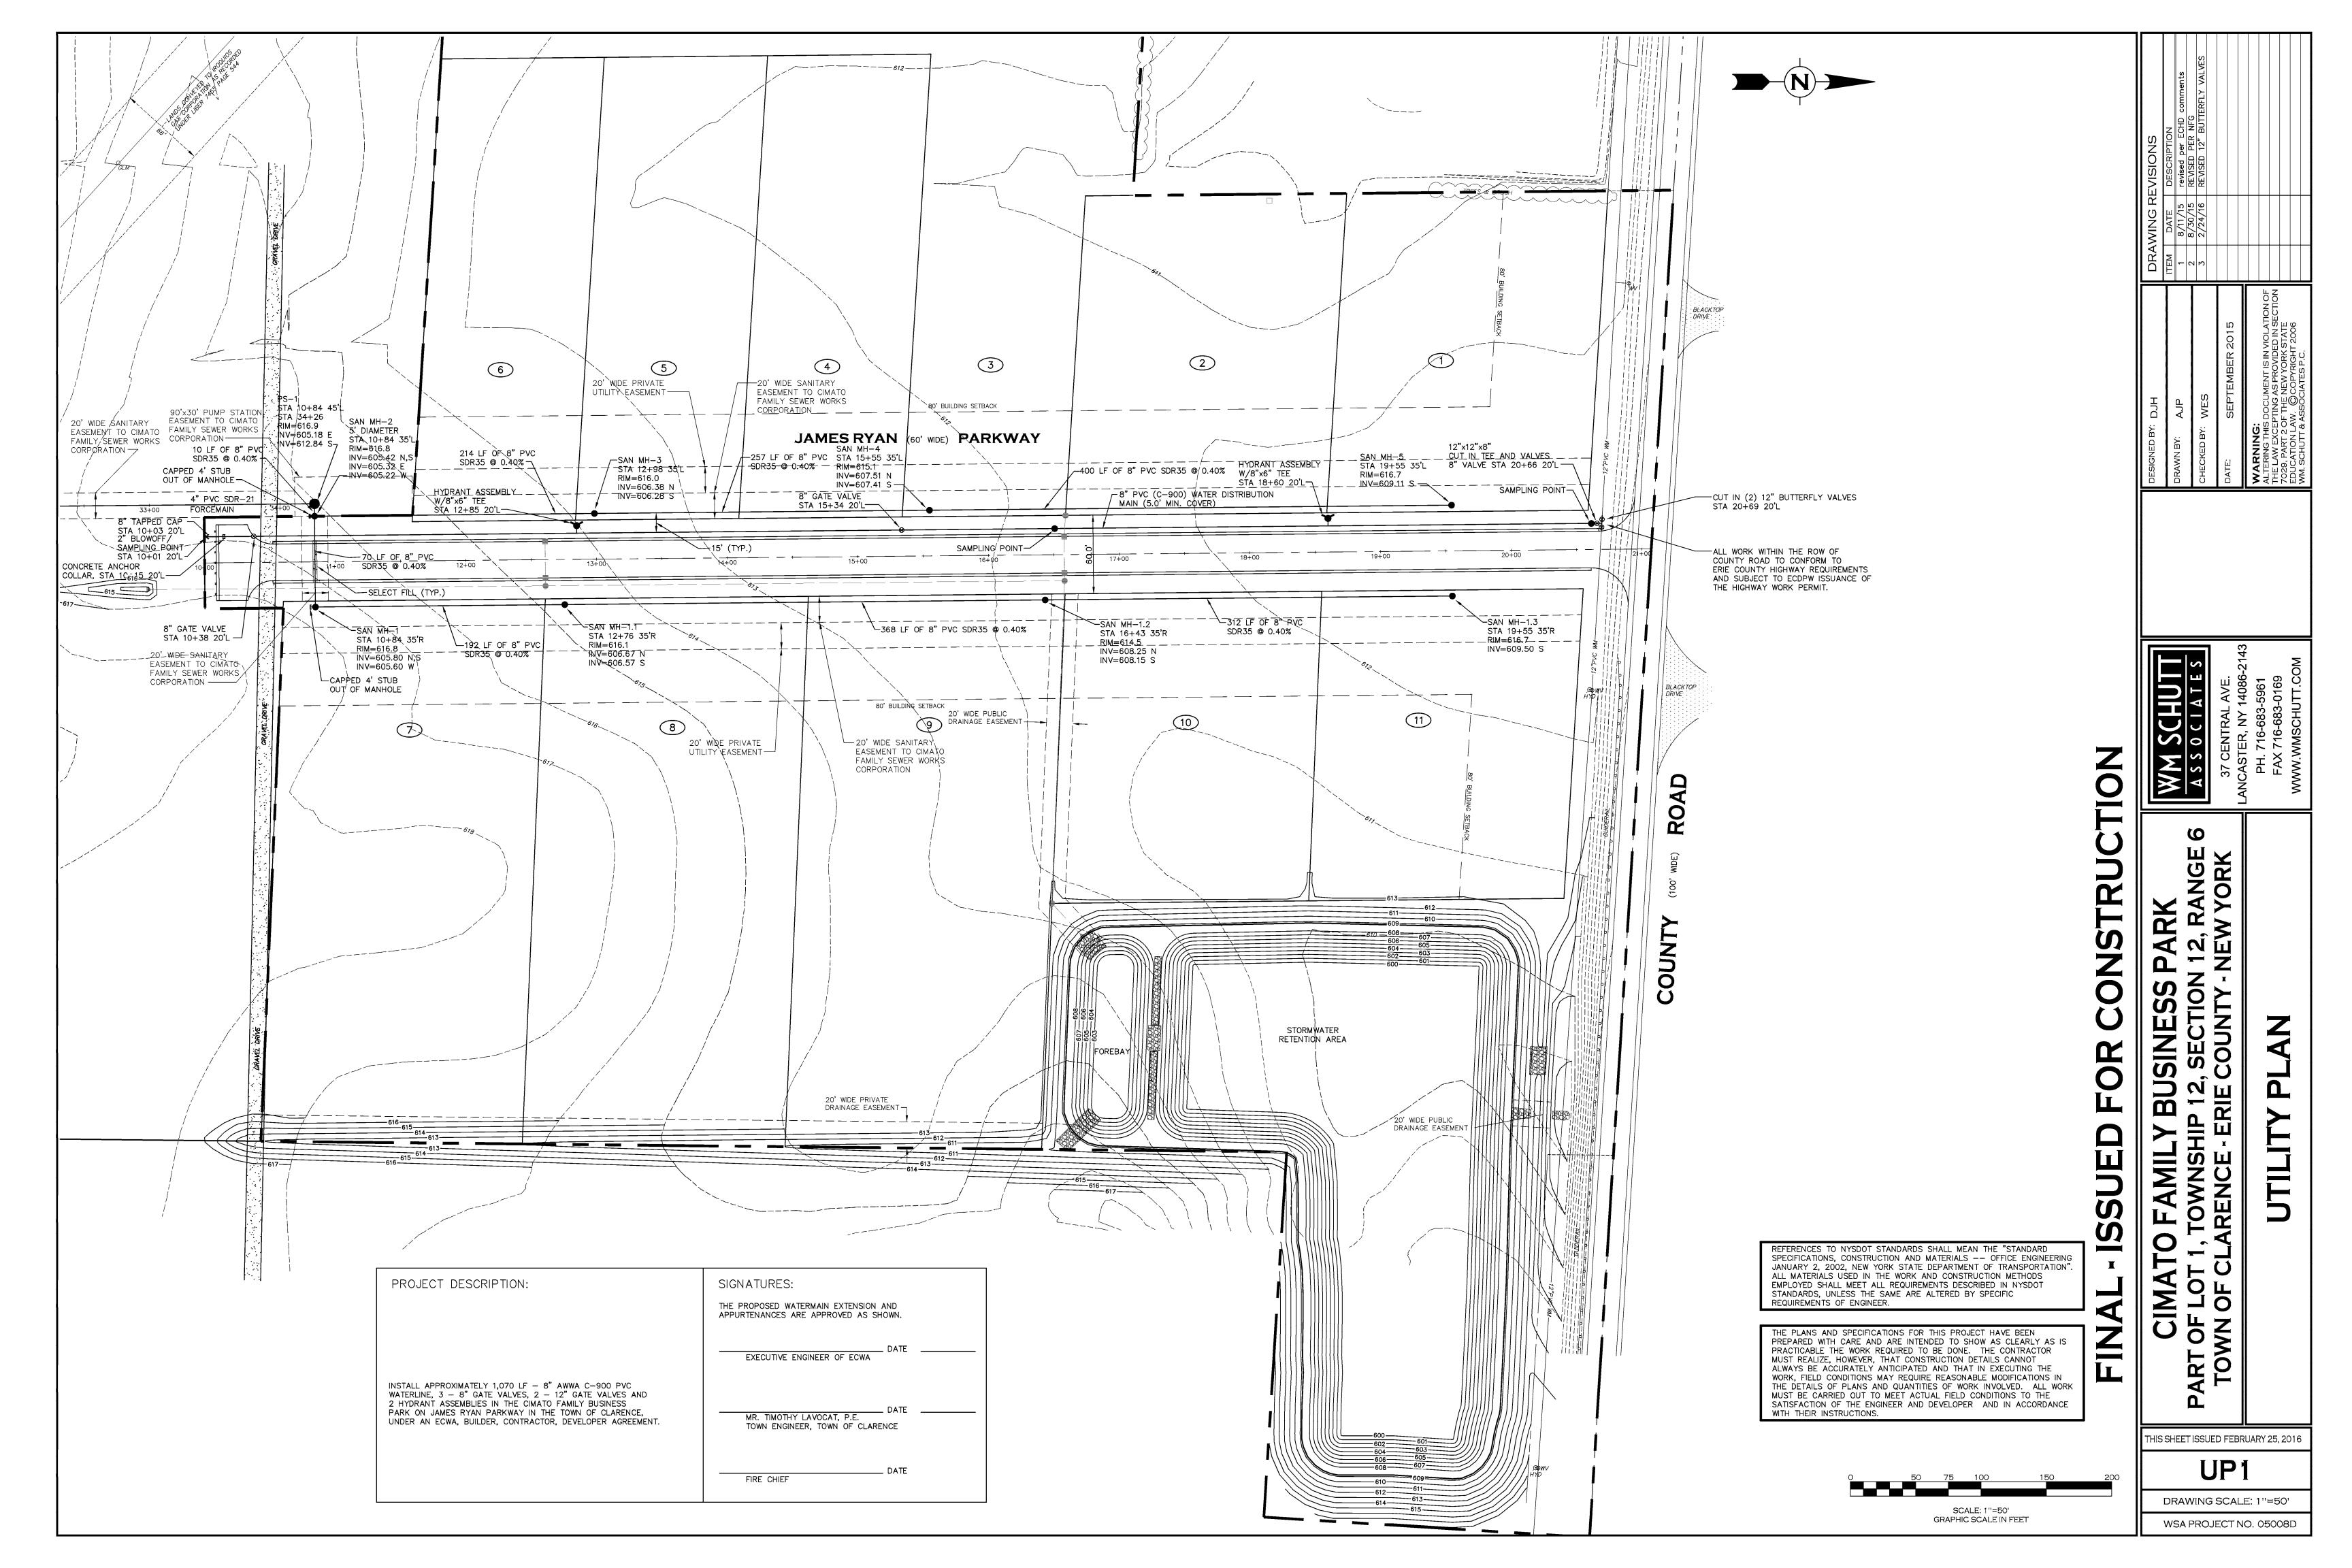

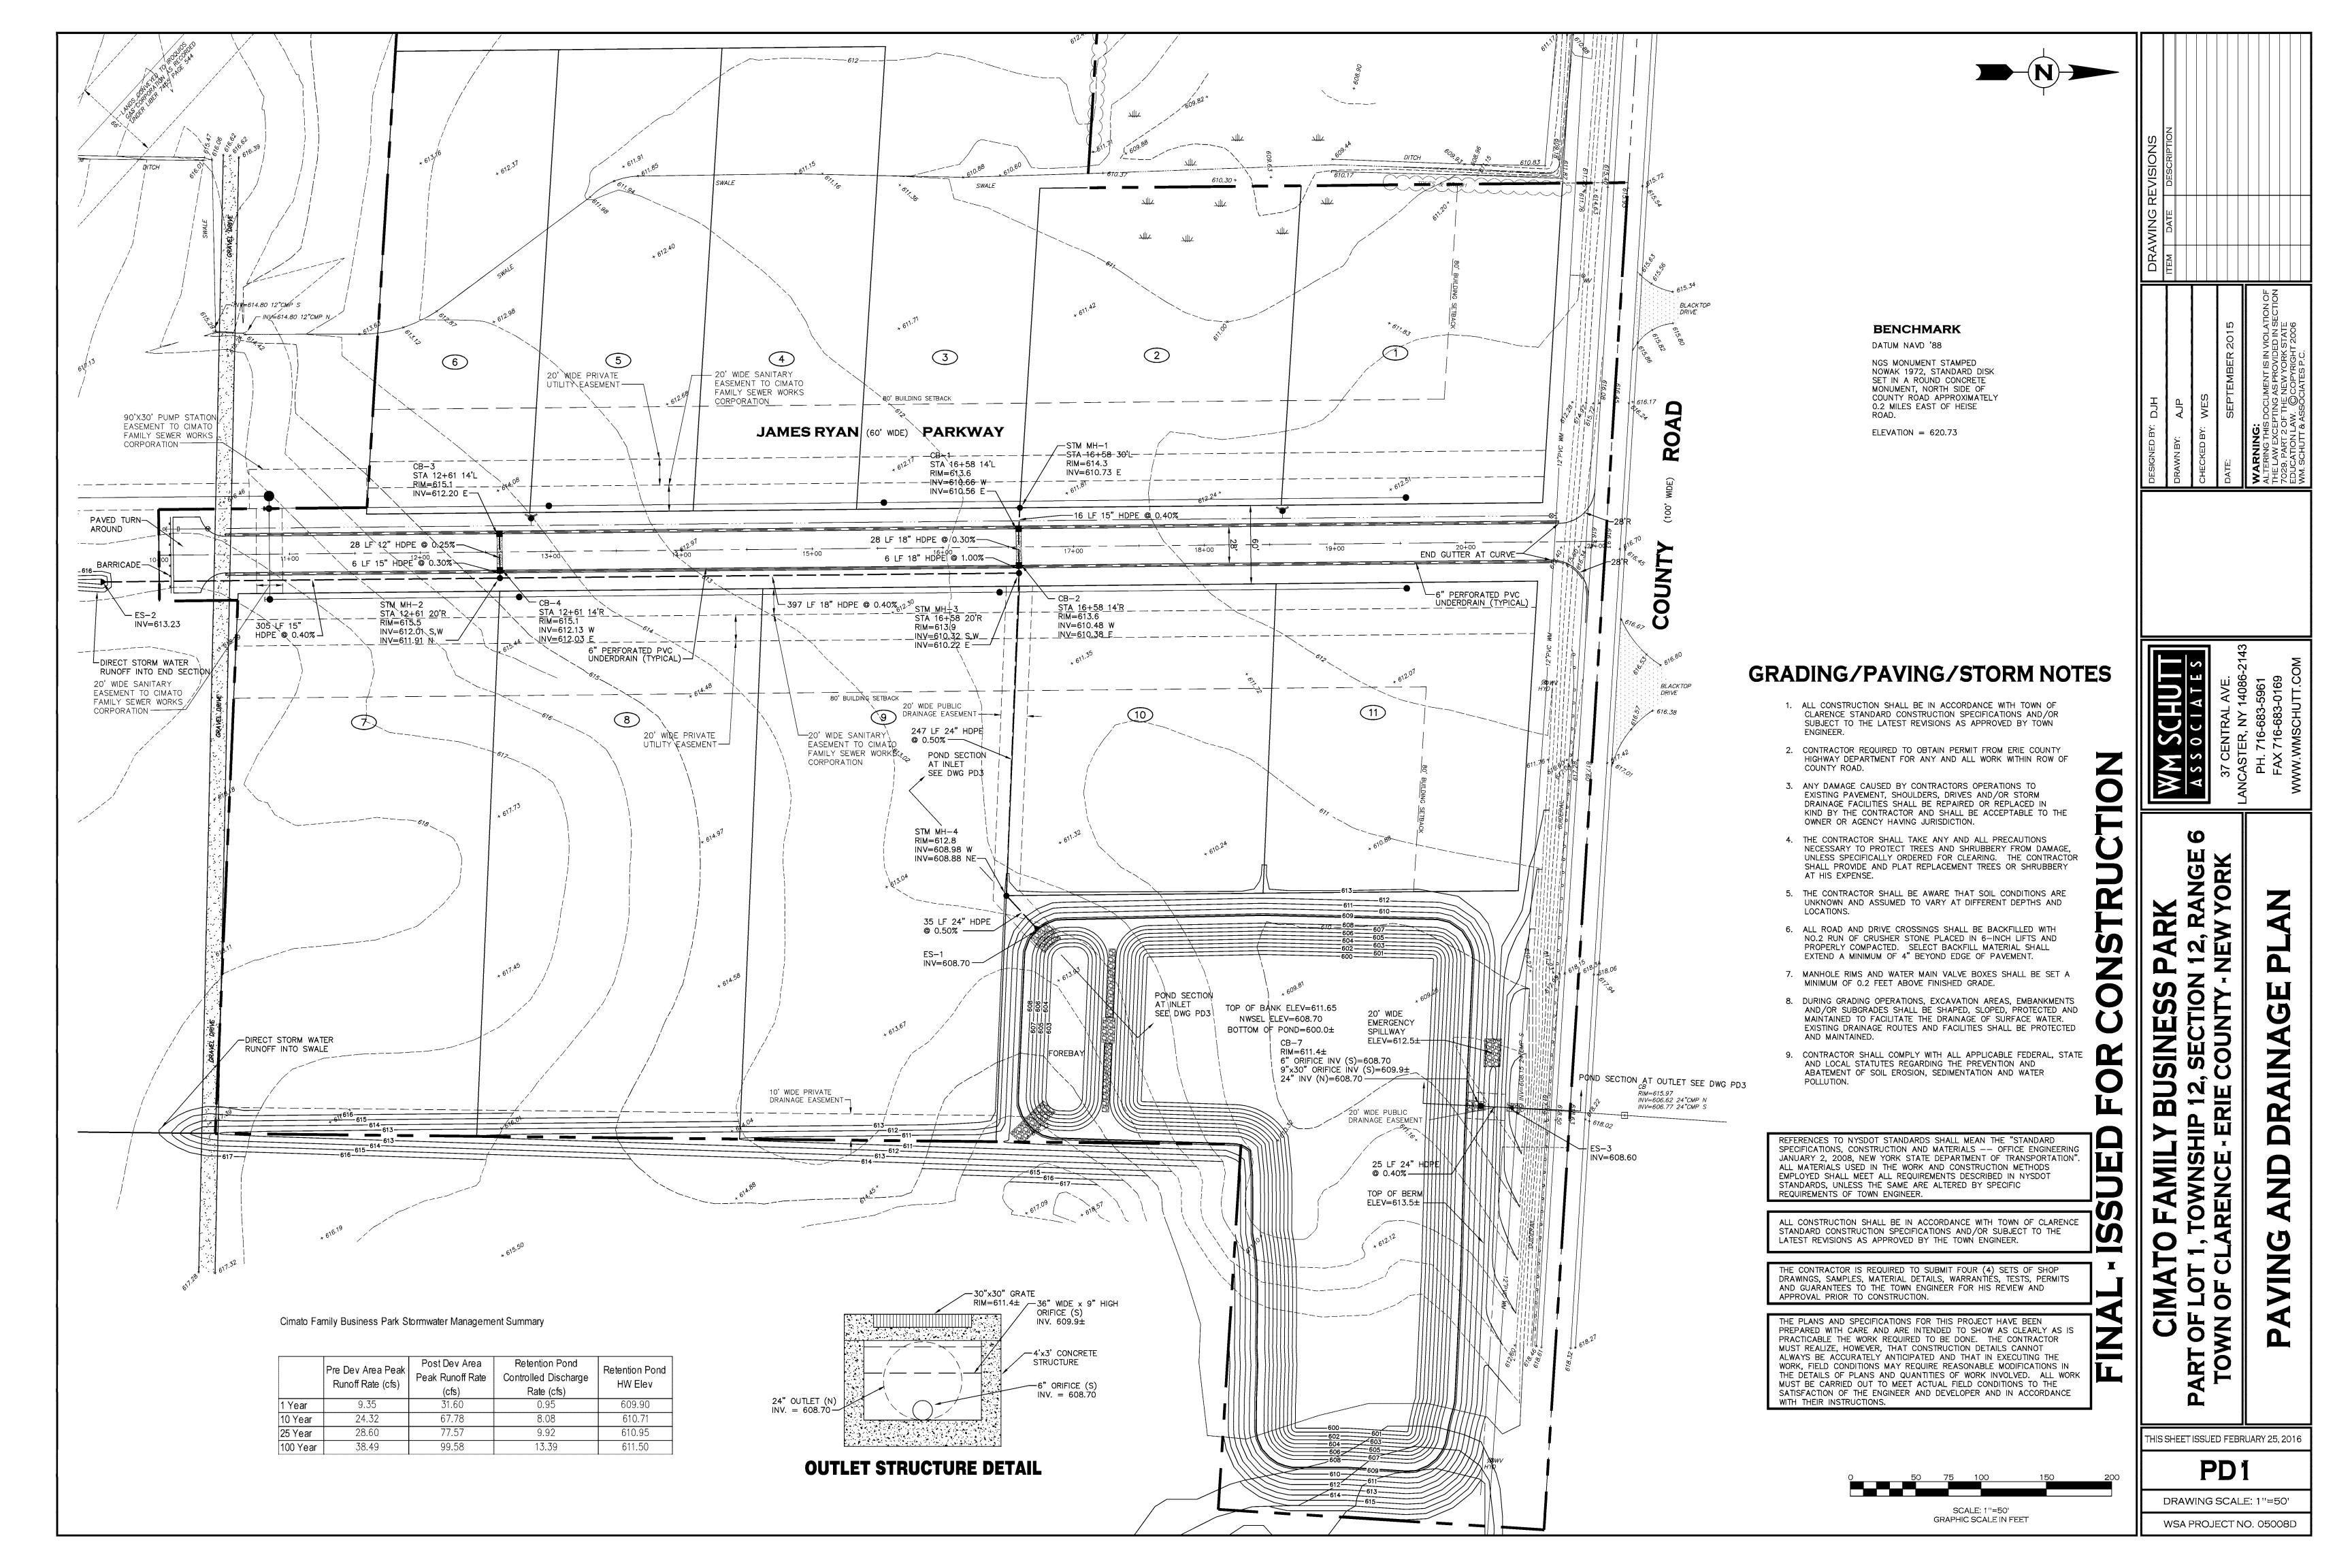

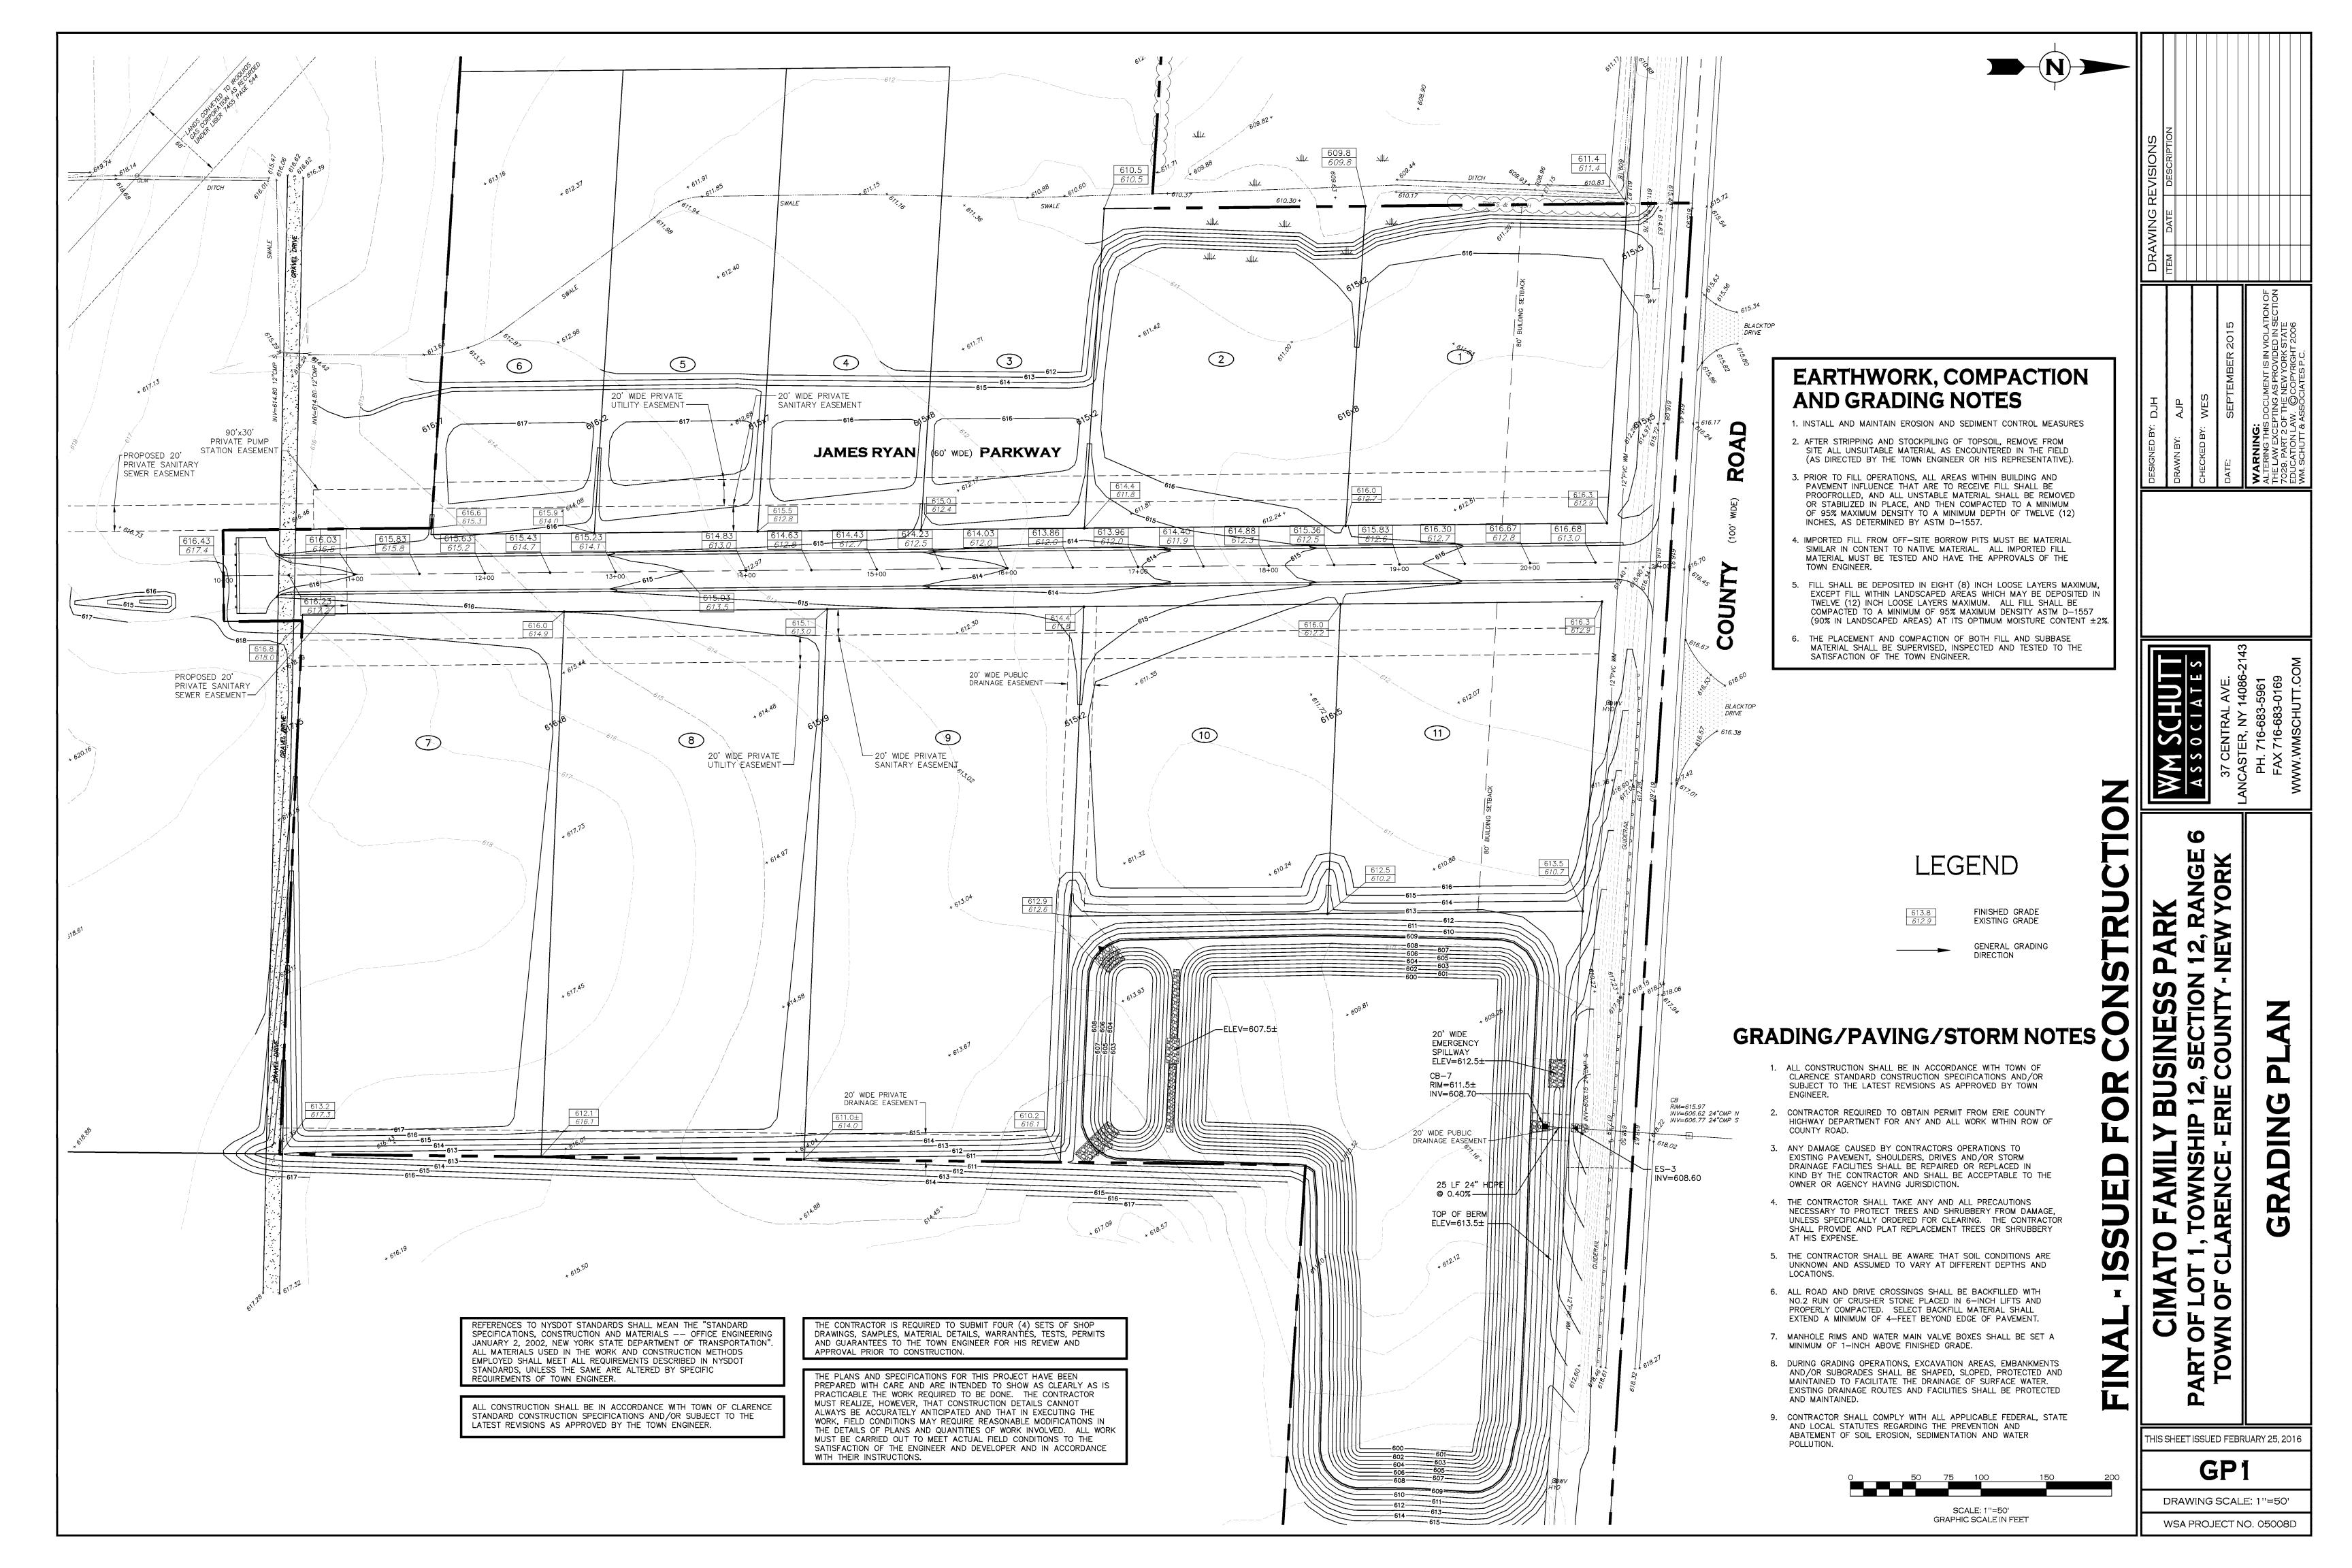


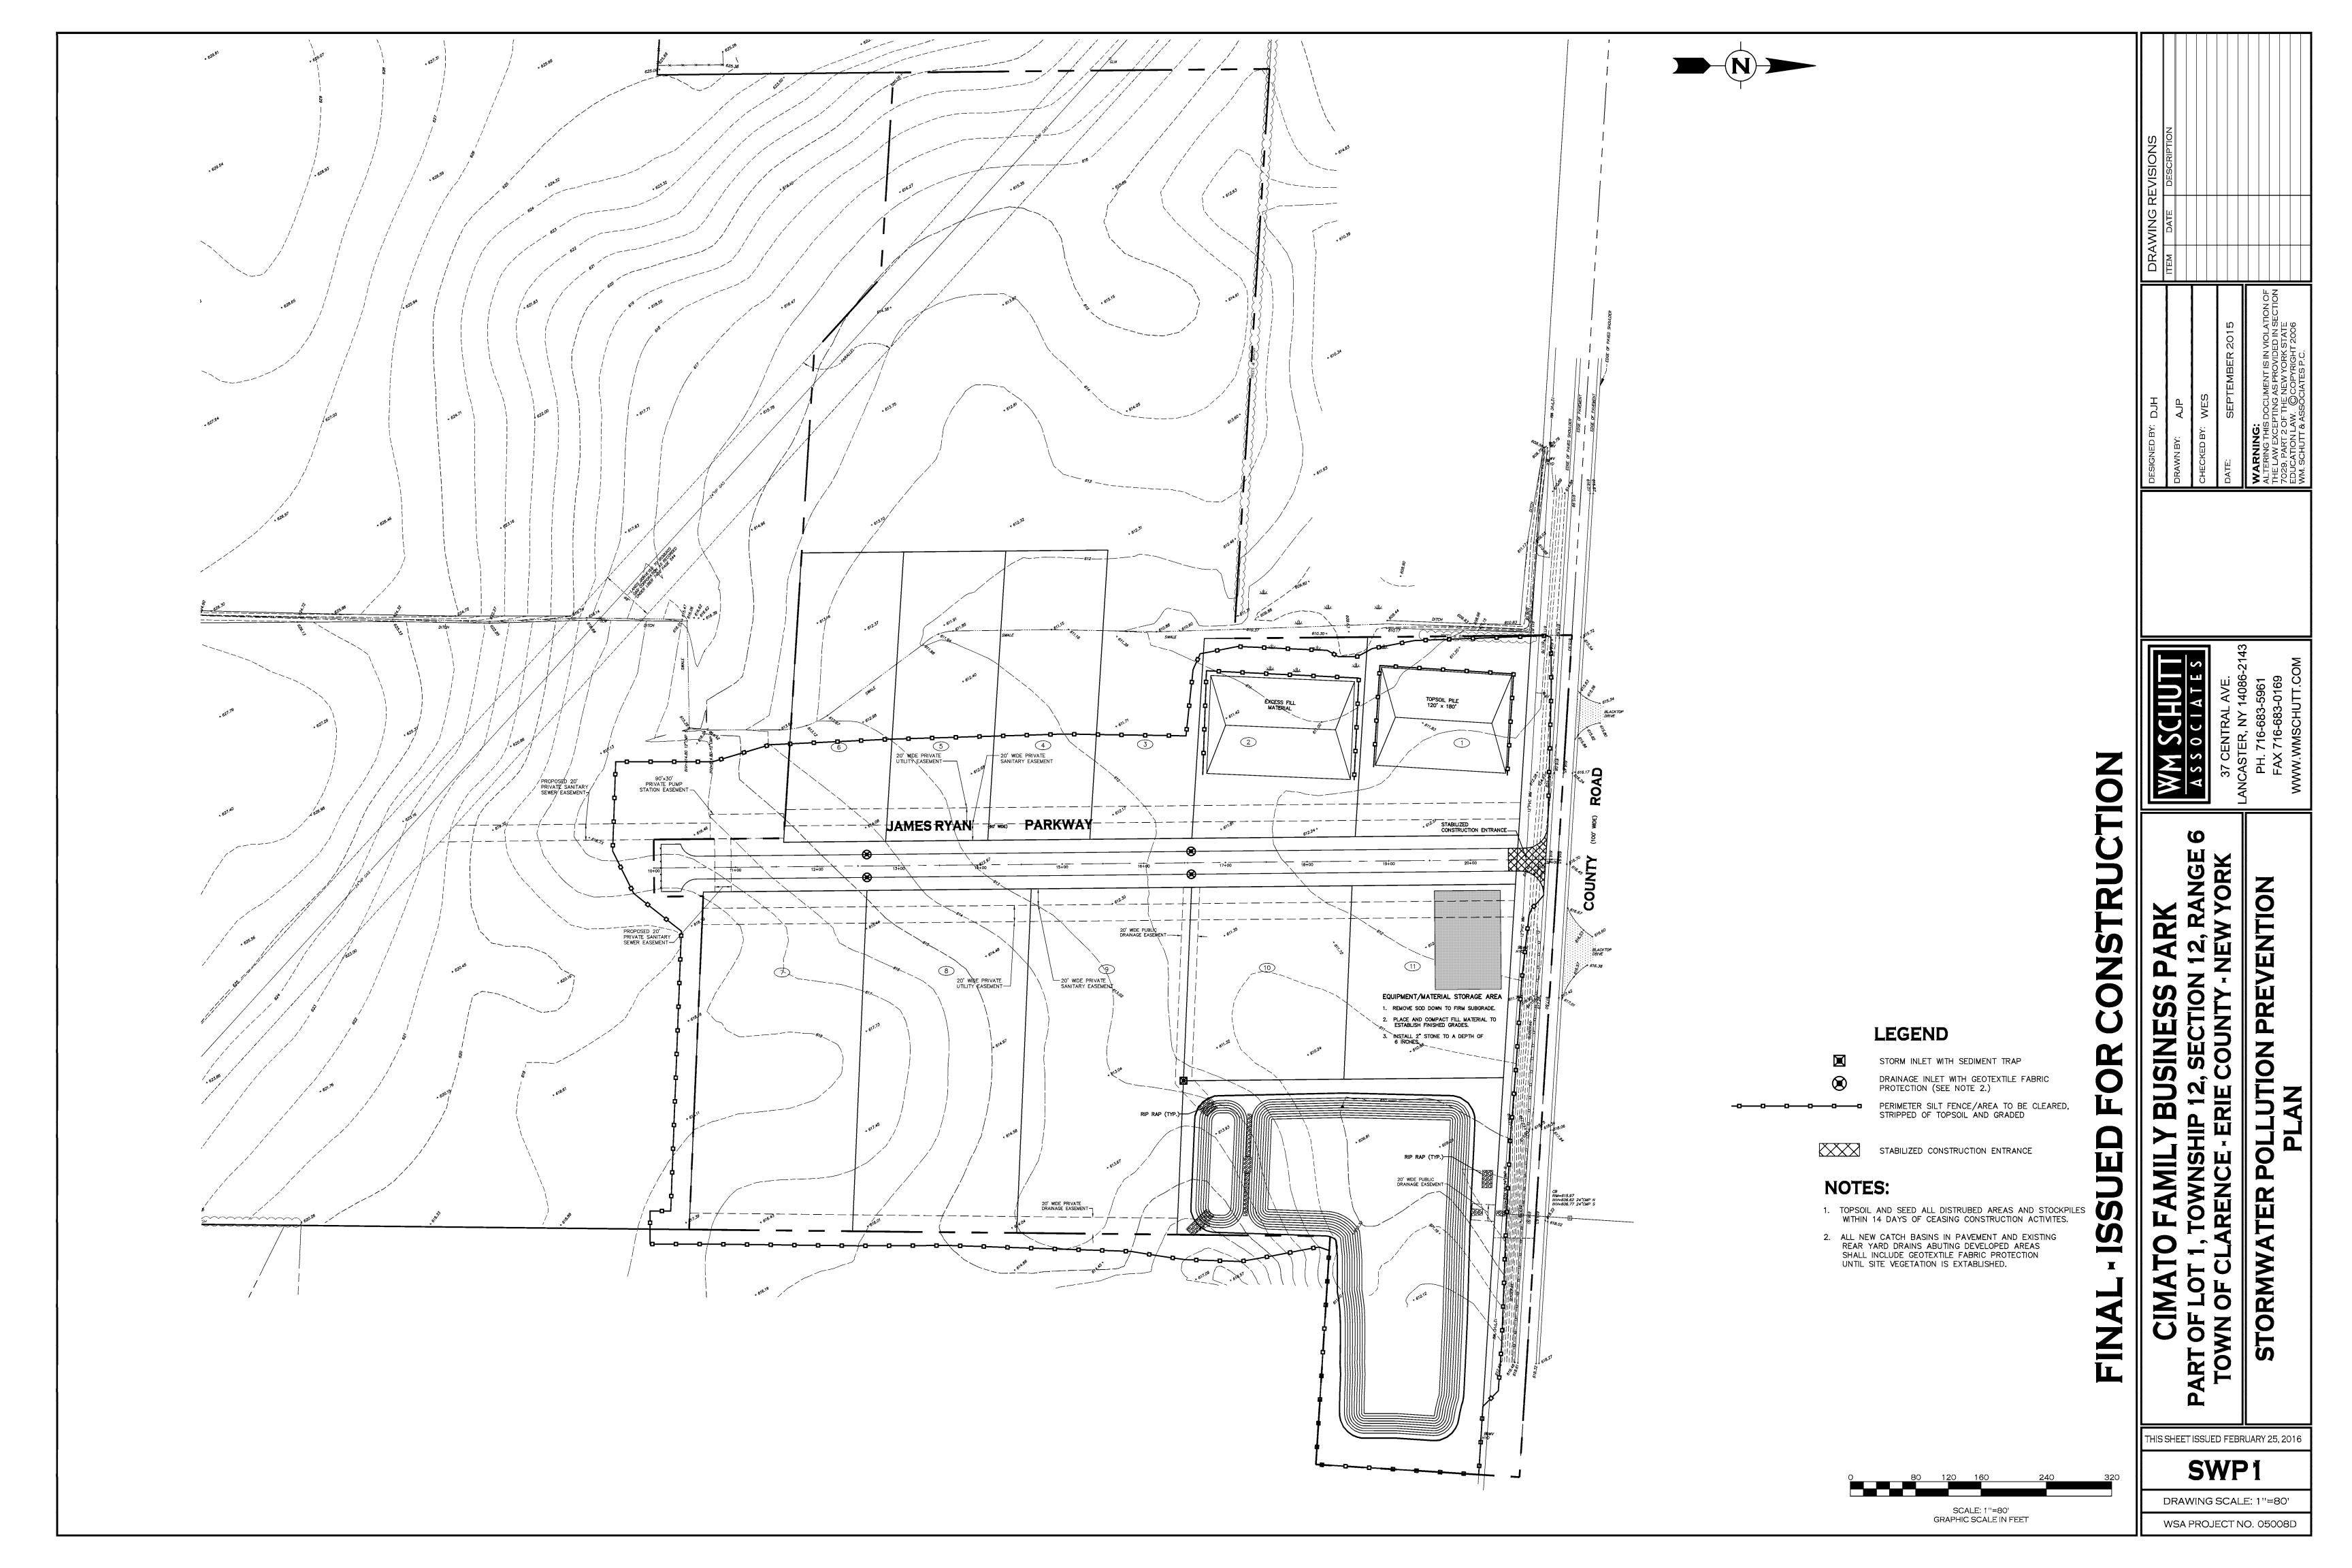


Exhibit 2


Revised Site Plan

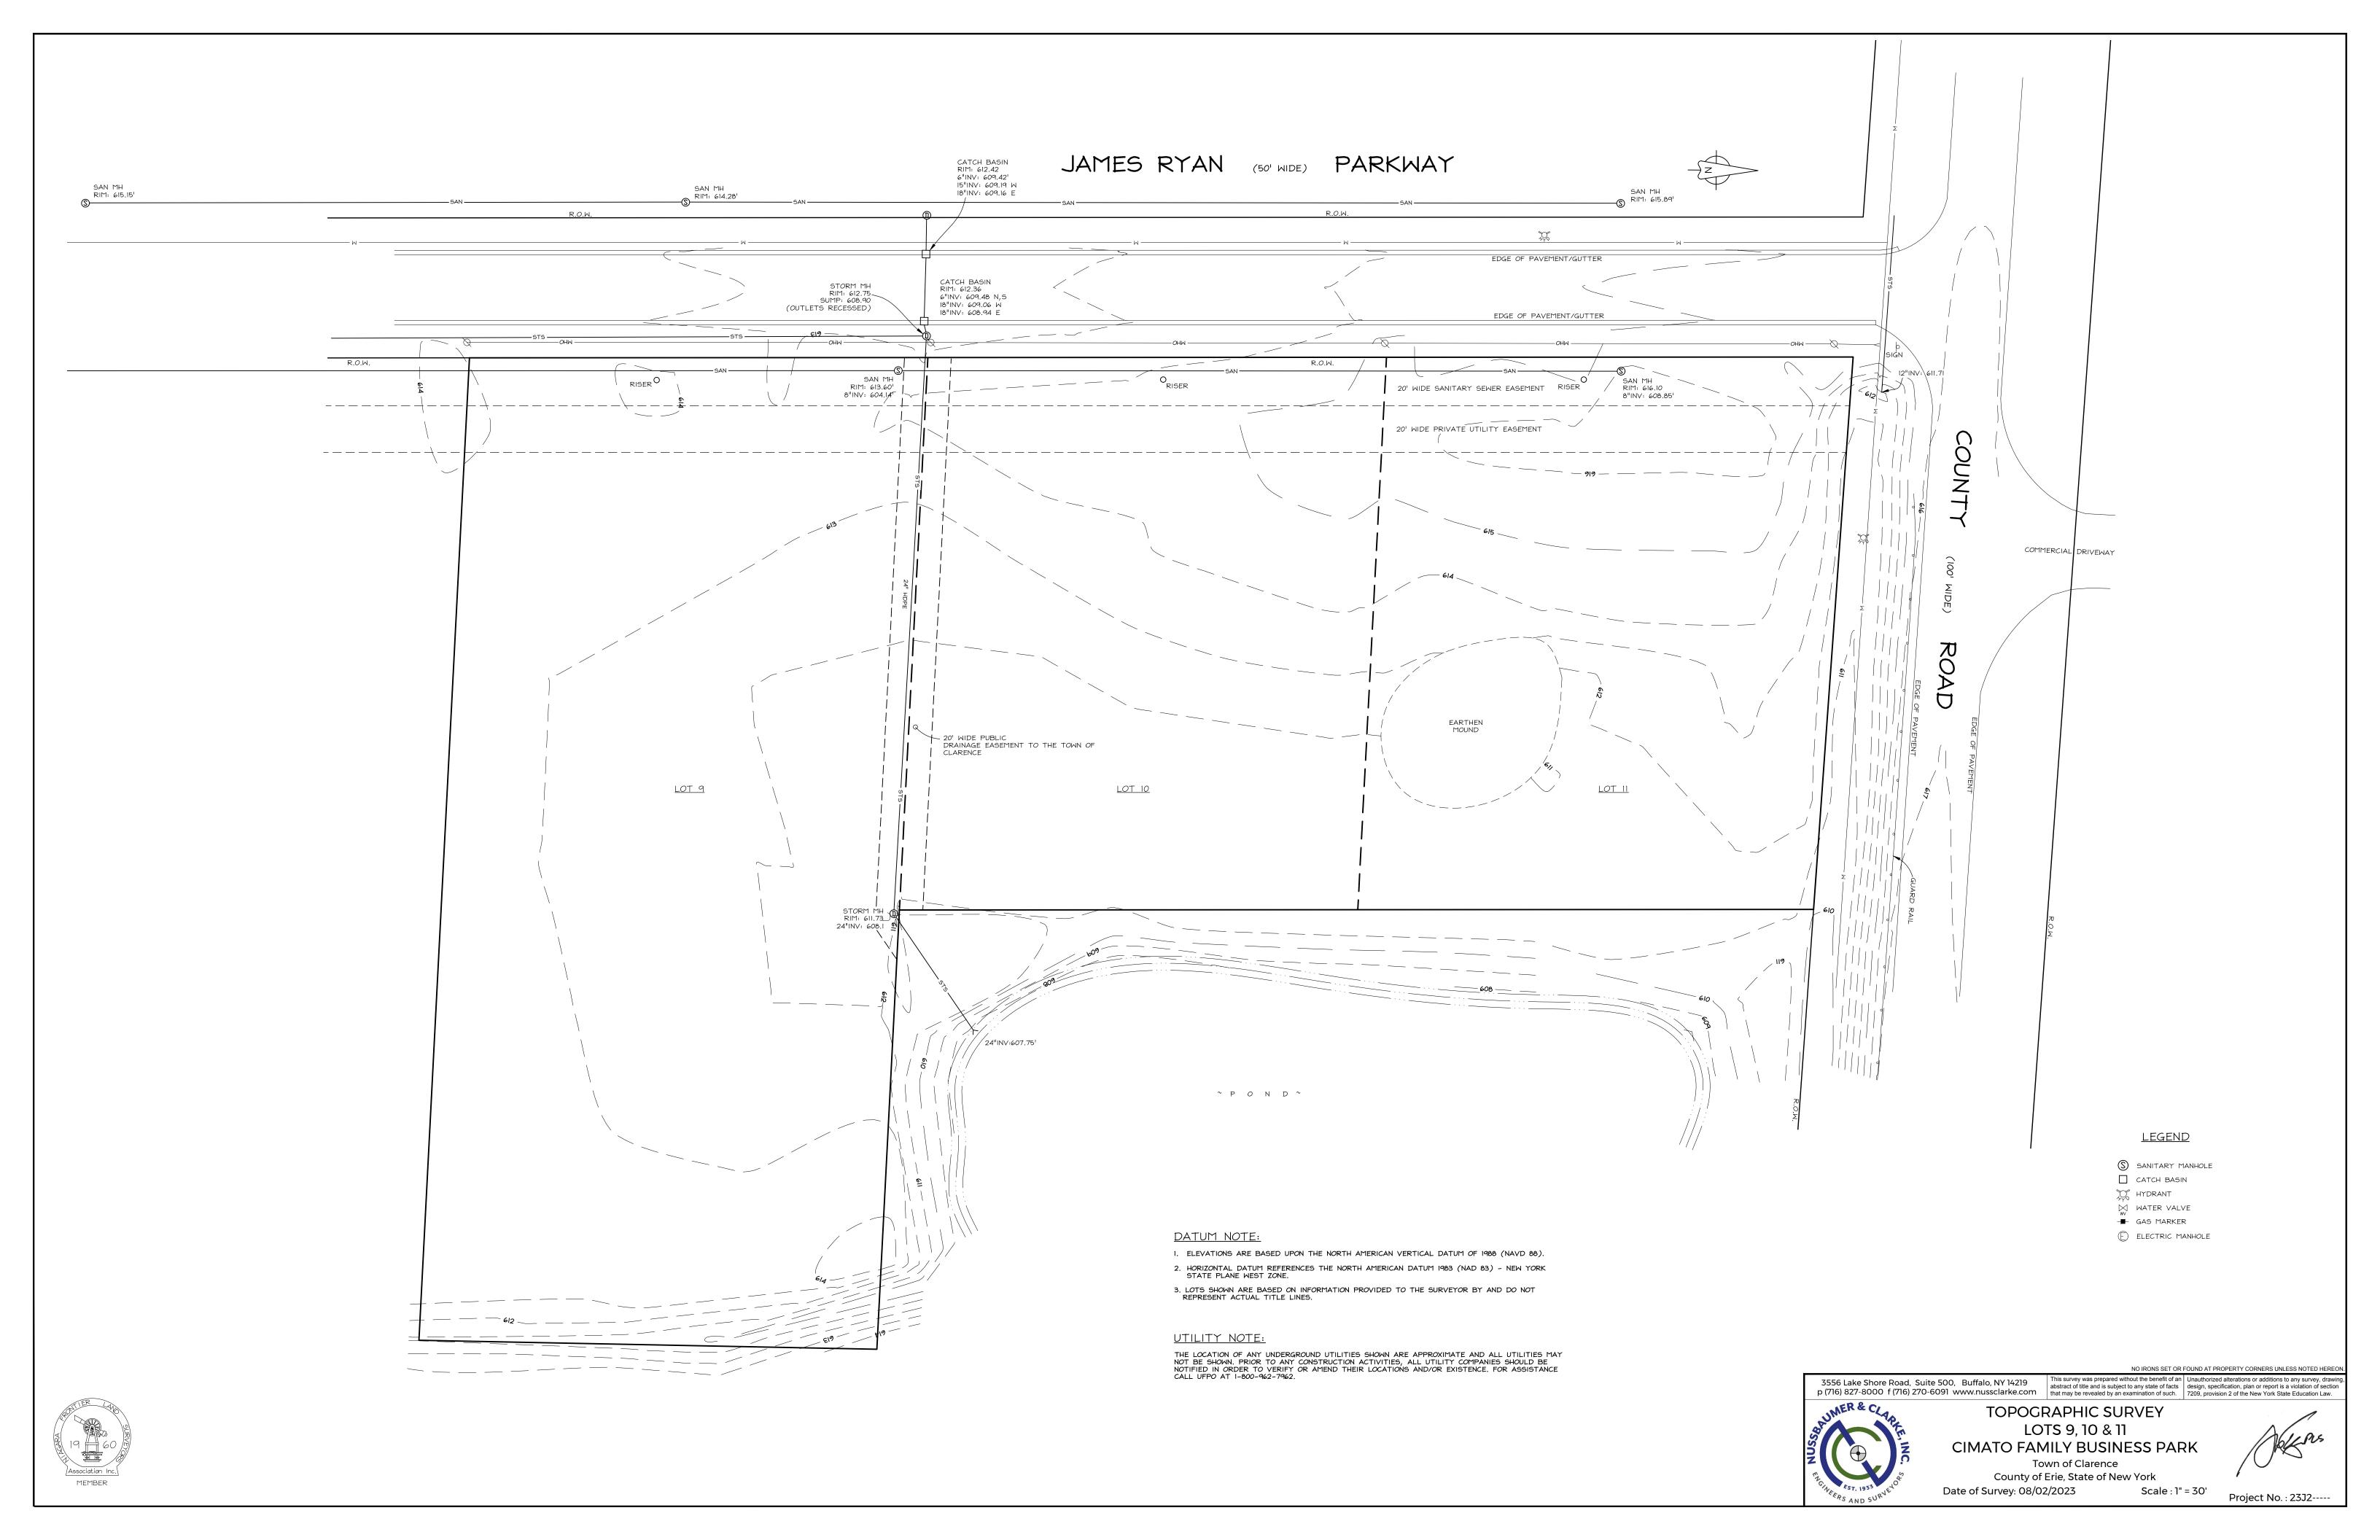

Overall Site Plan

(Ref; C-101 & C-102 for site plan and details)

SCALE: 1"=50'

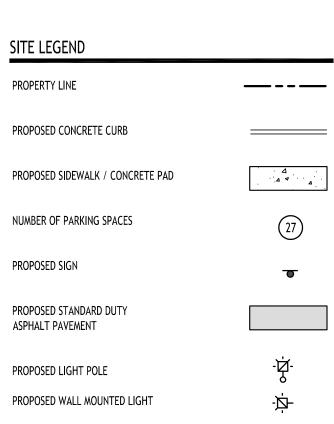

NOTE: BOUNDARY AND TOPOGRAPHIC INFORMATION PROVIDED BY OTHERS, CARMINA WOOD DESIGN ASSUMES NO RESPONSIBILITY FOR ITS ACCURACY.

DRAWING NAME: Overall Site Plan

Drawn By: Scale: DRAWING NO.

07.08.24 C. Wood As Noted

PROPOSED LIGHT POLE

PROPOSED WALL MOUNTED LIGHT


DRAWING NAME:

Site Plan


Drawn By: DRAWING NO.

C. Wood As Noted

07.08.24

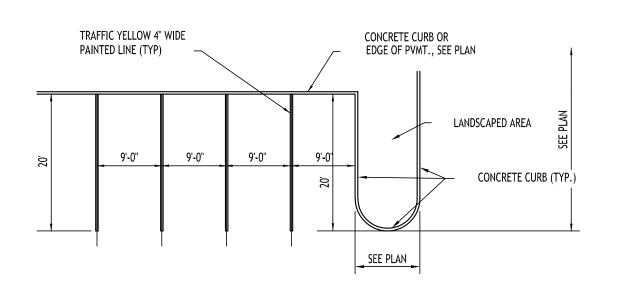

90° PARKING STALL LAYOUT - 4A

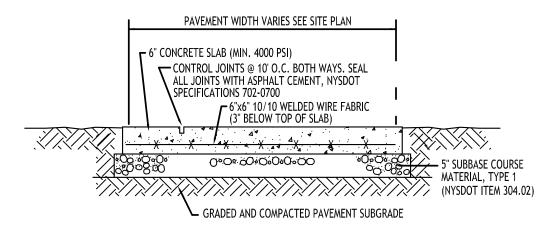


NOTE: CONCRETE PAVEMENT MATERIAL SHALL CONFORM TO NYSDOT STANDARD SPECIFICATION 501 AND CONSTRUCTION METHODS SHALL CONFORM TO NYSDOT STANDARD SPECIFICATION 502-3. **EXTERIOR CONCRETE**


SLAB-ON-GRADE SECTION - 3

NEW CONCRETE (MIN. 3,500 PSI) — SIDEWALK - 4" MIN. THK.

DRIVEWAY - 6" MIN THK. W/W.W.F.6X6/10X10

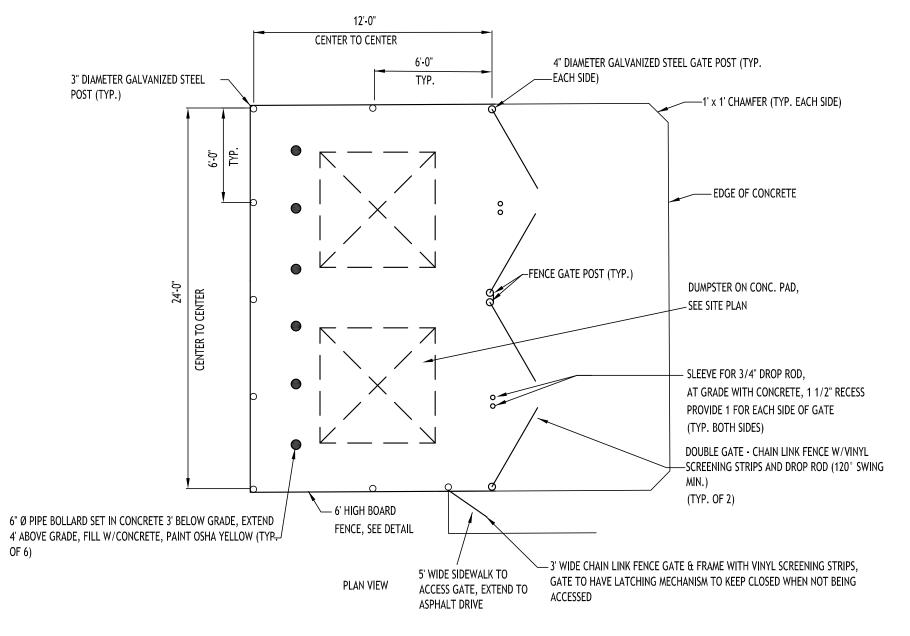


eckerds detail

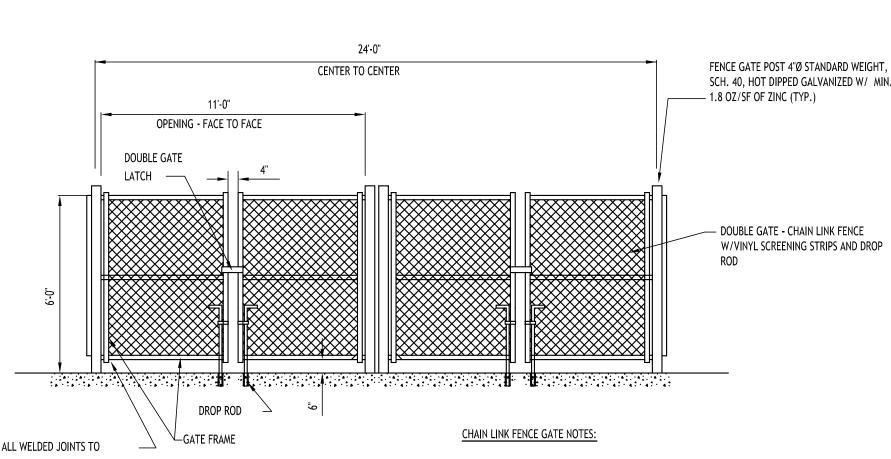

DUMPSTER ENCLOSURE - 8


INSTALLED IN PAVEMENT

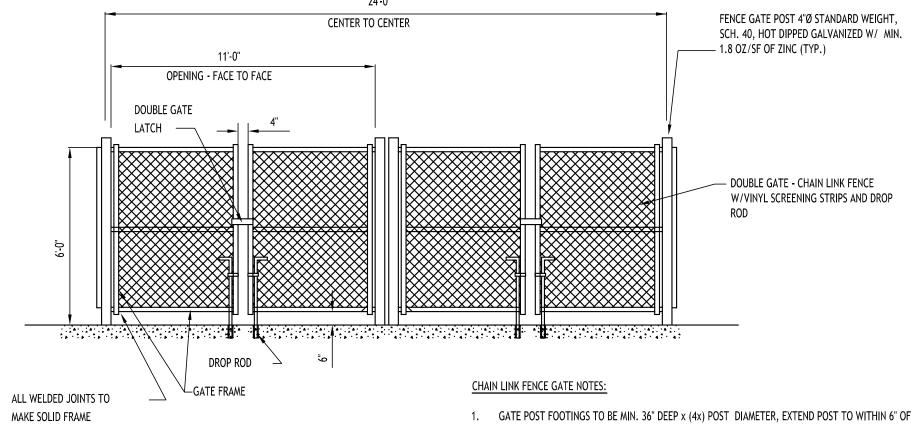

FRONT VIEW

1. GATE POST FOOTINGS TO BE MIN. 36" DEEP x (4x) POST DIAMETER, EXTEND POST TO WITHIN 6" OF BOTTOM.

- 2. GATE FRAMES TO BE 2" SQ. GALVANIZED STEEL, WEIGHING 2.60 LB/FT IN ACCORDANCE WITH ASTM F 900.
- 3. CHAIN LINK FENCE FABRIC SHALL BE 2" MESH, 9 GAUGE, ZINC COATED STEEL CORE WIRE. INSTALL MESH WITH HOOK BOLTS AND TENSION BARS ON ALL 4 SIDES, ATTACH AT 15" MAX.
- 4. DOUBLE GATE LATCH TO BE FORKED TYPE CAPABLE OF RETAINING GATE IN CLOSED POSITION AND HAVE PROVISION FOR PAD LOCK. LATCH SHALL BE OPERABLE FROM EITHER SIDE OF GATE.
- 5. ALL HARDWARE TO BE HOT DIPPED GALVANIZED STEEL TO SUIT GATE SIZE.

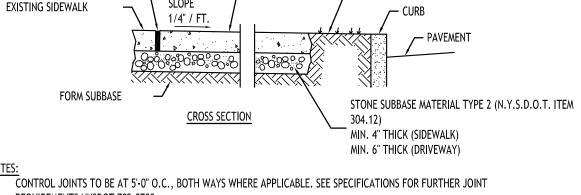

NOTES:


1. CONTROL JOINTS TO BE AT 5'-0" O.C., BOTH WAYS WHERE APPLICABLE. SEE SPECIFICATIONS FOR FURTHER JOINT REQUIREMENTS NYSDOT 702-0700.


- 2. CONCRETE SIDEWALK AND DRIVEWAY MATERIAL SHALL CONFORM TO NYSDOT STANDARD SPECIFICATION 501 AND CONSTRUCTION METHODS SHALL CONFORM TO NYSDOT STANDARD SPECIFICATION 608-3.
- 3. SUBBASE GRADE SHALL FOLLOW THE PROPOSED GRADE OF THE SIDEWALK AND SLOPE AWAY FROM BUILDING WHERE APPLICABLE, PROVIDE CONTINUOUS STONE PATH TO CURB UNDERDRAIN WHERE PROVIDED.
- 4. FULL DEPTH EXPANSION JOINTS SHALL BE INSTALLED EVERY 20' O.C., BOTHWAYS WHERE APPLICABLE. SEE SPECIFICATIONS FOR FURTHER JOINT REQUIREMENTS NYSDOT 702-0700.
- 5. SEE CURB DETAIL FOR DOWLING REQUIREMENTS WHERE ABUTTING CURB.


EXPANSION JOINT 1/2" RECESS

- 6. INSTALL 6" LONG #3 DOWELS @ 12" O.C. WHERE SIDEWALK ABUTS A BUILDING WALL AT AN ENTRANCE, THICKEN SIDEWALK TO 6" AT BUILDING WALL AND INSTALL DOWEL CENTERED IN THE 6" DEPTH. DOWELS AND THICKENING OF SIDEWALK SHALL EXTEND 18" EITHER SIDE OF ENTRANCE.
- 7. INSTALL 1/2" PREMOLDED EXPANSION JOINT WITH BACKER ROD & SEALANT WHERE SIDEWALK ABUTS BUILDING OR OTHER

CONCRETE SIDEWALK - 7

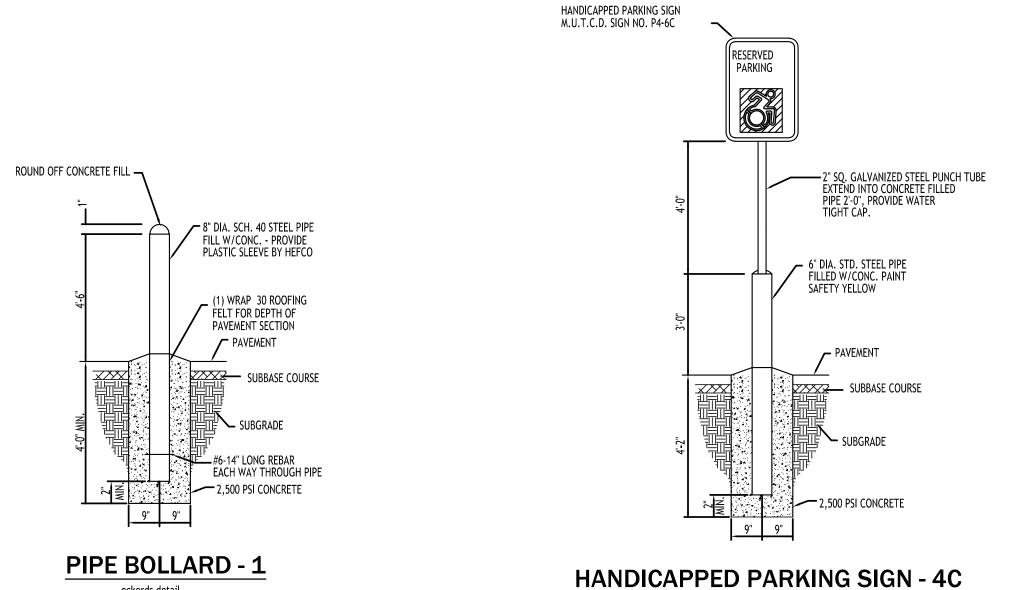

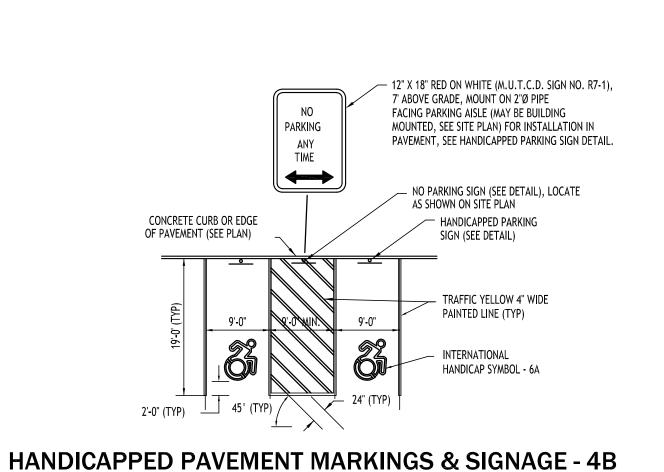

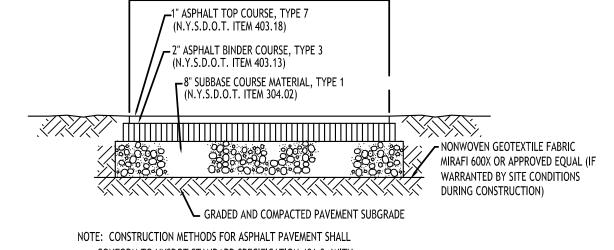

PAVEMENT WIDTH VARIES SEE SITE PLAN

CONFORM TO NYSDOT STANDARD SPECIFICATION 401-3, WITH SUBBASE CONSTRUCTION METHODS CONFORMING TO NYSDOT STANDARD SPECIFICATION 304-3.

STANDARD DUTY ASPHALT SECTION -2

lopme

DRAWING NAME: Site Details

Date: Drawn By: Scale: DRAWING NO.

As Noted

07.08.24

C. Wood

<u>Project No:</u> 23-4107

Date:
Drawn By:
Scale:
DRAWING NO.

C-200

Project No: 23-4107

07.08.24 C. Wood As Noted

PROPOSED WATERLINE PROPOSED CATCH BASIN PROPOSED YARD DRAIN

⊗ YD PROPOSED MANHOLE PROPOSED HYDRANT ASSEMBLY

PROPOSED GATE VALVE

PROPOSED UTILITY LEGEND

PROPOSED STORM SEWER

PROPOSED SANITARY SEWER

NOTE: FOR PROPOSED VALVE BOXES, CLEANOUTS, ETC., INSTALL A 3,000 PSI CONCRETE COLLAR AROUND THE ITEM AT GRADE. THE COLLAR SHALL BE A MINIMUM OF 6" WIDER, ON ALL SIDES, THAN THE BOX, CLEANOUT, ETC. THE COLLAR SHALL BE A MINIMUM OF 6" THICK.

____ ST ____

— 6" SA —

___1" W ____

СВ

DRAWING NAME:

Storm Drainage Plan


Drawn By: Scale: DRAWING NO.

07.08.24 C. Wood

As Noted

<u>Project No:</u> 23-4107

TYPICAL PIPE OUTLET W/ END SECTION & RIP RAP NOT TO SCALE

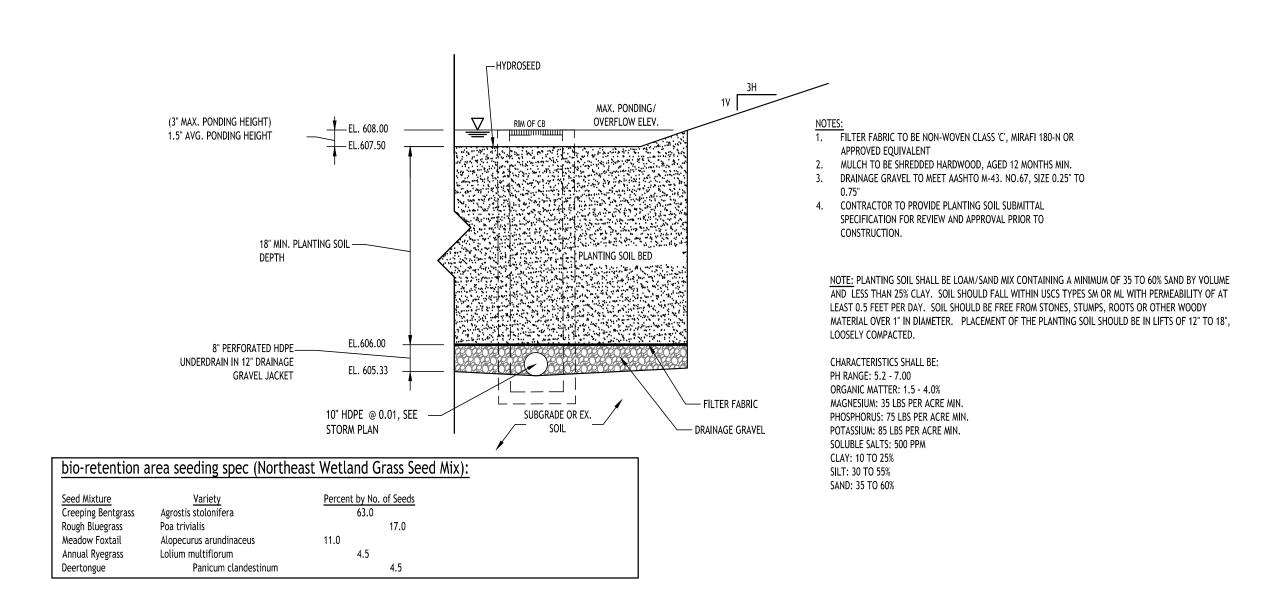

BIORETENTION AREA - TYPICAL SECTION NOT TO SCALE

__6" TOPSOIL (MIN.) TRENCH WIDTH TOP OF PIPE ZONE 1/3 I.D. (12"MAX.)

A. PIPE INSTALLATION SHALL BE IN ACCORDANCE WITH MANUFACTURERS RECOMMENDATIONS.

B. TRENCHING OPERATIONS SHALL INCLUDE ALL NECESSARY DEWATERING.

C. TRENCH DETAILS ARE ONLY SHOWN FOR PURPOSES OF MATERIAL PLACEMENT AND MAXIMUM PAY LIMITS.

D. AN OSHA APPROVED MOVABLE PROTECTIVE TRENCH SHIELD SHALL BE USED IN ALL UNSHEETED TRENCH AREAS.


PIPE BEDDING MATERIAL (NYSDOT 1985 EDITION) (1) NO. 1 CRUSHED STONE OR CRUSHED GRAVEL WITH A GRADATION CONFORMING WITH NYSDOT SECTION 703-02. THE MATERIAL SHALL BE WELL GRADED WITH NO PARTICLES LARGER THAN ONE INCH AND HAVING A MAXIMUM GRADATION MEETING THE LIMITS DESCRIBED IN THE SPECIFICATIONS. THE BEDDING SHALL BE COMPACTED IN 6" LIFTS WITH EQUIPMENT ACCEPTABLE TO THE PIPE MANUFACTURER.

NO SLAG SHALL BE ALLOWED FOR MATERIAL

BACKFILL MATERIAL SHALL BE NATIVE SOIL CONTAINING NO UNSUITABLE MATERIAL COMPACTED IN 6" LIFTS.

STORM SEWER TRENCH SECTION IN UNPAVED AREAS

NOT TO SCALE

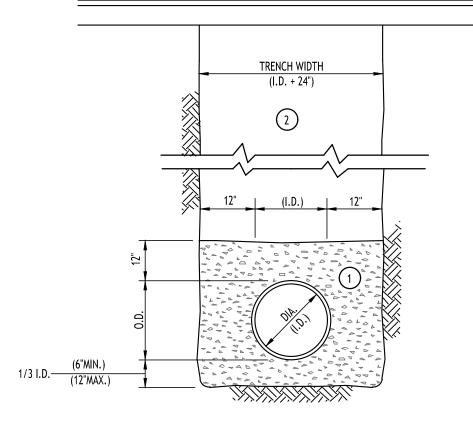

MANUFACTURER.

- A. PIPE INSTALLATION SHALL BE IN ACCORDANCE WITH MANUFACTURERS RECOMMENDATIONS.
- B. TRENCHING OPERATIONS SHALL INCLUDE ALL NECESSARY DEWATERING.
- C. TRENCH DETAILS ARE ONLY SHOWN FOR PURPOSES OF MATERIAL PLACEMENT AND MAXIMUM PAY LIMITS.
- D. AN OSHA APPROVED MOVABLE PROTECTIVE TRENCH SHIELD SHALL BE USED IN ALL UNSHEETED TRENCH AREAS.

<u>MATERIALS</u>

PIPE BEDDING MATERIAL (NYSDOT 1985 EDITION) NO. 1 CRUSHED STONE OR CRUSHED GRAVEL WITH A GRADATION CONFORMING WITH NYSDOT SECTION 703-02. THE MATERIAL


SHALL BE WELL GRADED WITH NO PARTICLES LARGER THAN ONE INCH AND HAVING A MAXIMUM GRADATION MEETING THE LIMITS DESCRIBED IN THE SPECIFICATIONS. THE BEDDING SHALL BE COMPACTED IN 6" LIFTS WITH EQUIPMENT ACCEPTABLE TO THE PIPE MANUFACTURER.

NO SLAG SHALL BE ALLOWED FOR MATERIAL


TYPE 2 CRUSHED STONE OR CRUSHED GRAVEL WITH A GRADATION CONFORMING WITH NYSDOT SECTION 304-2.02 TYPE 2. THE MATERIAL SHALL BE WELL GRADED WITH NO PARTICLES LARGER THAN TWO INCHES AND HAVING A MAXIMUM GRADATION MEETING THE LIMITS DESCRIBED IN THE SPECIFICATIONS. THE BEDDING SHALL BE COMPACTED IN 6" LIFTS WITH EQUIPMENT ACCEPTABLE TO THE PIPE

NO SLAG SHALL BE ALLOWED FOR MATERIAL

STORM SEWER TRENCH SECTION IN PAVED AREAS NOT TO SCALE

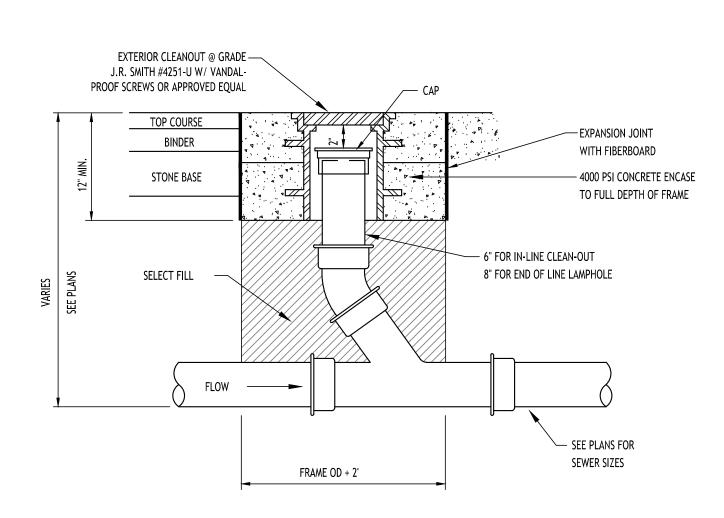



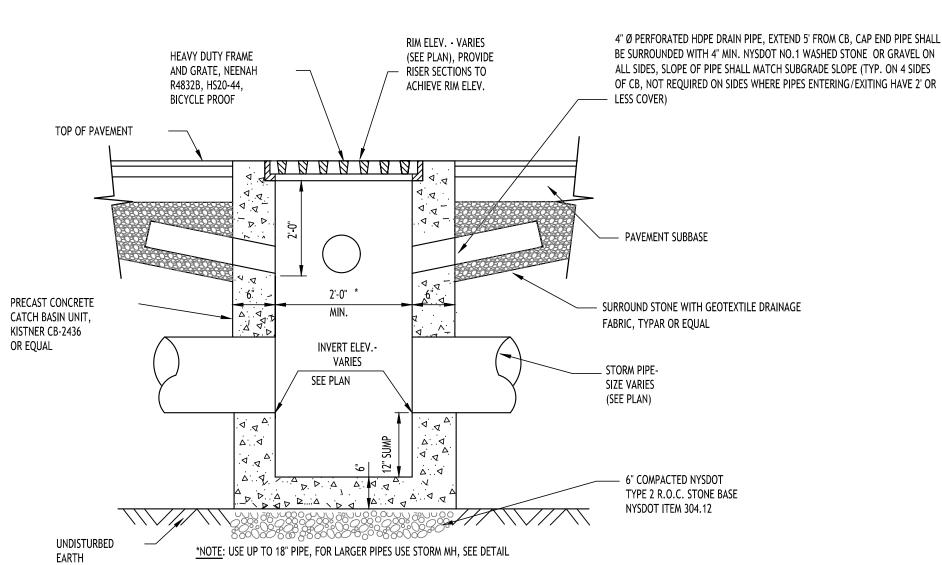

TYPICAL PRECAST CATCH BASIN NOT TO SCALE

Storm Details

Date: Drawn By:

lopme



DRAWING NAME:

07.08.24

As Noted

C. Wood Scale: DRAWING NO.

UTILITY NOTES FOR ALL LAYOUTS:

- 1. UTILITY CONNECTION LOCATIONS SHOWN ARE SCHEMATIC AND SHALL BE COORDINATED WITH UTILITY PLANS, CONNECTION POINTS MAY VARY. COORDINATE WITH M.E.P. AND ARCHITECTURAL PLANS.
- 2. SITE UTILITY CONTRACTOR TO INSTALL SANITARY (TO INCLUDE TRAP & VENT) SERVICE TO WITHIN 5 FEET OF BUILDING, PLUMBING CONTRACTOR TO MAKE CONNECTION AND CONTINUE SERVICE INTERIOR TO THE BUILDING.

UTILITY NOTES:

- 1. CONTRACTOR TO FIELD VERIFY ALL EXISTING STORM AND SANITARY LOCATIONS/INVERTS PRIOR TO CONSTRUCTION. INVERTS SHOWN ARE APPROXIMATE AND BASED ON RECORD DRAWINGS PROVIDED BY ERIE COUNTY DIVISION OF SEWERAGE MANAGEMENT (ECDSM). EXISTING WATER, GAS, ELECTRIC AND SANITARY LINES SHOWN ARE APPROXIMATE. CONTRACTOR TO FIELD VERIFY LOCATION/SIZE/CONDITION BEFORE CONSTRUCTION.
- 2. SELECT BACKFILL IS REQUIRED FOR ALL UTILITIES (GAS, WATER, STORM, SANITARY) THAT CROSS THROUGH PAVEMENT AREAS.
- 3. IF NECESSARY, PROVIDE FITTINGS AND BLOCKING AS NECESSARY AT ALL BENDS IN WATER LINES.
- 4. A MINIMUM OF 10 FEET HORIZONTAL AND 18 INCHES OF VERTICAL SEPARATION MUST BE MAINTAINED BETWEEN ALL SANITARY SEWER AND WATER SERVICES.
- 5. ERIE COUNTY WATER AUTHORITY (ECWA) IS TO BE NOTIFIED A MINIMUM OF 48-HOURS PRIOR TO STARTING THE CONNECTION FOR THE NEW WATER SERVICE.
- 6. ALL SANITARY SEWER CONSTRUCTION SHALL ADHERE TO ECDSM SPECIFICATIONS AND DETAILS, AND ERIE COUNTY DEPARTMENT OF HEALTH RULES AND REGULATIONS.
- 7. ALL OTHER REQUIRED PERMITS BY THE STATE OF NEW YORK, ERIE COUNTY, OR TOWN OF WEST SENECA ARE THE RESPONSIBILITY OF THE CONTRACTOR.
- 8. CONSTRUCTION IS TO CONFORM TO ECDSM RULES AND REGULATIONS.
- 9. ECDSM REQUIRES PROPER TESTING (DEFLECTION, HYDROSTATIC & AIR) BEFORE ACTIVATION OF THE 8" SEWER.
- 10. THE ERIE COUNTY WATER AUTHORITY (ECWA) IS TO BE NOTIFIED A MINIMUM OF 48-HOURS PRIOR TO STARTING THE CONNECTION FOR THE NEW WATER SERVICE.

11. FOR LIGHTING ELECTRICAL POWER, SITE CONTRACTOR IS RESPONSIBLE FOR EXCAVATION AND BACKFILL. ELECTRICAL CONTRACTOR IS RESPONSIBLE FOR LAYING CONDUIT.

PROPOSED GATE VALVE

PROPOSED UTILITY LEGEND PROPOSED STORM SEWER PROPOSED SANITARY SEWER — 6"SA — — 1"W — PROPOSED WATERLINE PROPOSED GAS (G), ELECTRIC (E), CABLE (C), & TELEPHONE (T) PROPOSED CATCH BASIN PROPOSED YARD DRAIN YD PROPOSED MANHOLE PROPOSED HYDRANT ASSEMBLY

NOTE: FOR PROPOSED VALVE BOXES, CLEANOUTS, ETC., INSTALL A 3000 PSI CONCRETE COLLAR AROUND THE ITEM AT GRADE. THE COLLAR SHALL BE A MIN. OF 6" WIDER, ON ALL SIDES, THAN THE BOX, CLEANOUT, ETC. THE COLLAR SHALL BE A MIN. OF 6" THICK.

NOTE: BOUNDARY AND TOPOGRAPHIC INFORMATION PROVIDED BY OTHERS, CARMINA WOOD DESIGN ASSUMES NO RESPONSIBILITY FOR ITS ACCURACY.

Drawn By: Scale:

DRAWING NO.

DRAWING NAME:

Utility Plan

lopme

07.08.24 C. Wood

As Noted


07.08.24

C. Wood


As Noted

Scale: DRAWING NO.

NOTE: ALL MATERIAL TO CONFORM TO LATEST A.W.W.A. SPECIFICATIONS — CAST IRON CURB BOX NOTE: SEE UTILITY PLANS FOR SERVICE SIZES SPEC 10-5D OR EQUAL STANDARD BRONZE CORPORATION— STOP-MUELLER H-15000 OR EQUAL STANDARD BRONZE CURB STOP MUELLER H-15204 OR WATERMAIN CONNECTING PIPE TYPE "K" COPPER TUBING TO COPPER TUBE 5'-0" MIN. BLOCK DEPTH FOR P.V.C. PIPE USE BRASS _ SADDLE FORD NO. FR202 OR TYPICAL WATER SERVICE LINE INSTALLATION

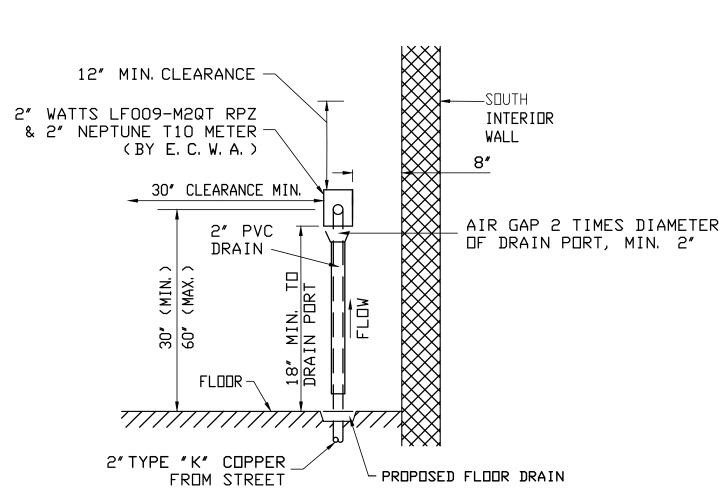


EAST ELEVATION

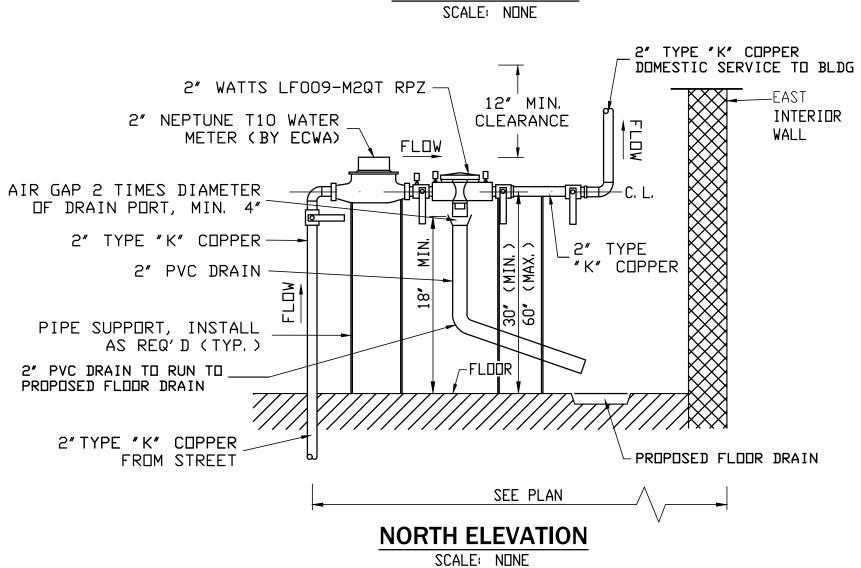

2" DOMESTIC SERVICE BACKFLOW PREVENTER INSTALLATION

NOTES:


1. NO TAPS TO BE MADE UPSTREAM OF RPZ & METER. 2. HEAT, LIGHT AND ELECTRIC TO BE PROVIDED AT RPZ LOCATION. 3. COORDINATE LOCATION WITH ARCHITECTURAL PLANS.

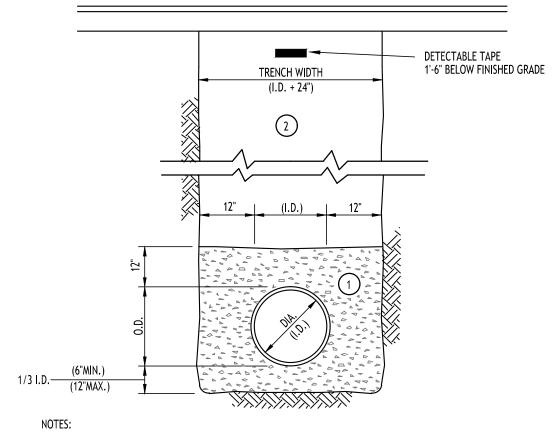

- A. PIPE INSTALLATION SHALL BE IN ACCORDANCE WITH MANUFACTURERS RECOMMENDATIONS.
- B. TRENCHING OPERATIONS SHALL INCLUDE ALL NECESSARY DEWATERING. C. TRENCH DETAILS ARE ONLY SHOWN FOR PURPOSES OF MATERIAL PLACEMENT AND MAXIMUM PAY LIMITS.
- D. AN OSHA APPROVED MOVABLE PROTECTIVE TRENCH SHIELD SHALL BE USED IN ALL UNSHEETED TRENCH AREAS.

- PIPE BEDDING MATERIAL (NYSDOT 1985 EDITION) 1) NO. 1 CRUSHED STONE OR CRUSHED GRAVEL WITH A GRADATION CONFORMING WITH NYSDOT SECTION 703-02. THE MATERIAL SHALL BE WELL GRADED WITH NO PARTICLES LARGER THAN ONE INCH AND HAVING A MAXIMUM GRADATION MEETING THE LIMITS DESCRIBED IN THE SPECIFICATIONS. THE BEDDING SHALL BE COMPACTED IN 6" LIFTS WITH EQUIPMENT ACCEPTABLE TO THE PIPE MANUFACTURER.
- NO SLAG SHALL BE ALLOWED FOR MATERIAL TYPE 2 CRUSHED STONE OR CRUSHED GRAVEL WITH A GRADATION CONFORMING WITH NYSDOT SECTION 304-2.02 TYPE 2. THE MATERIAL SHALL BE WELL GRADED WITH NO PARTICLES LARGER THAN TWO INCHES AND HAVING A MAXIMUM GRADATION MEETING THE LIMITS DESCRIBED IN THE SPECIFICATIONS. THE BEDDING SHALL BE COMPACTED IN 6" LIFTS WITH EQUIPMENT ACCEPTABLE TO THE PIPE MANUFACTURER.

NO SLAG SHALL BE ALLOWED FOR MATERIAL SEWER/WATERLINE TRENCH SECTION IN PAVED AREAS NOT TO SCALE

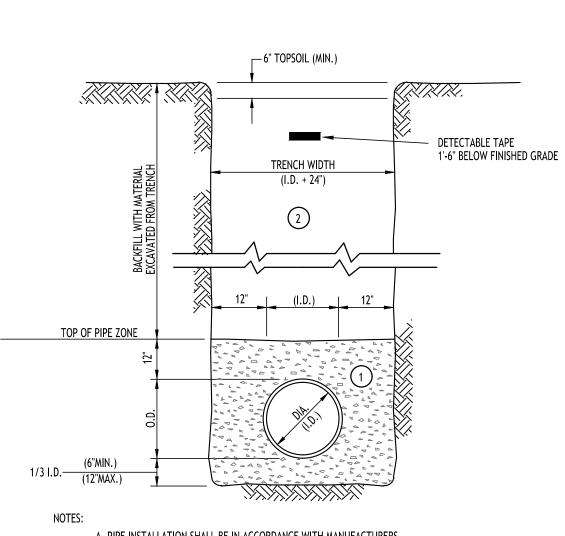

A. PIPE INSTALLATION SHALL BE IN ACCORDANCE WITH MANUFACTURERS RECOMMENDATIONS. B. TRENCHING OPERATIONS SHALL INCLUDE ALL NECESSARY DEWATERING. C. TRENCH DETAILS ARE ONLY SHOWN FOR PURPOSES OF MATERIAL PLACEMENT AND MAXIMUM PAY LIMITS.

D. AN OSHA APPROVED MOVABLE PROTECTIVE TRENCH SHIELD SHALL

BE USED IN ALL UNSHEETED TRENCH AREAS.

NOT TO SCALE

PIPE BEDDING MATERIAL (NYSDOT 1985 EDITION) (1) NO. 1 CRUSHED STONE OR CRUSHED GRAVEL WITH A GRADATION CONFORMING WITH NYSDOT SECTION 703-02. THE MATERIAL SHALL BE WELL GRADED WITH NO PARTICLES LARGER THAN ONE INCH AND HAVING A MAXIMUM GRADATION MEETING THE LIMITS DESCRIBED IN THE SPECIFICATIONS. THE BEDDING SHALL BE COMPACTED IN 6" LIFTS WITH EQUIPMENT ACCEPTABLE TO THE PIPE MANUFACTURER. NO SLAG SHALL BE ALLOWED FOR MATERIAL

(2) BACKFILL MATERIAL SHALL BE NATIVE SOIL CONTAINING NO UNSUITABLE MATERIAL COMPACTED IN 6" LIFTS. SEWER/WATERLINE TRENCH SECTION IN UNPAVED AREAS

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~ P O N D ~

PLANTING SCHEDULE - 5226 & 5228 MAINSTREET - AMHERST - NEW YORK

PLANTI	ING SCH	IEDULE - 5226 & 5228 MAINSTREET -/	AMHERST - NEW YORK		
KEY	QTY.	BOTANICAL NAME	COMMON NAME	MIN. SIZE	REMARKS
		DECIDUOUS TREES			
AF	3	ACER FREEMANII "JEFFERSRED"	AUTUMN BLAZE MAPLE	2 1/2" - 3" CAL.	B&B
QR	4	QUERCUS RUBRA	NORTHERN RED OAK	2 1/2" - 3" CAL.	B&B
GT	6	GLEDITSIA TRIACANTHOS INERMIS "SKYCOLE"	SKYLINE THORNLESS HONEYLOCUST	2 1/2" - 3" CAL.	B&B, HT. OF 45' & 45' WIDE
QM	3	QUERCUS MACROCARPA	BUR OAK	2 1/2" - 3" CAL.	B&B, HT. OF 45' & 45' WIDE
AR	1	ACER RUBRUM	RED MAPLE	2 1/2" - 3" CAL.	B&B, HT. OF 45' & 45' WIDE
		SMALL/ORNAMENTAL TREES			
SR	2	SYRINGA RETICULATA	JAPANESE TREE LILAC	7' – 8' HT.	B&B
CC	3	CERCIS CANADENSIS	EASTERN REDBUD	7' – 8' HT.	B&B
		EVERGREEN TREES			
PAf	7	PICEA ABIES "Cupressina"	COLUMNAR NORWAY SPRUCE	5' - 6' MIN. HT.	B&B, FULL TO GROUND
то	6	THUJA OCCIDENTALIS	EMERALD GREEN ARBORVITAE	5' – 6' MIN. HT.	B&B, FULL TO GROUND
AC	1	ABIES CONCOLOR	CONCOLOR FIR	5' – 6' MIN. HT.	B&B, FULL TO GROUND
٧	19	JUNIPERUS VIRGINIANA	ESTERN RED CEDAR	5' – 6' MIN. HT.	B&B, FULL TO GROUND
		SHRUBS			
HQ	9	HYDRANGEA QUERCIFOLIA	OAKLEAF HYDRANGEA	32" HIGH MIN.	NO. 3 CONT.
RP	6	RHODODENDRON x 'PJM'	P.J.M. RHODODENDRON	24" HIGH MIN.	NO. 3 CONT.
RD	21	CORNUS ALBA "SIBERICA"	SIBERIAN DOGWOOD	32" HIGH MIN.	NO. 3 CONT.
cs	39	CORNUS SERICEA	REDOSIER DOGWOOD	32" HIGH MIN.	NO. 3 CONT.

- 1. ALL PLANTING BEDS & TREE PITS SHALL RECEIVE A MIN. 3-INCH DEPTH OF DARK SHREDDED HARDWOOD BARK MULCH, UNLESS OTHERWISE CALLED OUT ON PLANS.
- 2. ALL PLANT MATERIALS SHALL BE INSPECTED TWICE ANNUALLY, ONCE IN THE SPRING AND AGAIN IN THE FALL. TREES & SHRUBS THAT ARE DEAD OR ARE IN POOR CONDITION/DISEASED (LESS THAN 50% LEAF COVER) SHALL BE REPLACED BEFORE THE NEXT GROWING SEASON. TREES AND SHRUBS THAT DO NOT EXHIBIT THE CONDITIONS FOR REPLACEMENT SHALL BE PRUNED AT THE TIME OF INSPECTION TO REMOVE DEAD TWIGS & BRANCHES.
- 3. ALL NURSERY TAGS TO REMAIN ON PLANTS UNTIL AFTER FINAL INSPECTION AND APPROVAL OF THE LANDSCAPING.
- 4. A DRIP IRRIGATION SYSTEM IS RECOMMENDED FOR ALL PLANTINGS. SOAKER HOSES ARE RECOMMENDED AT THE TIME OF INSTALLATION OF ALL PLANT MATERIALS AND SHOULD BE UTILIZED THROUGHOUT THE ENTIRE LENGTH OF THE FIRST FULL GROWING SEASON.

* ORNAMENTAL GRASSES SHOULD BE PRUNED BACK IN LATE FALL OR EARLY SPRING TO ALLOW NEW FOLIAGE TO GROW IN SPRING.

PLANTING NOTES:

- 1. ALL INTERIOR LANDSCAPED AREAS SHALL HAVE A MINIMUM PLANTING SOIL DEPTH OF THREE (3) FEET AND BE FREE FROM ALL FORMS OF CONSTRUCTION DEBRIS AND FOREIGN MATERIAL.
- 2. ALL TREE PIT SAUCERS, SHRUB BEDS, ORNAMENTAL GRASS BEDS, AND PERENNIAL FLOWER BEDS SHALL RECEIVE THREE (3) INCHES DEPTH OF DARK SHREDDED HARDWOOD BARK MULCH.
- 3. ALL SEASONAL FLOWER BEDS SHALL BE A MINIMUM OF TWELVE (12) INCHES DEEP WITH A WELL-BLENDED MIXTURE OF 50% PEAT MOSS & 50% SCREENED TOPSOIL. NO MULCH SHALL BE INSTALLED IN THE SEASONAL FLOWER BEDS.

4. ALL DECIDUOUS AND EVERGREEN TREES SHALL BE STAKED WITH THREE (3) TREE STAKES AS PER TREE PLANTING DETAIL.

<u>LEGEND</u> DECIDUOUS TREE SMALL TREE

BUSH/ORNAMENTAL GRASS

NOTE: BOUNDARY AND TOPOGRAPHIC INFORMATION PROVIDED BY OTHERS, CARMINA WOOD DESIGN ASSUMES NO RESPONSIBILITY FOR ITS ACCURACY.



elopmer

PRELIMINARY NOT FOR CONSTRUCTION


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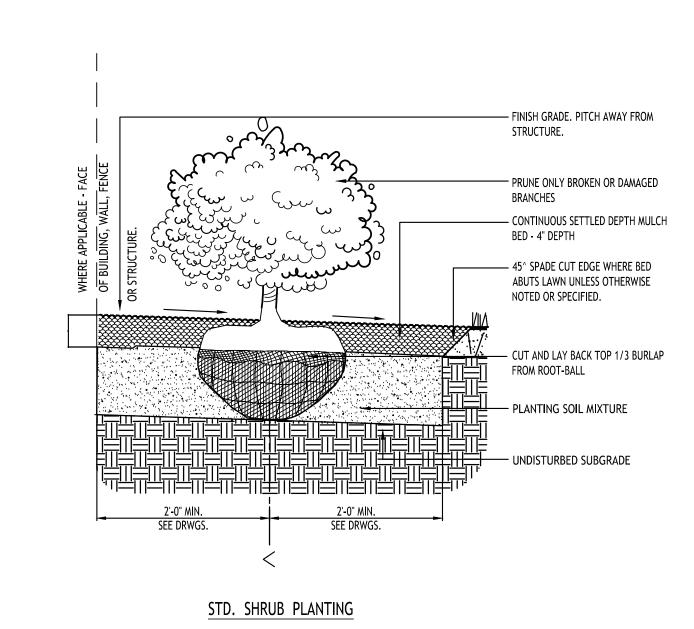
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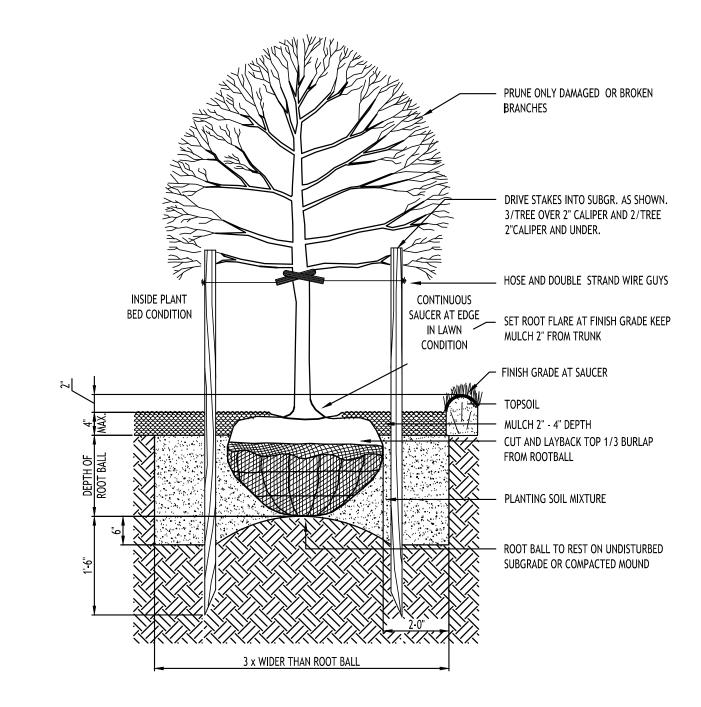
Concept

DRAWING NO.

07.08.24 C. Wood As Noted





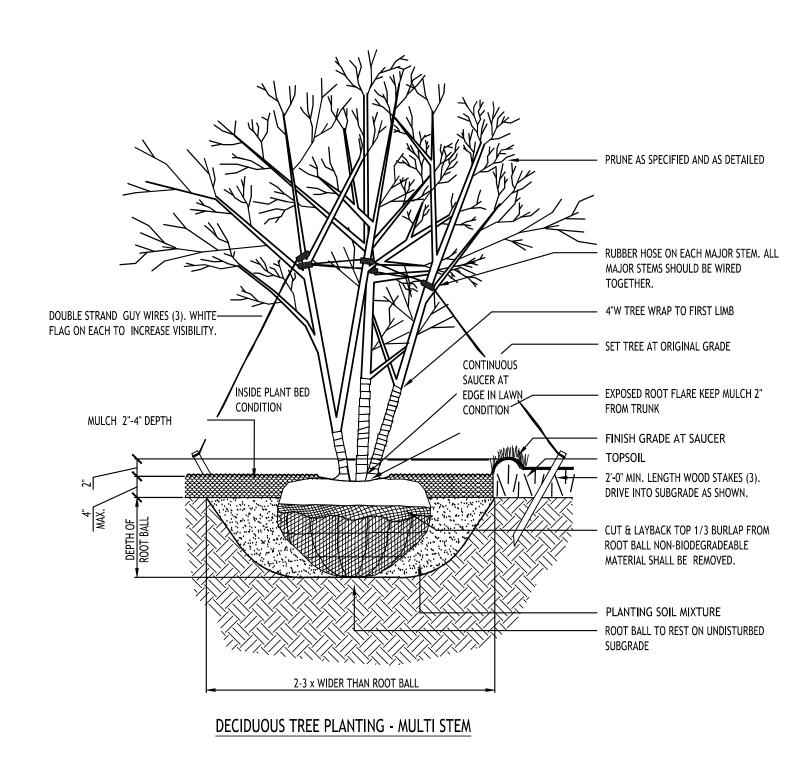



STD. DECIDUOUS TREET PLANTING

LANDSCAPE NOTES:

- 1. ALL PLANTS INSTALLED SHALL MEET OR EXCEED THE MINIMUM REQUIREMENTS AS NOTED ON THE PLANS AND IN THE LATEST EDITION ON THE AMERICAN STANDARD FOR NURSERY STOCK, BY THE AMERICAN ASSOCIATION OF NURSERYMEN, ANSI 260.1
- 2. THE CONTRACTOR SHALL BE RESPONSIBLE FOR HIS OWN QUANTITY TAKEOFF, THE QUANTITIES SHOWN ARE A MINIMUM AND ARE FOR REFERENCE ONLY.
- 3. THE CONTRACTOR SHALL PERFORM A ROUGH FIELD STAKEOUT OF ALL PLANTING MATERIAL LOCATIONS AND CONTACT THE OWNERS FIELD REPRESENTATIVE PRIOR TO ACTUALL INSTALLING. THE PLANTING MATERIAL LOCATIONS SHOWN ON THE PLANS ARE TO CONVEY THE DESIGN INTENT ONLY, ACTUAL LOCATIONS WILL BE FINALIZED BY THE OWNERS FIELD REPRESENTATIVE AT THE TIME OF INSTALLATION.
- 4. THE CONTRACTOR IS HEREBY NOTIFIED THAT IF UNDERGROUND UTILITIES EXIST IN THE VICINITY OF THE PLANTINGS, ALL PROPOSED PLANTINGS SHALL BE INSTALLED A MINIMUM OF 5' FROM ANY UNDERGROUND UTILITY, CONTACT THE OWNERS FIELD REPRESENTATIVE IF PLANTINGS SHOWN ON THE PLANS VIOLATE THIS SITUATION.
- 5. ALL TREES SHALL BE INSTALLED A MINIMUM OF 20' FROM ANY OVERHEAD ELECTRIC LINES.
- 6. PLANTING BACKFILL MIXTURE SHALL CONSIST OF 3 PARTS TOPSOIL, 1 PART PEAT MOSS, ⅓ PART MILORGANITE.
- 7. STAKE TREES IMMEDIATELY FOLLOWING INSTALLATION.
- 8. ALL PLANTED AREAS SHALL RECEIVE A 3" LAYER OF SHREDDED HARDWOOD BARK MULCH WITH "PREEN".
- 9. ALL DISTURBED AREAS NOT RECEIVING PLANTINGS (INCLUDING RIGHT-OF-WAYS) SHALL BE SEEDED.

- 10. THE AREAS ON THE PLAN TO BE SEEDED SHALL HAVE 4" MINIMUM OF TOPSOIL, DISK PLOWED, LEVELED AND HAND RAKED SMOOTH. SURFACE SHALL BE ROLLED TO REMOVE LUMPS.
- 11. ALL SEEDED AREAS SHALL BE HYDROSEEDED IN ACCORDANCE WITH THE SPECIFICATION INDICATED. WHERE REQUIRED BY CLIMATIC CONDITIONS, SLOPE OR SEASON OF PLANTING, SOD MAY BE SUBSTITUTED FOR SEEDING IN ORDER TO ACHIEVE THE REQUIRED COVERAGE
- 12. THE CONTRACTOR SHALL BE RESPONSIBLE FOR WATERING, MOWING AND OTHER MAINTENANCE TO SEEDED AREAS UNTIL THE PROJECT IS ACCEPTED BY THE OWNER, THIS SHALL INCLUDE WATERING DAILY FOR 15 DAYS OR AS REQUIRED BY WEATHER CONDITIONS AND RE-SEEDING OF THIN SPOTS FOLLOWING THE GERMINATION OF THE SEEDS.

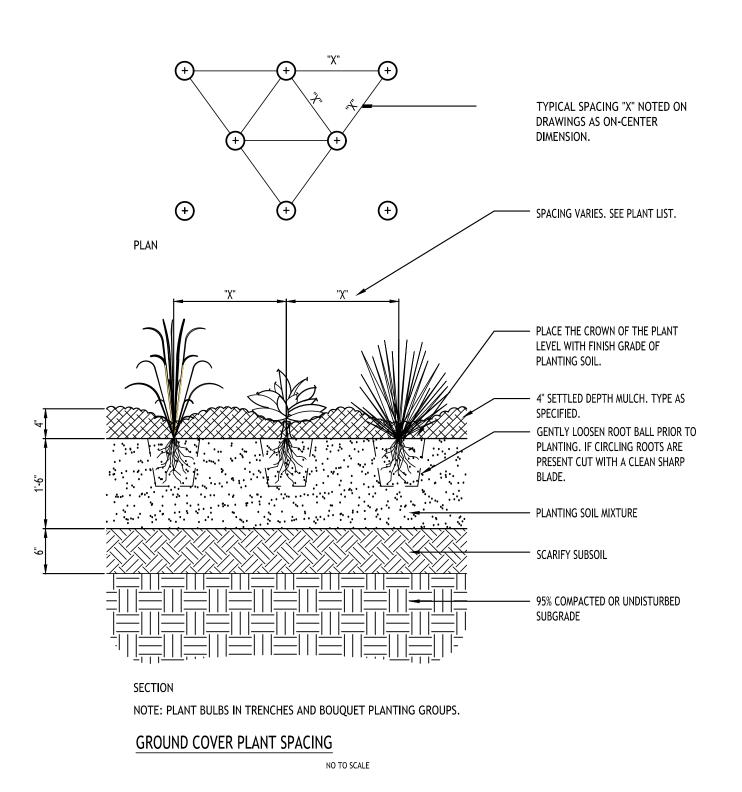

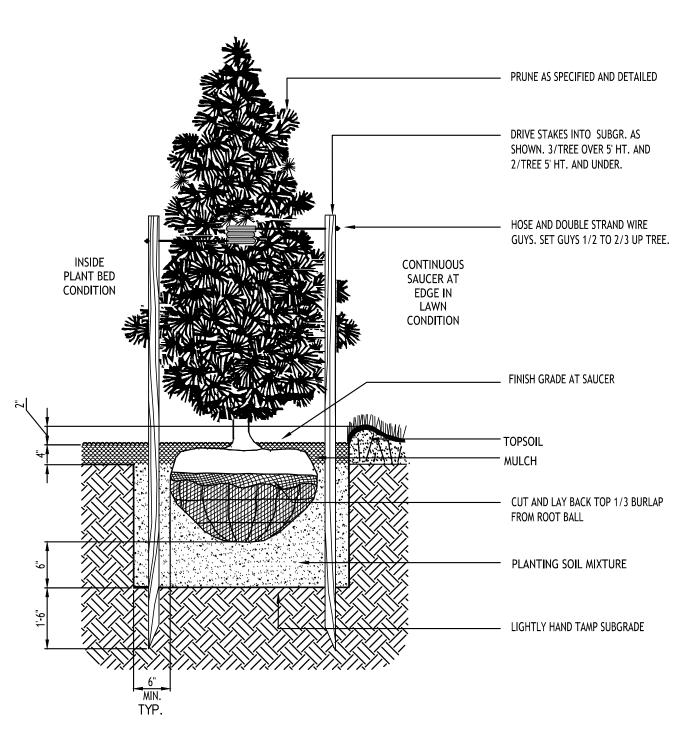

STD. EVERGREEN PLANTING

SARMINAWOC

nercial Development

No. Description

DRAWING NAME:
Site Landscape
Concept

Date:
Drawn By:
Scale:
DRAWING NO.

07.08.24 C. Wood

As Noted

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<u>Project No:</u> 23-4107

