## BARCLAY DAMON

RECEIVED

Ari M. Goldberg Counsel

AUG 22 2024

August 22, 2024

**ZONING OFFICE** 

## VIA HAND DELIVERY VIA ELECTRONIC MAIL

Town of Clarence
Zoning Board of Appeals
c/o Andrew Schaefer, Town Planning Department
1 Town Place
Clarence, NY 14031
ASchaefer@clarence.ny.us

Re:

Request for Action - Area Variance Application

James Ryan Parkway & County Road

Mattina Development LLC

Dear Chairman Mills and Members of the Zoning Board of Appeals:

Barclay Damon LLP represents Mattina Development, LLC ("Applicant") with respect to its proposed retail plaza ("Development") at the southeast corner of County Road and James Ryan Parkway, SBL 44.00-1-55 ("Property"). The Property is zoned I – Industrial where the proposed use is permitted.

The Planning Board conducted a coordinated review pursuant to the State Environmental Quality Review Act (SEQRA) and granted a Negative Declaration at its July 31, 2024 meeting.

The Development requires an area variance because parking is located in the front yard setback along James Ryan Parkway.

Enclosed, please find the following:

- 1. Request for Action | Area Variance Application Form
- 2. Site Plan
- 3. Architectural Elevations
- 4. Area Variance Analysis
- 5. Evidence of Neighbor Notification

Mattina | James Ryan Parkway & County – Revised Concept Plan August 22, 2024 Page 2

We look forward to discuss this variance request with the Zoning Board at its September 10, 2024 meeting. Please reach out with any questions. Thank you for your consideration.


Very truly yours,


a. M. Lully Ari M. Goldberg

AMG: Enclosures

cc: Chris Wood, Carmina Wood Design

Mattina Development, LLC

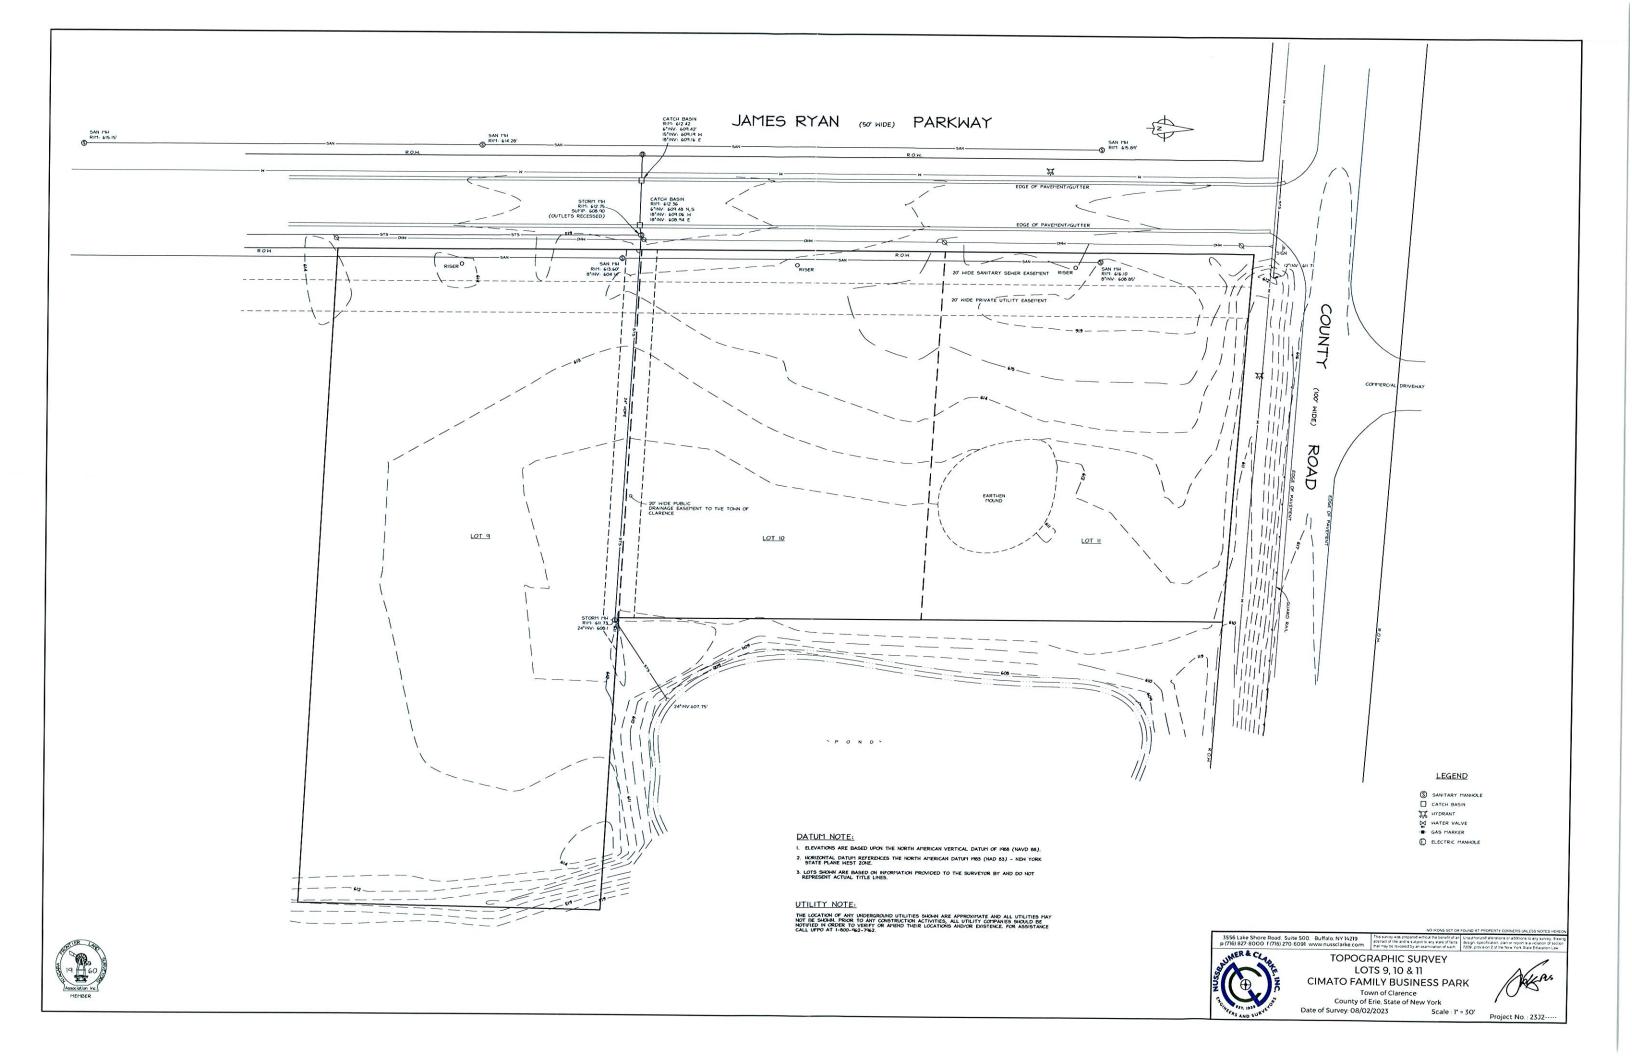

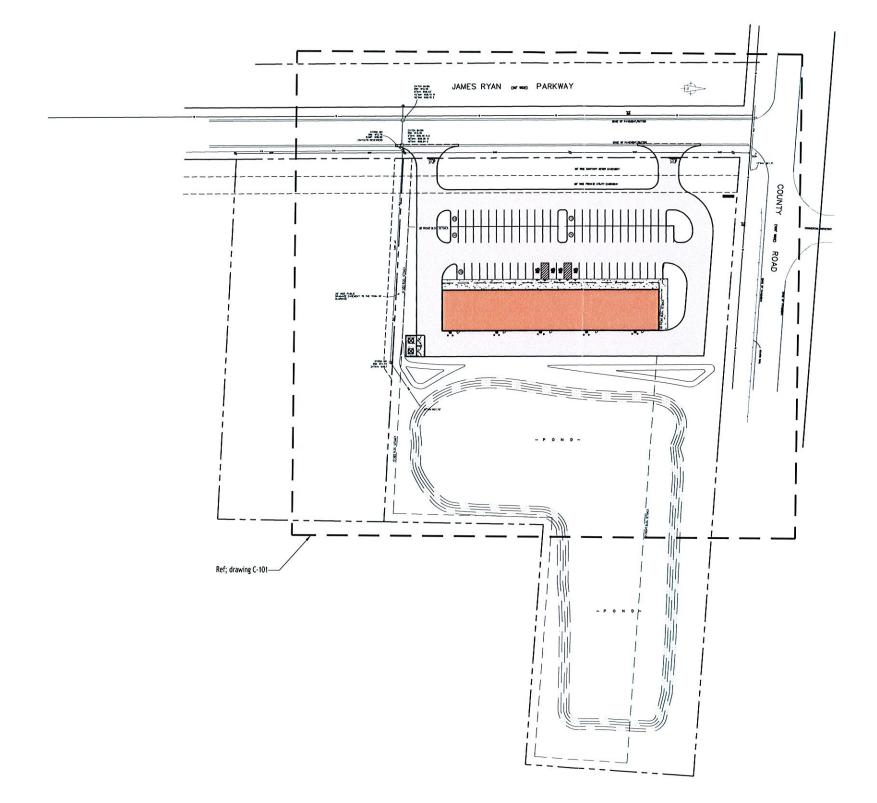

N	Overall Site Plan
<b>9</b>	SCALE: 1"=50" (Ref; C-101 & C-102 for site plan and details)

ITE LEGEND	
ROPERTY LINE	
ROPOSED CONCRETE CURB	
ROPOSED SIDEWALK / CONCRETE PAD	.4
JAMBER OF PARKING SPACES	$\overline{y}$
ROPOSED SIGN	•
OPOSED STANDARD DUTY PHALT PAVEMENT	
OPOSED LIGHT POLE	·ķ.
OPOSED WALL MOUNTED LIGHT	-1ŠI-



## CARMINAWOOD DESIGN Buffalo | Utica | Greensboro

Commercial Development
James Ryan Pkwy @ County Rd
Clarence, New York

PRELIMINARY
NOT FOR CONSTRUCTION


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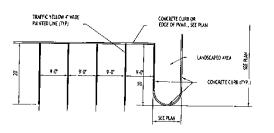
Overall Site Plan

Date: Orawn By: Scale: DRAWING NO.


C. Wood As Noted

C-100
Project No: 23-4107



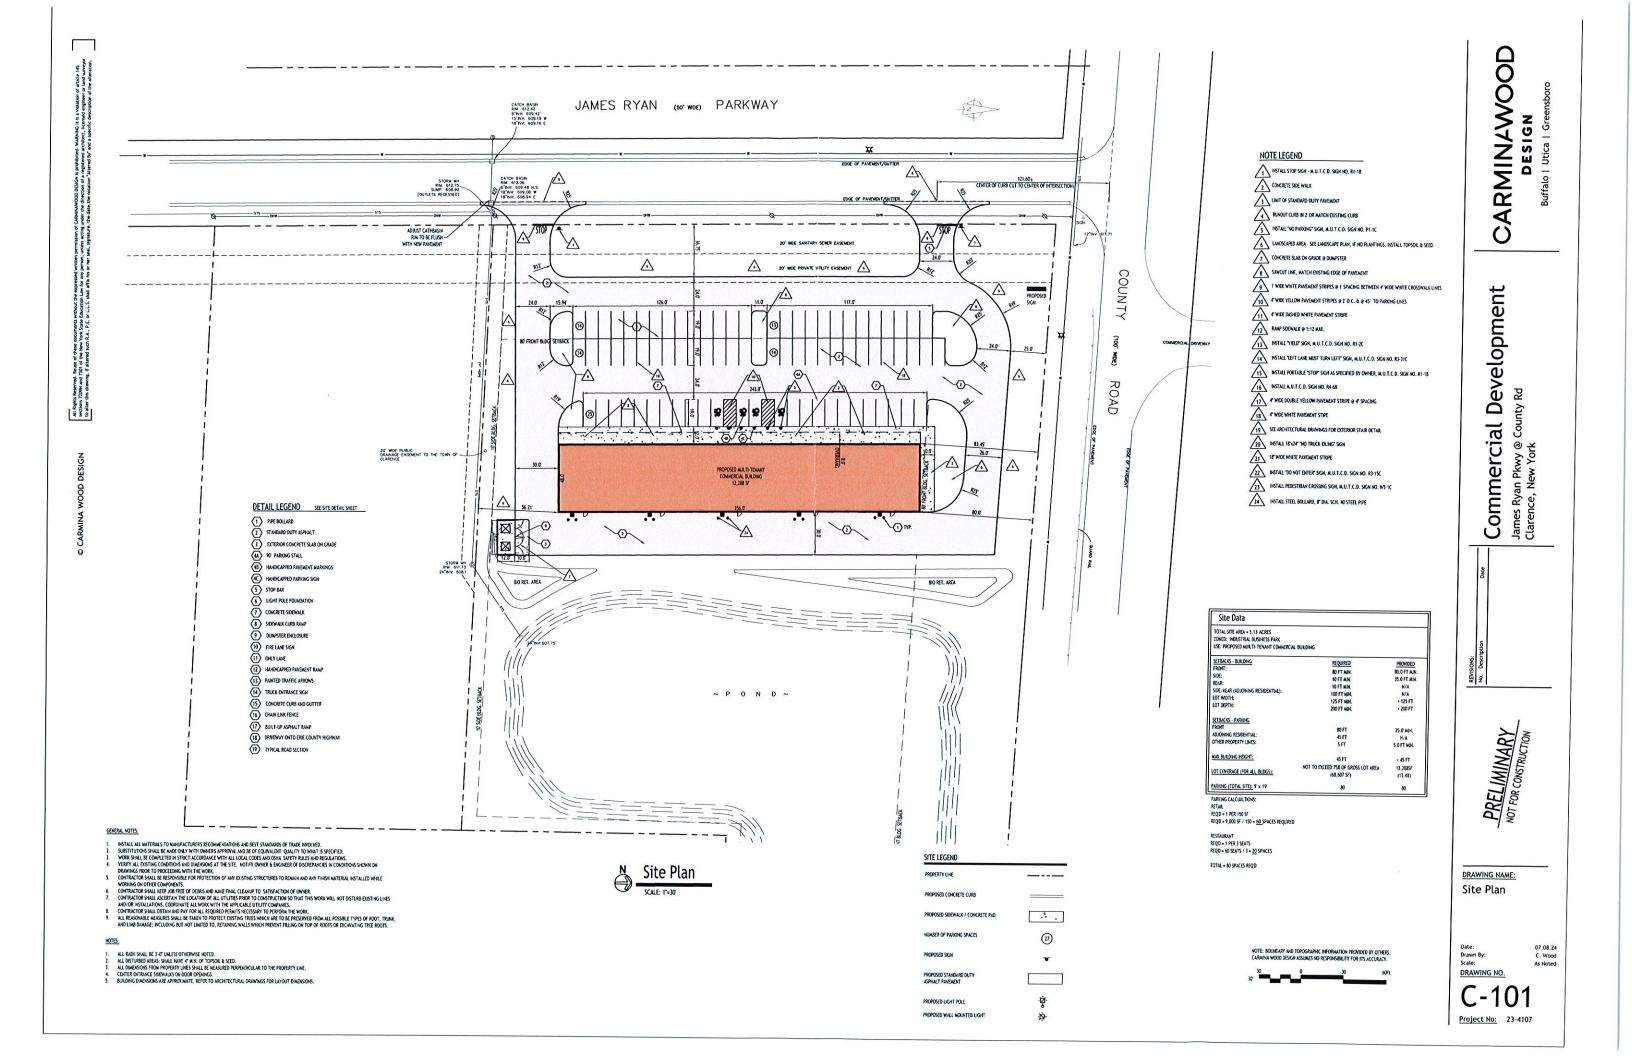



90° PARKING STALL LAYOUT - 4A

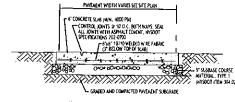


NOTE: CONCRETE PAYEMENT MATERIAL SHALL CONFORM TO MYSDO STANDARD SPECIFICATION SOLAND CONSTRUCTION METHODS SHALL CONFORM TO MYSDOT STANDARD SPECIFICATION 502-1

**EXTERIOR CONCRETE** SLAB-ON-GRADE SECTION - 3

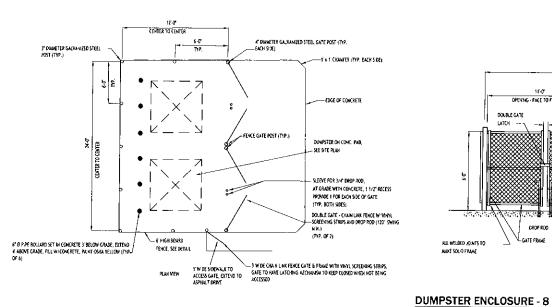

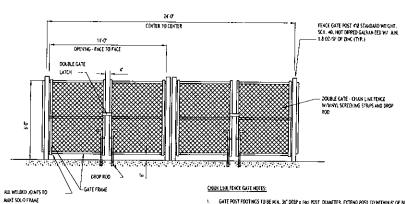


- GATE POST FOOTINGS TO BE AUN. 36" DEEP x Fax POST. DIAMETER, EXTEND POST TO WITHIN 6" OF BOTTON.
- GATE FRAMES TO BE 2' SQ. GALMANIZED STEEL, WEIGHING 2.60 LB. FT IN ACCORDANCE WITH ASTM F 900
- CHAIN LINA FENCE FARRIC SHALL BE 2" MESH, 9 GAINGE, ZINC COATED STEEL COPE WIFE. INSTALL MESH WITH HOOK BOLTS AND TENSION BARS ON ALL 4 SIDES, ATTACH AT 15" MAX.
- 4. DOUBLE GATE LATON TO BE FORKED TYPE CAPABLE OF RETAINING GATE IN CLOSED POSITION AND HAVE PROVISION FOR PAD LOCK, LATCH SHALL BE OPERABLE FROM EITHER SDE OF GATE.
- 5. ALL HARDWARE TO BE HOT DIPPED GALVANIZED STEEL TO SUIT GATE SIZE.

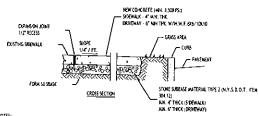


- NOTES:
  1. CONTROL JOHTS TO BE AT 5-07 D.C., BOTH WAYS WHERE APPLICABLE, SEE SPECIFICATIONS FOR PURITHER JOHT REQUIREMENTS 495007 102-0700.
- CONCRETE SIDEWALK AND DRINEWAY MATERIAL SHALL CONFORM TO NYSOOT STANDARD SPECIFICATION SOLID CONTRACTION METHODS SHALL CONFORM. TO NYSOOT STANDARD SPECIFICATION 68-1.
- Subbase grade shall follow the proposed grade of the sidewalk and slope away from building where applicable, provide continuous stone path to curb underdrain where provided.
- FULL DEPTH DEPAISION JOINTS SHALL BE INSTALLED EVERY 27 O.C., BOTHWAYS WHERE APPLICABLE. SEE SPECIFICATIONS FOR FURTHER JOINT REQUIREMENTS INSOOT 707-0700.
- 5. SEE CURB DETAIL FOR DOWLING REQUIREMENTS WHERE ABUTTING CURB,
- b. INSTALLE" LONG 19 DOWELS © 12" O.C. WHERE SCENALK ABUTS A SULDING WALL AT AN DITRAKE, THICKEN SCENALK TO A TERLADMO WALL AND INSTALL DOME, CONTRED IN THE 6" EPPTH. DOWELS AND THICKENING OF SCENALK SPALL DITRIBO IS THERE SING OF ATMIXACE.
- INSTALL 1-2' PREMICLED EXPANSION JOINT WITH BACKER ROO & SEALANT WHERE SIDEWALK ABUITS BUILDING OR OTHER STRUCTURE.


## **CONCRETE SIDEWALK - 7**

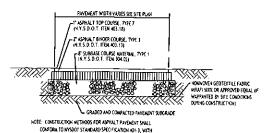


NOTE: CONSTRUCTION WETHOOS FOR ASPIALT PAYEMENT SHALL CONFORM TO INSOOT STAMBARD SPECIFICATION 491-1, WITH SUBBASE CONSTRUCTION METHOOS CONFORMING TO INSOOT STANDARD SPECIF CATTON 304-3.

STANDARD DUTY ASPHALT SECTION -2

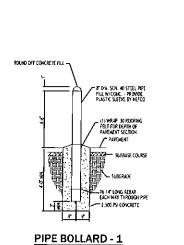

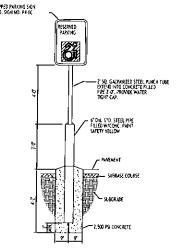



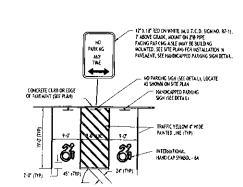

HANDICAPPED PAVEMENT MARKINGS & SIGNAGE - 4B

Date: Drawn By: Scale:

<u>Project No:</u> 23-4107

**ARMINAWOOD** DESIGN O


**Commercial Development** James Ryan Pkwy @ County Rd Clarence, New York

PRELIMINARY NOT FOR CONSTRUCTION

DRAWING NAME: Site Details

DRAWING NO.

C-102

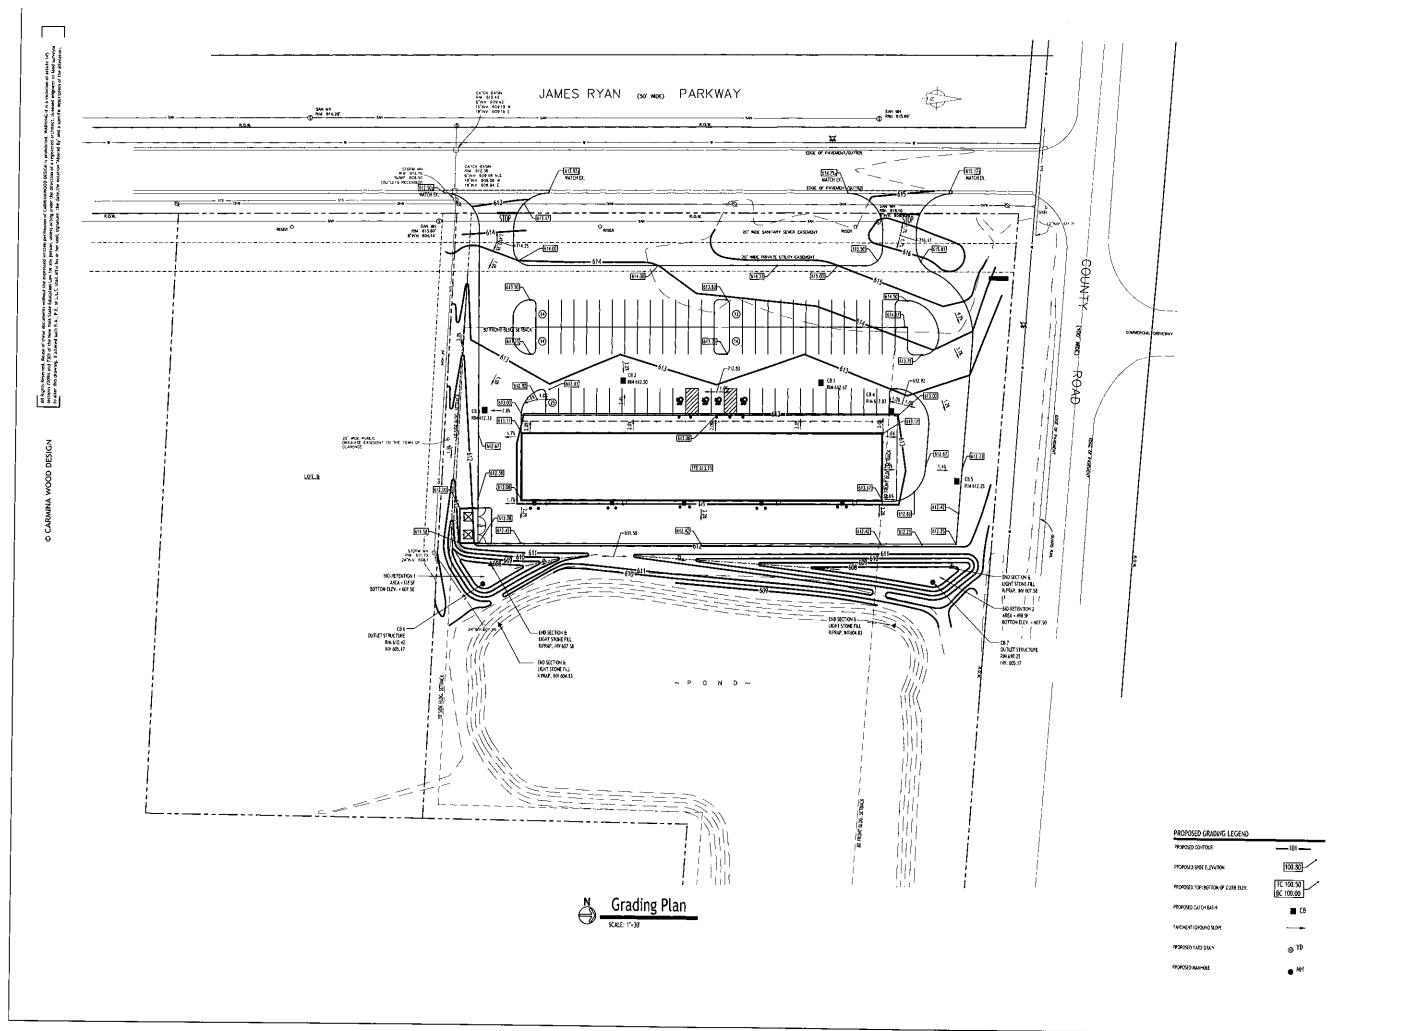

CARMINAWOOD

DESIGN

Buffalo | Utica | Greensboro

Commercial Development James Ryan Pkwy @ County Rd Clarence, New York

COM!
James Ry:
Clarence,


PRELIMINARY NOT FOR CONSTRUCTION

DRAWING NAME: Grading Plan

Date: Orawn By: Scale: DRAWING NO.

C-200
Project No: 23-4107

07.08.24 C. Wood As Noted

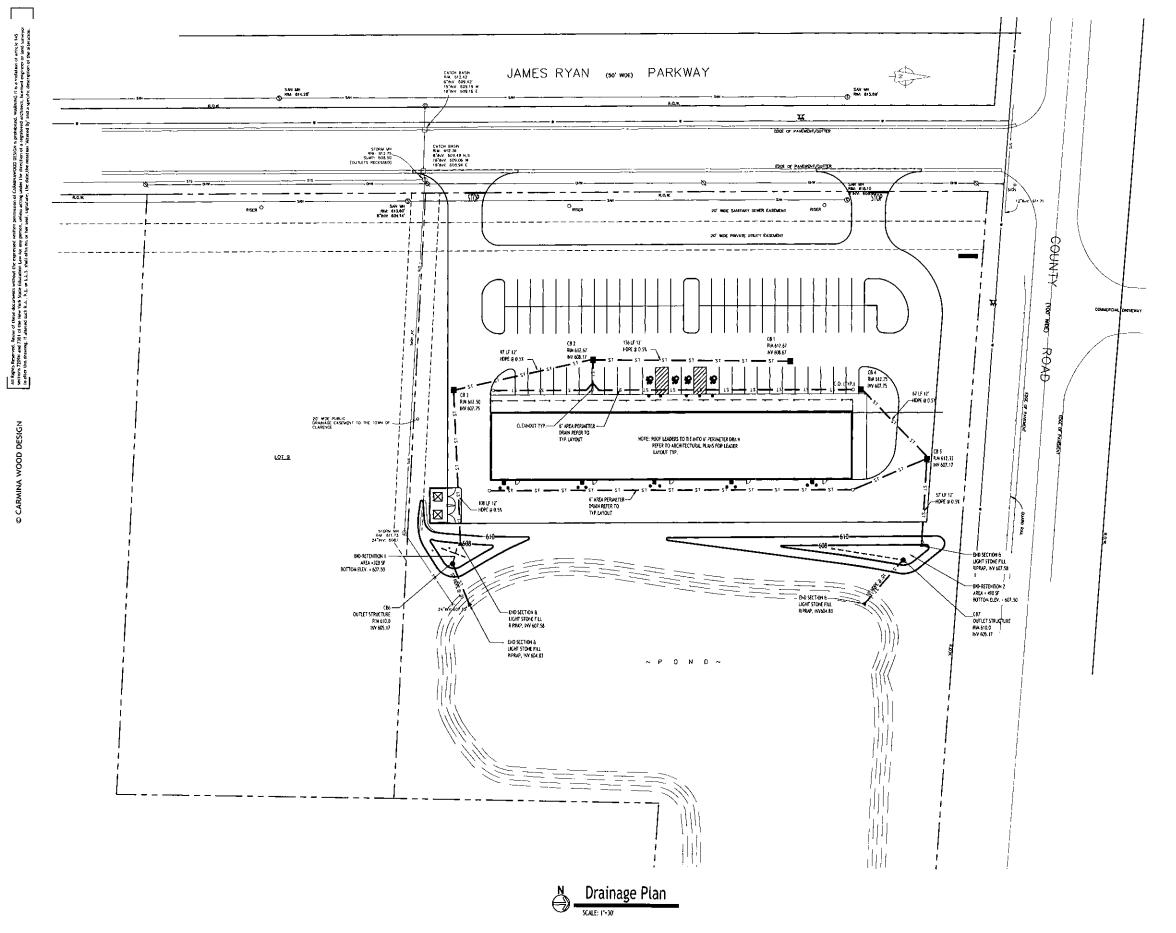

 CARMINAWOOD

DESIGN

Buffalo | Utica | Greensboro

Commercial Development
James Ryan Pkwy ® County Rd
Clarence, New York


PRELIMINARY
NOT FOR CONSTRUCTION

DRAWING NAME: Storm Drainage Plan


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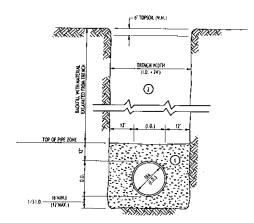
07.08.24 C. Wood As Noted

C-300
Project No: 23-4107

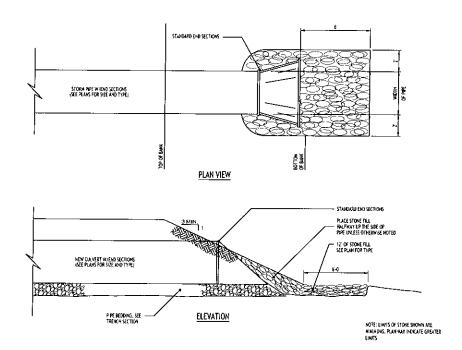

TYPICAL PIPE OUTLET W/ END SECTION & RIP RAP



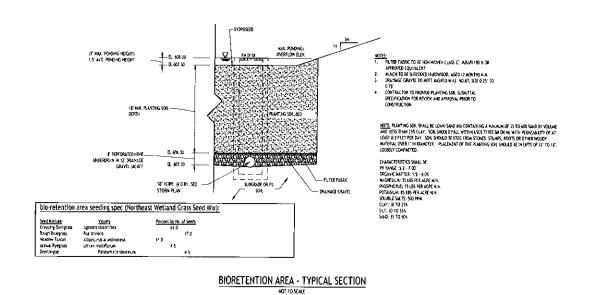

- A P.PE INSTALLATION SHALL BE IN ACCORDANCE WITH MANUFACTURERS
  RECOMMENDATIONS.
- B. TRENCHING OPERATIONS SHALL INCLUDE ALL NECESSARY DEWATERING.
- C. TRENCH OFFAILS ARE CHLY SHOWN FOR PURPOSES OF MATERIAL PLACEMENT AND MAYLWIM PAY LIGHTS.
- D. AN OSHA APPROYED MOVAINE PROTECTIVE TRENCH SHIELD SHAEL BE USED IN ALL UNSHEETED TRENCH AREAS.

## MATERIALS


PIPE BEDDING MATERIAL (MYSDOT 1985 EDITION)

(1) MO, I CRUSHED STONE OR CRUSHED CREATER WITH A CREADATION CONTORNING WITH MYCROT. SECTION FIDED, THE WATERALL SHALL BE WELL CREATER WITH MICHARD FROM THE CREATER THAT DOES HAVE AN ONLY WATER A WATERALL GRADUATION MEETING THE LIMITS DESCRIBED IN THE SPECIFICATIONS, THE REDUNG SHALL BE COMPACTED IN S. LPTS WITH EQUIPMENT. ACCEPTANCE TO THE PIPE MANUFACTURES.

NO SLAG SHALL BE ALLOWED FOR HATERIAL (

3 BAC OFFIL MATERIAL SHALL BE NATIVE SON CONTAINING HO LINSUITABLE MATERIAL COMPACTED IN 6" LIFTS.

STORM SEWER TRENCH SECTION IN UNPAYED AREAS

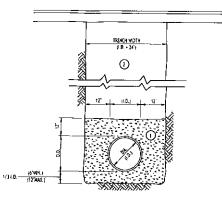

- A. PIPE INSTALLATION SHALL BE IN ACCOPDANCE WITH MAINLEACTURERS RECOMMENDATIONS.
- B. TRENCHING OPERATIONS SHALL INCLLIDE ALL NECESSARY DEWATERING.
- C. TRENCH DETAILS ARE ONLY SHOWN FOR PURPOSES OF WATERDAL PLACEMENT AND MAXIMUM PAY LIMITS.
- D. AN OSMA APPROVED MOVABLE PROTECTIVE TRENCH SHIELD SHALL be used in all unsheeted trench areas.

## MATERIALS

2.25 BEDDING MATERIAL (NYSDOT 1985 EDITION)


MO. 1 CRUSHED STORE OR RUSHED CRAVEL WITH A CAUGNING COMPOSITION WITH INSOOT SECTION TO-ID. THE MATERIAL SPALL BE WILL GACGO WITH HO PARTICLES LARGER THAN ONE. INCH AND HAVING A WASHING GACANTON WEITING THE LIWITS OFFS.RIPPORT HITE SPECIFICATIONS. THE BEDDING SHALL BE COMPACTED IN 6' LIFTS WITH EQUIPMENT. ACCEPTABLE TO THE PROC MAINUFACTURER.

NO SLAG SHALL BE ALLOWED FOR MATERIAL


(2) THER 2 CRUSHED STONE OR CRUSHED CRAYEL WITH A GRANATION CONFORMIC WITH INSDOT. SECTION SINK 20 THER 2. THE AMERICA SHALL BE WELL GRADED WITH NO PARTICLES LABORER THAN THAN DICHES AND HARMER AMADIEMIA COLLABOR WETTING THE LIMITS OFFICE BETT HE SPECIFICATIONS. THE BEDOWNED SHALL BE COMPACTED IN 6" LIFTS WITH EQUIPMENT ACCOPRACE TO THE PIRE MANUFACTURES.

NO SLAG SHALL SE ALLOWED FOR WATERUL (2)

STORM SEWER TRENCH SECTION IN PAVED AREAS NOT TO SCALE

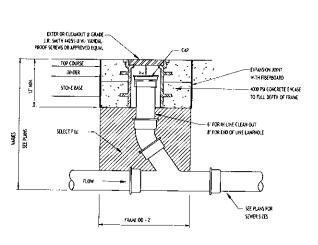

LAMPHOLE/CLEANOUT IN PAVEMENT/SIDEWALK

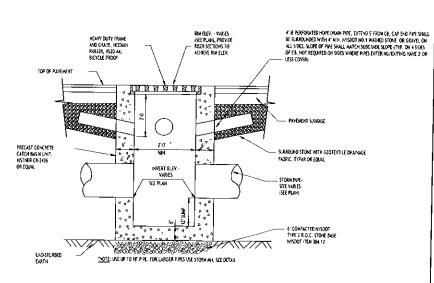

TYPICAL PRECAST CATCH BASIN

PRELIMINARY NOT FOR CONSTRUCTION

No.

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**Commercial Development** 

James Ryan Pkwy @ County Rd Clarence, New York


DESIGN

DRAWING NAME: Storm Details

DRAWING NO.

C-301

Project No: 23-4107

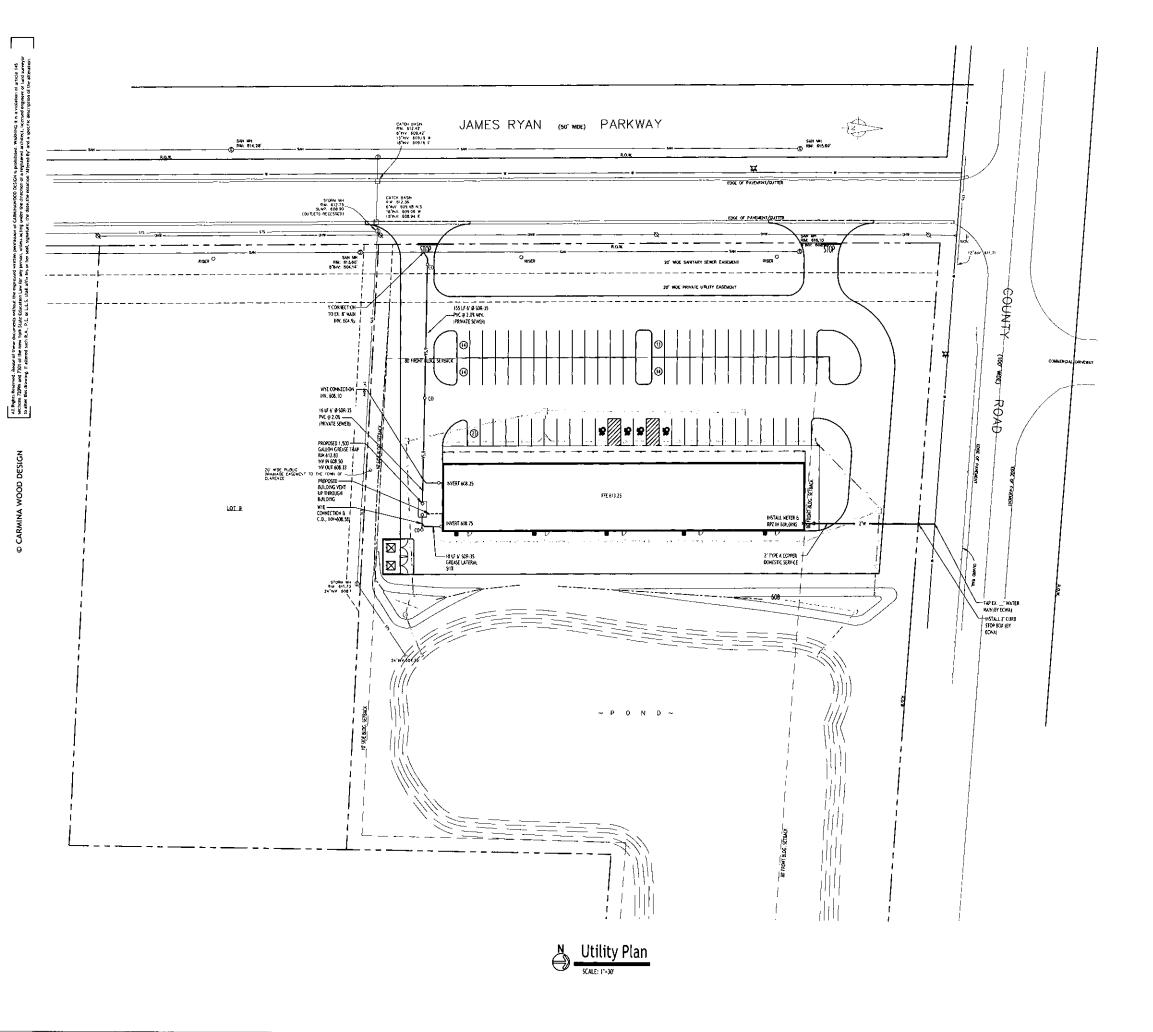

## <u>utiluty notęs por all layouts:</u>

- UTILITY CONECTION LOCATIONS SHOWN ARE SCHEMATIC AND SHALL BE COORDINATED WITH LITLLITY PLAYS, CONNECTION POWERS MAY YARY, COORDINATE WITH M.E.P. AND ARCHITECTURAL PLAYS.

- COMPACTOR TO PRED YERFY ALL EXSTING STORM AND SANTIARY LOCATIONSHINYERTS PRIOR TO CONSTRUCTION. WHITEIN SHORM REEL PAPPOCUMET, AND BASED ON RECORD DRAWNICKS RECORDED BY CHECK COUNTY DIMINION OF SERVICE AMANGEMENT (DOWN). ENSTRUCY WATER, GAS, EXECTIVE, AND SANTARY LIVES SHOWN ARE APPROXIMATE, CONTRACTION TO FIELD WERF FY LOCATION/STET/CONSTRUCTION CONTRACTION.
- SELECT BACKFILL IS REQUIRED FOR ALL UTBLITTES IGAS, WATER, STORM, SANITARY) THAT CROSS THROUGH PAYEURIT AREAS.
- 3. IF NECESSARY, PROVIDE FITTINGS AND BLOCKING AS NECESSARY AT ALL BENDS IN WATER LINES.
- A MINIMUM OF 10 FEET HORIZONTAL AND 18 INCHES OF VERTICAL SEPARATION MUST BE MAINTAINED BETWEEN ALL SANITARY SENER AND WATER SERVICES
- ERE COUNTY WATER AUTHORITY (ECWA) IS TO BE NOTIFIED A WINNHUM OF 48 HOURS PRIOR TO STARTING THE CONNECTION FOR THE NEW WATER SERVICE.
- ALE SANITARY SEWER CONSTRUCTION SHALL ADHERE TO ECOSM SPECIFICATIONS AND DETAILS, AND ERE COUNTRY DEPARTMENT OF HEALTH RULES AND REGULATIONS.
- All other required permits by the state of New 10RK, erge county, or town of West Seneca are the responsibility of the contractor.
- 8. CONSTRUCTION IS TO COMPORA TO ECOSA RULES AND REGULATIONS.
- ECDSA REQUIRES PROPER TESTING IDEFLECTION, HYDROSTATIC & AIR) BEFORE ACTIVATION OF THE 8" SEMER.
- 10. THE ERIE COUNTY WATER AUTHORITY (ECMA) IS TO BE HOTIFIED A MYMAUM OF 48 HOURS PRIOR TO STARTING THE CONNECTION FOR THE NEW WATER SERVICE.
- FOR LIGHTING ELECTRICAL POWER, SITE CONTRACTOR IS RESPONSIBLE FOR EXCAVATION AND BACKFALL ELECTRICAL CONTRACTOR IS RESPONSIBLE FOR LAYING CONDUIT.

## PROPOSEO UTILITY LEGEND

PROPOSED STORM SEWER	<b>—</b> st
PROPOSED SANITARY SEWER	- 62
PROPOSED WATERLINE	— 174
PROPOSED GAS (G), ÉLECTRIC (E). CABLE (C), à TELEPHONE (T)	
PROPSISED CATCH BASIN	<b>=</b> (
PROPOSED YARD DRAIN	<b>●</b> ¥
PROPOSED MANHOLE	<b>●</b> M
PROPOSED HYDRAHT ASSEMBLY	<u> </u>
PROPOSED GATE VALVE	⊕ GY

NOTE: FOR PROPOSED VALVE BOZES, CLEANDUTS, ETC., INSTALL A 1000 PSI CONCRETE COLUMA RADIOJO THE ITEM AT GRADE. THE COLUMA SHALL BE A WAY OF 6" WORD, ON ALL SOES, THE SOY, CLEANDUT, ETC. THE COLUMN SHALL BE A MIN. OF 6 THICK.

NOTE: BOUNDARY AND TOPOGRAPHIC INFORMATION PROY DED BY OTHERS. CARMINA WOOD DESIGN ASSUMES NO RESPONSIBILITY FOR ITS ACCURACY.

0 SARMINAWOC DESIGN

Commercial Development
James Ryan Pkwy @ County Rd
Clarence, New York

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PRELIMINARY NOT FOR CONSTRUCTION

DRAWING NAME: **Utility Plan** 

DRAWING NO.

C-400

<u>Project No:</u> 23-4107

- A. PIPE INSTALLATION SHALL BE IN ACCORDANCE WITH MANUFACTURERS RECOMMENDATIONS.
- 3. TREVCHING OPERATIONS SHALL INCLUDE ALL NECESSARY DEWATERING
- C. TRENCH DETAILS ARE ONLY SHOWN FOR PURPOSES OF MATERIAL PLACEMENT AND MAXIMUM PAY LIMITS.
- D. AN OSMA APPROVED MOVABLE PROTECTIVE TRENCH SHIELD SHALL be used in all unsheeted trench appas.


## MATERIALS

PEPE BEDDING WATERIAL INVSDOT 1985 EDITION

- 1) NO. 1 CRUSHED STONE OR CRUSHED CARVEL WITH A CREADATION CONFORMED WITH MISSOOT SECTION REFOR THE MATERIAL SHALL SKYNELL CORLINE WITH NO PRINTICES LIMITS THAT ONE SHALL OR CLUBAT ON METTING THE CHIRT'S DESCRIBED IN THE SPECIFICATIONS. THE EXDONO SHALL BE COMPACTED IN STLETS WITH EQUIPMENT. ACCEPTABLE TO THE 2 PE MANUFACTURES.
  - MO SLAG SHALL BE ALLOWED FOR MATERIAL (1)
- 1) THE 2 CRESHED STONE OR CRUSHED GRAVEL WITH A GRADATION CONTORWING MITH INSDOTT SECTION EAR 202 THE 2. THE WATERUL SPALE WHILL GRADED MITH IN PARTICLES LIRECE THAN THEN DIGGS AND HAVING A WAX-MAN GRADATION MEETING THE LIMIT SECREPAND IN THE SPECIFICATIONS. THE REPORTS SHALL SECREPAND IN 5' LIFTS WITH EQUIPMENT ACCEPTABLE TO THE PIPE MANUFACTURER.

NO SLAG SHALL BE ALLOWED FOR MATERIAL (2)

SEWER/WATERLINE TRENCH SECTION IN PAVED AREAS

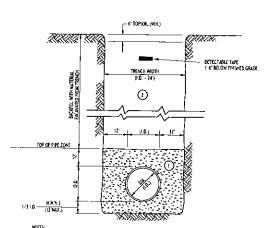

A. PIPE INSTALLATION SHALL BE IN ACCORDANCE WITH MANUFACTURERS RECOMMENDATIONS.


3. TRENCH-MG OPERATIONS SHALL INCLUDE ALL NECESSARY DEWATERING C. TRENCH DETAILS ARE ONLY SHOWN FOR PURPOSES OF MATERIAL PLACEMENT AND MAXIMUM PAY (LIMITS).

FIPE BEDDING MATERIAL INVSOOT 1985 EDITION)


NO. I CRUS-ED STONE OR CRUS-ED GRAVEL WITH A CARADITION CONFORMING WITH INSCOT. SECTION 701-02. THE WATERLA, SMALL BY WILL GRAVED WITHIN O MATRICES LINGTER THAN ONE. BUT HAD HAVING A MANUM GRAVAT ON WITHING THE 1981'S SEX 688 OF THE SECRETARION. THE RECOMPANIED IN SCHOOL WITHING LINES AND MANUFACTURER. HO SLAG SHA:L BE ALLOWED FOR WATERIAL 1

3 BACKFAL VATERIAL SHALL BE NATIVE SOIL CONTAINING NO UNSUITABLE WATERIAL. COMPACTED IN 6" LETS.


SEWER/WATERLINE TRENCH SECTION IN UNPAVED AREAS

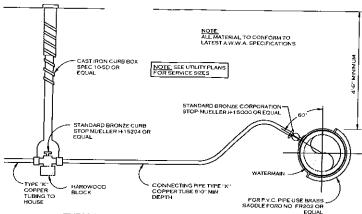

TYPICAL WATER SERVICE LINE INSTALLATION

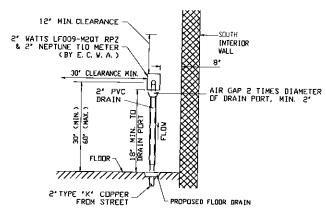

## **EAST ELEVATION** SCALE: NONE

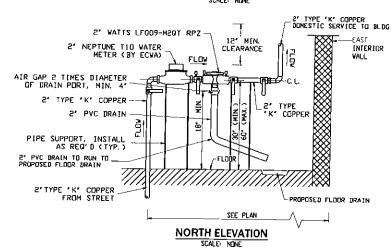

## 2" DOMESTIC SERVICE BACKFLOW PREVENTER INSTALLATION SCALE: NONE

NOTES:

1. NO TAPS TO BE MADE UPSTREAM OF RPZ & METER.
2. HEAT, LIGHT AND ELECTRIC TO BE PROVIDED AT RPZ LOCATION.
3. COORDINATE LOCATION WITH ARCHITECTURAL PLANS.

## 0 **ARMINAWO**

DESIGN

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Commercial Development County Rd James Ryan Pkwy @ C Clarence, New York

PRELIMINARY NOT FOR CONSTRUCTION


DRAWING NAME: **Utility Details** 

DRAWING NO.

07.08.24 C. Wood As Noted

C-401

Project No: 23-4107

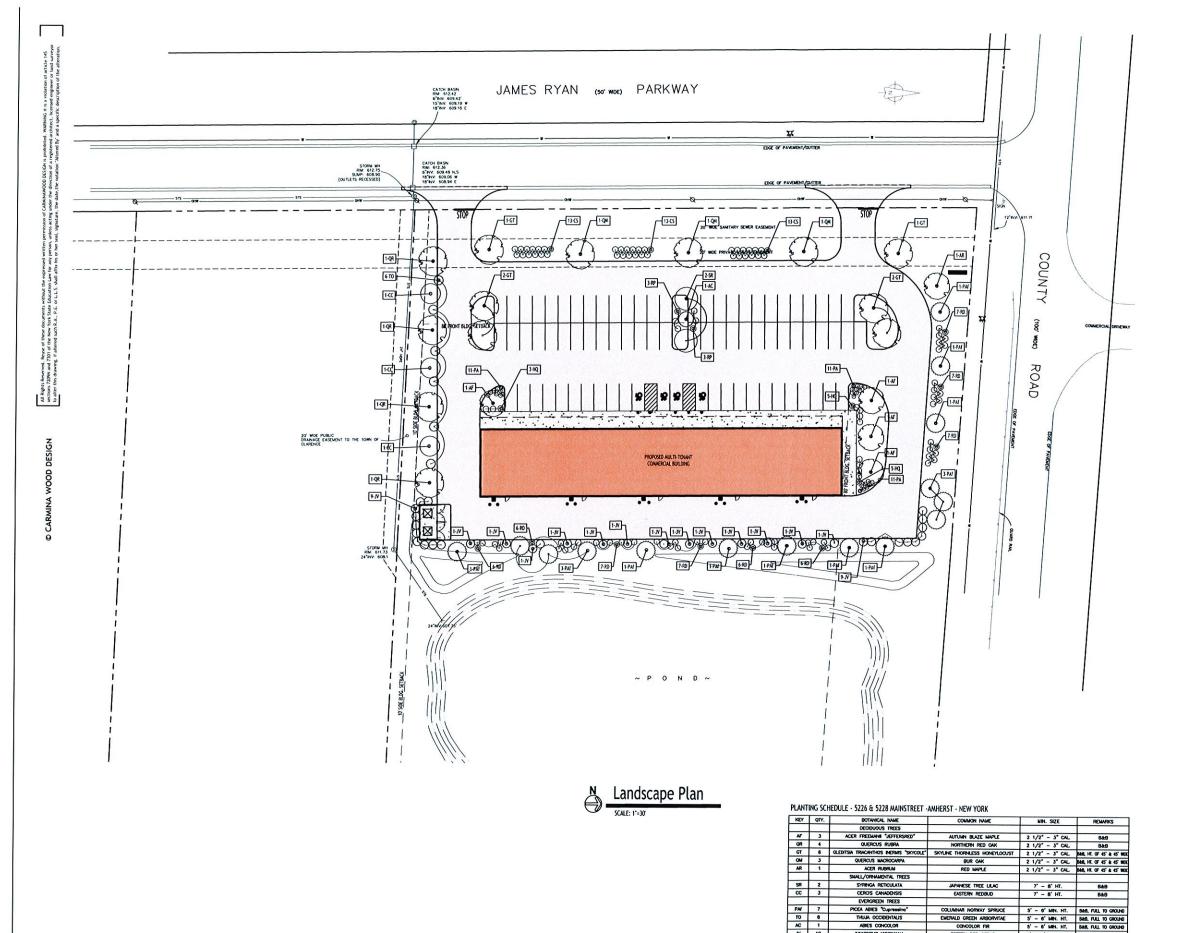

- ALL PLANTING BEDS & TREE PITS SHALL RECEIVE A MIN. 3-INCH DEPTH OF DARK SHREDGED HARDWOOD BARK MULCH, UNLESS OTHERWISE CALLED OUT ON PLANS.
- ALL PLANT MATERIALS SHALL BE ROPECTED THYCE ANNUALLY, ONCE IN THE SPRING AND AGAIN IN INE PALL. TREES 5 SHRISS THAT ARE ONLD BE ARE IN POOR COMMONIFICATION, DESIRED, STATE SHALL SHE REPLACED BYOME THE HOLT GOWING SLAGON. TREES AND SHRUSS THAT DO NOT CHART THE COMMING FOR SHACKEDIST SHALL BE PRIMED AT THE TIME OF INSPECTION TO REMOVE GRAD THICS & BRANCHES.
- ALL NURSERY TAGS TO REMAIN ON PLANTS UNTIL AFTER FINAL INSPECTION AND APPROVAL OF THE LANDSCAPING.
- 4. A DRP IRRIGATION SYSTEM IS RECOMMENDED FOR ALL PLANTINGS, SQUEER HOSES ARE RECOMMENDED AT THE TIME OF INSTALLATION OF ALL PLANT MATERIALS AND SHOULD BE LITUIZED THROUGHOUT THE ENTIRE LENGTH OF THE FIRST FULL GROWING SEASON.

\* ORVAMENTAL GRASSES SHOULD BE PRINED BACK IN LATE FALL OR EARLY SPRING TO ALLOW NEW FOLIAGE TO GROW IN SPRING.

## PLANTING NOTES:

- ALL INTERIOR LANDSCAPED AREAS SHALL HAVE A MINIMUM PLANTING SOIL DEPTH OF THREE (3) FEET AND BE FREE FROM ALL FORMS OF CONSTRUCTION DEBRIS AND FOREIGN MATERIAL.
- ALL TREE PIT SAUCERS, SHRUB BEDS, ORNAMENTAL GRASS BEDS, AND PERENNAL FLOWER BEDS SHALL RECEIVE THREE (3) INCHES DEPTH OF DARK SHREDDED HARDWOOD BARK MULCH.
- All Seasonal Flower Beds Shall be a minimum of twelve (12) inches deep with a well-bended mature of 50% feat moss & 50% scredned topsoil. No mulch shall be installed in the seasonal flower beds. . ALL DECIDUOUS AND EVERGREEN TREES SHALL BE STAKED WITH THREE (3)
  TREE STAKES AS PER TREE PLANTING DETAIL.

LEGEND

DECIDUOUS TREE

0

SMALL TREE EVERGREEN TREE

BUSH/ORNAWENTAL GRASS

HOTE: BOUNDARY AND TOPOGRAPHIC INFORMATION PROVIDED BY OTHERS, CARMINA WOOD DESIGN ASSUMES NO RESPONSIBILITY FOR ITS ACCURACY.

32" HIGH MIN. NO. 3 CONT. 24" HIGH MIN. NO. 3 CONT. 32" HIGH MIN. NO. 3 CONT. 32" HIGH MIN. NO. 3 CONT.

OAKLEAF HYDRANGEA
P.J.M. RHODODENDRON
SIBERIAN DOGWOOD
REDOSIER DOGWOOD



Project No: 23-4107

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Commercial Development

James Ryan Pkwy @ County Rd Clarence, New York


DESIGN


PRELIMINARY NOT FOR CONSTRUCTION


DRAWING NAME: Site Landscape Concept

Date: Drawn By: Scale: DRAWING NO. 07.08.24

L-100

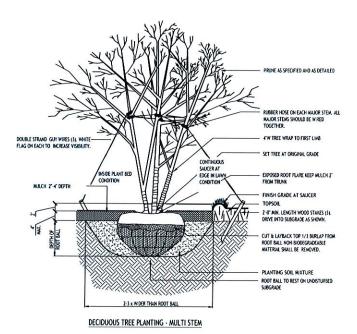

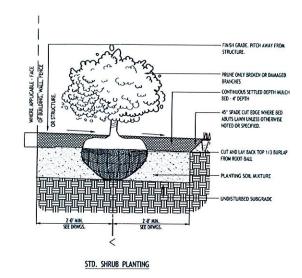

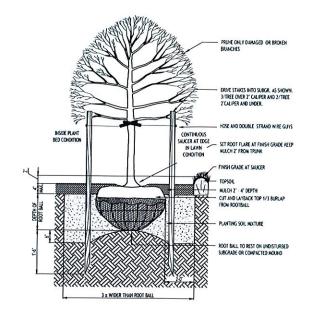



STD. DECIDUOUS TREET PLANTING

- 1. ALL PLANTS INSTALLED SHALL MEET OR EXCEED THE MINIMUM REQUIREMENTS AS NOTED ON THE PLANS AND IN THE LATEST EDITION ON THE AMERICAN STANDARD FOR NURSERY STOCK, BY THE AMERICAN ASSOCIATION OF MUISERYMEN, ANSI 260.1
- 2. THE CONTRACTOR SHALL BE RESPONSIBLE FOR HIS OWN QUANTITY TAKEOFF, THE QUANTITIES SHOWN ARE A MINIMUM AND ARE FOR REFERENCE ONLY.
- THE CONTRACTOR SHALL REPORM A ROUGH FIELD STANEOUT OF ALL PLANTING MATERIAL LOCATIONS AND CONTACT THE OWNERS FIELD REPRESENTATIVE PROOK TO ACTUALL INSTALLING. THE PLANTING MATERIAL LOCATIONS SHOWN ON THE PLANS ARE TO CONNEY THE DESIGN INTERT ONLY, ACTUAL LOCATIONS WILL BE FINALIZED BY THE OWNERS FIELD REPRESENTATIVE AT THE TIME OF INSTALLATION. 4. THE CONTRACTOR IS BERREY NOTIFED THAT IF UNDERGROUND UTILITIES DUST IN THE VICINITY OF THE PLANTINGS, ALL PROMOSED PLANTINGS SHALL BE RESTALLED ANNIHAM OF 5 FROM ANY UNDERGROUND UTILITY, CONTACT THE OWNERS FIELD REPRESENTANTE IF PLANTINGS SHOWN ON THE PLANS VICINITIES THIS STRUKTON.
- 6. PLANTING BACKFILL MIXTURE SHALL CONSIST OF 3 PARTS TOPSOIL, I PART PEAT MOSS, X PART MILORGANITE,
- 8. ALL PLANTED AREAS SHALL RECEIVE A 3" LAYER OF SHREDDED HARDWOOD BARK MULCH WITH "PREEN".
- 9. ALL DISTURBED AREAS NOT RECEIVING PLANTINGS (INCLUDING RIGHT-OF-WAYS) SHALL BE SEEDED.

5. ALL TREES SHALL BE INSTALLED A MINIMUM OF 20' FROM ANY OVERHEAD ELECTRIC LINES.

- 10. THE AREAS ON THE PLAN TO BE SEEDED SHALL HAVE 4" MINIMUM OF TOPSOIL, DISK PLOWED, LEVELED AND HAND RAYED SMOOTH. SURFACE SHALL BE ROLLED TO REMOVE LUMPS.
- 12. THE CONTRACTOR SHALL BE RESPONSIBLE FOR WATERING, MOWING AND OTHER MAINTENANCE TO SECRED AREAS UNTIL THE PROJECT IS ACCEPTED BY THE OWNER, THIS SHALL INCLIDE WATERING DALY FOR 15 DAYS OR AS REQUIRED BY WEATHER CONDITIONS AND RE-SEEDING OF THIN SPOTS FOLLOWING THE GERMINATION OF THE SEEDS.

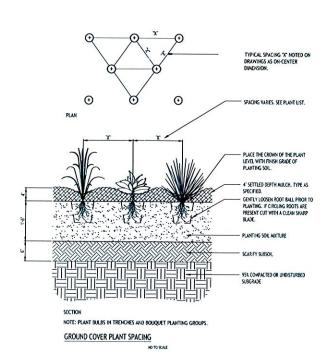

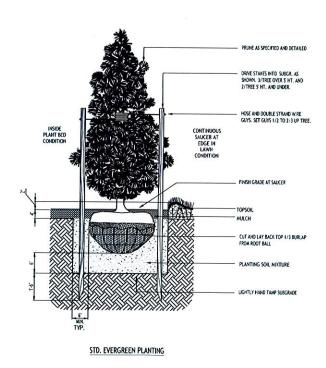

CARMINAWOOD

Commercial Development

Rd

James Ryan Pkwy @ County Clarence, New York

DRAWING NO.


L-101

PRELIMINARY NOT FOR CONSTRUCTION

Project No: 23-4107

DRAWING NAME:


Site Landscape Concept

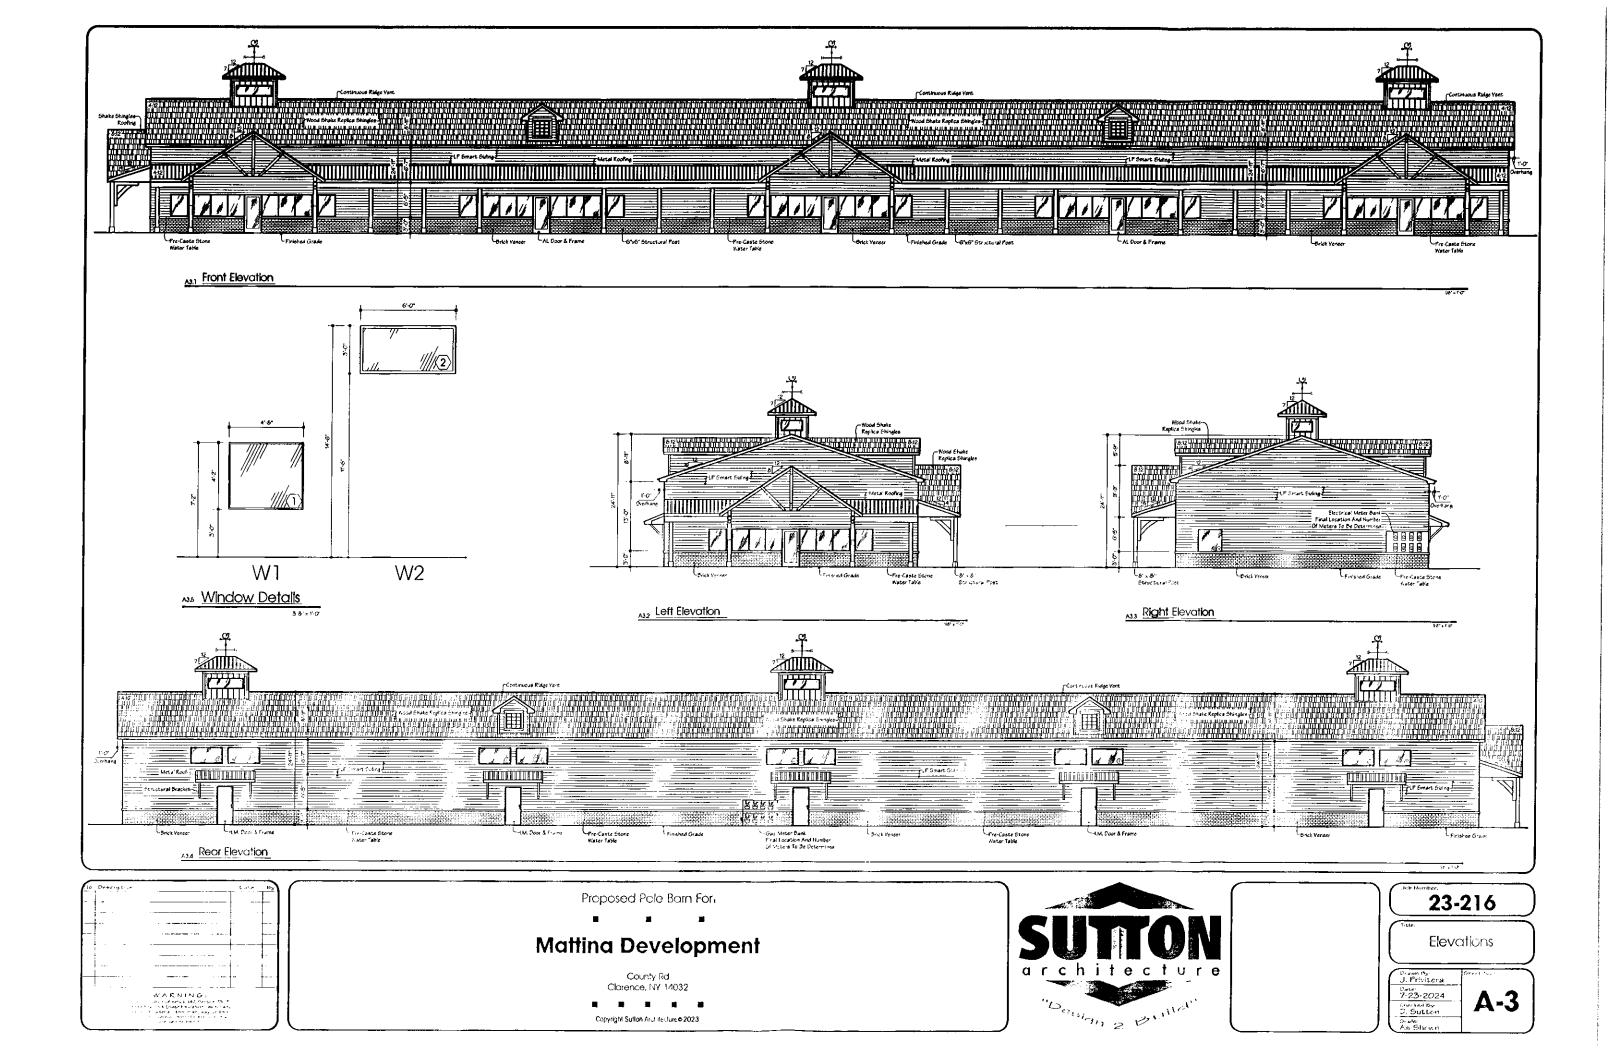

## Area Variance Analysis County Road and James Ryan Parkway

Mattina Development, LLC ("Applicant"), proposes construction of a 12,288 SF multitenant retail building and plaza at the northeast corner of County Road and James Ryan Parkway, SBL 44.00-1-55, sublots 10, 11 and the stormwater Retention sublot ("Property"). The Property is zoned Industrial, and the Development is a permitted use.

To accommodate the necessary parking, Applicant must place parking in the 80' front yard building setback along James Ryan Parkway, which requires a variance under Town Zoning Code § 229-103.B. *See also* Town Zoning Code § 229-102.E (requiring 80' front setback). In the image below, the parking area relevant to the variance is circled in red.

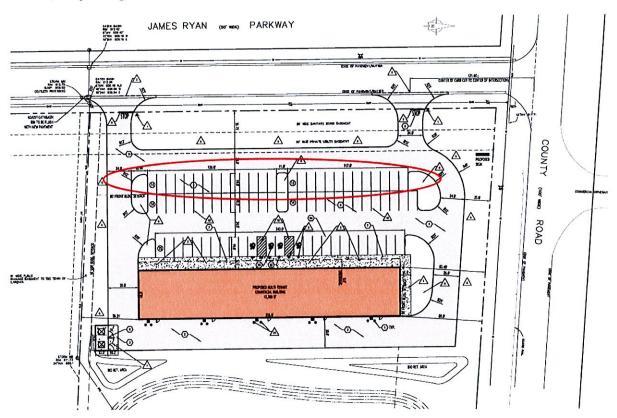

As detailed in the following analysis, the benefits of granting the variance outweighs detriments to health, safety, and welfare of the neighborhood or community.

## Variance Standard

As this Zoning Board of Appeals ("ZBA") is aware, the standard for reviewing area variance requests is set forth in New York State Town Law § 267-b(3)(b). In making its determination, the ZBA shall consider the benefit to the Applicant if the variance is granted, as weighed against the detriment to the health, safety and welfare of the neighborhood or community by such grant. In making such determination the board shall also consider:

## (1) whether an undesirable change will be produced in the character of the neighborhood or a detriment to nearby properties will be created by the granting of the area variance.

Authorizing the proposed the parking location will not produce an undesirable change in the character of the neighborhood or detriment nearby properties. The front setback variance, if granted, will allow the required number of parking spaces to service the retail plaza. It is essential that enough parking be accommodated on-site as there are no alternative means to park on the Property or in this area. Further, the parking area remains 60' from Property line parallel to James Ryan Parkway and otherwise compliant with the 80' setback requirement parallel to County. James Ryan Parkway is internal to other lots in the industrial park, which minimizes the impact of parking spaces being just 20' closer than required.

## (2) whether the benefit sought by the applicant can be achieved by some method, feasible for the applicant to pursue, other than an area variance.

The benefit sought by the Applicant cannot be achieved by any other method, feasible for the Applicant to pursue. Strict compliance with the established setbacks would result in a loss of 17 parking spaces and significant site redesign. Applicant would likely need a variance for total parking spaces. It is essential that enough parking be accommodated on-site as there are no alternative means to park on the Property or in this area. Similarly, shifting the parking away from James Ryan Parkway to meet setbacks, would undermine the navigability and flow of traffic in the rear of the building.

## (3) whether the requested area variance is substantial.

As the ZBA is aware, the law in New York is clear that a pure mathematical formula cannot be the basis of a determination of whether a variance should be considered substantial. The ZBA must consider the magnitude of the requested variance in light of its impact. Merely because a variance may seem noteworthy on paper does not mean that any "harm" would be generated on the surrounding community, and it is "harm" that is balanced against the interest of the Applicant according to the Town Law § 267-b(3) test. Here, the requested variances are not substantial. The variance facilitates appropriate parking on the Property with minimal intrusion to the community as the abbreviated parking setback fronts the roadway that services the industrial park. Accordingly, the variance is not substantial.

## (4) whether the proposed variance will have an adverse effect or impact on the physical or environmental conditions in the neighborhood or district.

The requested variance will not adversely affect the environment. The requested variance will not impact drainage, flooding, and runoff or any other topographical changes such as grading, trees, and vegetation. The Planning Board conducted a coordinated review pursuant to the State Environmental Quality Review Act (SEQRA) and granted a Negative Declaration at its July 31, 2024 meeting.

(5) whether the alleged difficulty was self-created, which consideration shall be relevant to the decision of the board of appeals, but shall not necessarily preclude the granting of the area variance.

The alleged difficulty of strict compliance is not self-created. If, however, the ZBA should determine that the alleged difficulties are self-created, Town Law § 267-b(3)(b) provides that such a determination does not preclude the granting of the requested variance but is merely a factor to consider.

## Balancing.

As indicated above, the ZBA must take into consideration the benefit to the Applicant if the variances are granted, as weighed against the detriment to the health, safety and welfare of the neighborhood or community by such grant. Here, the benefit to the Applicant is substantial. Granting the requested variance authorizes Applicant to proceed with the Development with sufficient quantity of parking in a manner that is not obtrusive to the area. On the other hand, any detriment to the health, safety and welfare of the neighborhood or community is *de minimis*. With substantial benefit to the Applicant if the variances are granted and no identified detriment to the health safety and welfare of the community by such a grant, it is respectfully requested the proposed variances be approved.



## **Request for Action**

Town of Clarence | Office of Planning & Zoning (716)741-8933 | 1 Town Place, Clarence, NY 14031

## **Town Use Only**

Date: August 13, 2024

Received By: Planning & Zoning Office

Project Address: 6455 Salt Road

SBL #: 45.00-1-55.13

## **Action Desired:**

Applicant requests a variance of 4' to allow an 11' principal structure side yard setback located at 6455 Salt Road in the Agricultural Rural Residential zone.

## Reason:

APPLICANT REQUEST:

Town Code Reference: §229-41(B)(2)

		APPLICANT INFO	1
	Name / Business:	Michele Buccinna	CORRE
	E-Mail:		Please indicate the appro
	Phone #:	-ILE	billing associated v
CONTACT INFO:	Address:	ONFILE	✓ Applicant Project Sponso
	Town:	State:	Zip:
TAC		PROJECT SPONSOR INFO (If Different Than Applica	nt) SIG
Ó	Name / Business:		Request for Action
	E-Mail:		in the spaces provi for Action shall be Planning and Zoni
	Phone #:	ONFILE	plans, maps, and su signing below I certi submit this Request
	Address:	OM.	its contents t
	Town:	State:	Zip: Signed: Sign
		State:	its conten

## CORRESPONDENCE

Please indicate the preferred entity that shall receive the appropriate correspondence and billing associated with this Request for Action.

Please select only one.

<b>/</b>	Applicant
	Project Sponsor

## **SIGNATURE**

Request for Action shall be filled out completely in the spaces provided. The complete Request for Action shall be submitted to the Office of Planning and Zoning along with all necessary plans, maps, and supporting documentation. By signing below I certify that I have the authority to submit this Request for Action, and further certify its contents to be true and correct.

Signed: Signature On File

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\*\*\*note the parcel lines displayed are approximate\*\*\*

## 6455 Salt Road



# Proposed 11' principal structure side yard setback.


The minimum required side yard setback is 15' for the principal structure.

A 4' variance is requested.



Action:

Action:

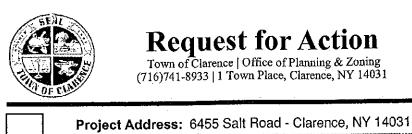

Request for Action
Town of Clarence | Office of Planning & Zoning
(716)741-8933 | 1 Town Place, Clarence, NY 14031

Ву:

Town	Use	On	ŀ

Date: 8/

Received By:

SBL#:				a and decisions with the company of the first term of the decision of the company
Action Desired:				
Lot address is in Zoning Dist	rict A-RR - Agricultural Rural R	esidential. Owners seek an are	a variance to permit a	side setback of +/- 11'-0'.
	de, Section 229-41-B requires	•		
Reason:	and the second of the second o			A
house accord floor	es a front-load garage to align		**	•
radius and backing room	would place garage entirely or pavement at left side of the lot.			
Side-load garage design intersecting main house re	would also add to the project co	st due to added complexity of	house and garage roof	construction
intersecting main nodes in		* * * * * * * * * * * * * * * * * * *		. :
				O O NATURE
	APPLICANT INFO			SIGNATURE
Name / Business: Miche	ele Buccinna		in the chac	Action shall be filled out completely es provided. The complete Request
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C-IYIAII.			plans, maps	, and supporting documentation. By w I certify that I have the authority to
Phone #:			I submit this F	Request for Action, and further certify ntents to be true and correct.
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## BUCCINA: Area Variance Criteria and Responses 6455 Salt Road – Clarence, NY 1t4031

## Area Variance - CRITERIA

An area variance shall mean the authorization by the Zoning Board of Appeals for the use of land in a manner which is not allowed by the dimensional or physical requirements of the applicable zoning regulations. In making its determination, the Zoning Board of Appeals shall take into consideration the benefit to the applicant if the variance is granted, as weighed against the detriment to the health, safety and welfare of the neighborhood community by such grant. In making such determination the Board shall also consider:

- 1. Whether an undesirable change will be produced in the character of the neighborhood or a detriment to nearby properties will be created by the granting of the area variance;
- 2. Whether the benefit sought by the applicant can be achieved by some method, feasible for the applicant to pursue, other than an area variance;
- 3. Whether the requested area variance is substantial;
- 4. Whether the proposed variance will have an adverse effect or impact on the physical or environmental conditions in the neighborhood or district; and
- 5. Whether the alleged difficulty was self-created, which consideration shall be relevant to the decision of the Board of Appeals, but shall not necessarily preclude the granting of the area variance.

## **BUCCINNA RESPONSES:**

 Whether an undesirable change will be produced in the character of the neighborhood or a detriment to nearby properties will be created by the granting of the area variance;

RESPONSE: NO

- 1. The variance request will allow for the construction of a single-family house in character with the existing nearby houses.
- 2. The existing house adjacent to the left side property line where the variance is requested has its garage along the common property line. The proposed construction would result in two garages adject to each other on either side of the property line, thus providing separation between the main interior and exterior living areas of each property.
- 2. Whether the benefit sought by the applicant can be achieved by some method, feasible for the applicant to pursue, other than an area variance;

RESPONSE: NO

- 1. The proposed design of the house and garage aligns the two roof to provide for construction efficiency, and for access to the garage attic from the house second floor for convenience and security.
- 2. In order to comply with the required 15'-0" side setback, the garage would have to be moved partially or entirely behind the house to create a side-loaded garage. This would require added driveway pavement for entering turning radius and for backing out to exit the garage.
- 3. The rear placement of the garage would also require added complexity and cost in roof structural design and construction for the house and garage as they intersect at a right angle
- 3. Whether the requested area variance is substantial;

RESPONSE: NO

- 1. The variance request is for +/-4'-0".
- 2. Since the adjacent property also has its garage near the shared boundary line, the variance request would not result in an encroachment of the main living and activity areas of the two properties.

## BUCCINA: Area Variance Criteria and Responses (continued)

4. Whether the proposed variance will have an adverse effect or impact on the physical or environmental conditions in the neighborhood or district; and

RESPONSE: NO

- 1. The resulting construction would be opposite the existing neighboring garage, and would not have a negative effect on the neighbor's use of their property.
- 2. The resulting construction is consistent with the character of the existing houses and properties in the neighborhood.
- 5. Whether the alleged difficulty was self-created, which consideration shall be relevant to the decision of the Board of Appeals, but shall not necessarily preclude the granting of the area variance.

**RESPONSE: NO** 


- 1. The lot in question was platted long before the current zoning setbacks were adopted for minimum lot widths of 150'-0" (Section 229-40-A).
- 2. The owners seek permission to make use of and derive maximum use of their property with the construction of a single-family house which is well within the context of other neighboring existing properties.

Address of Property		
6455 Salt Road		
Clarence, NY 14031		
Owner / Applicant:	 	
Signature	 	
Date		

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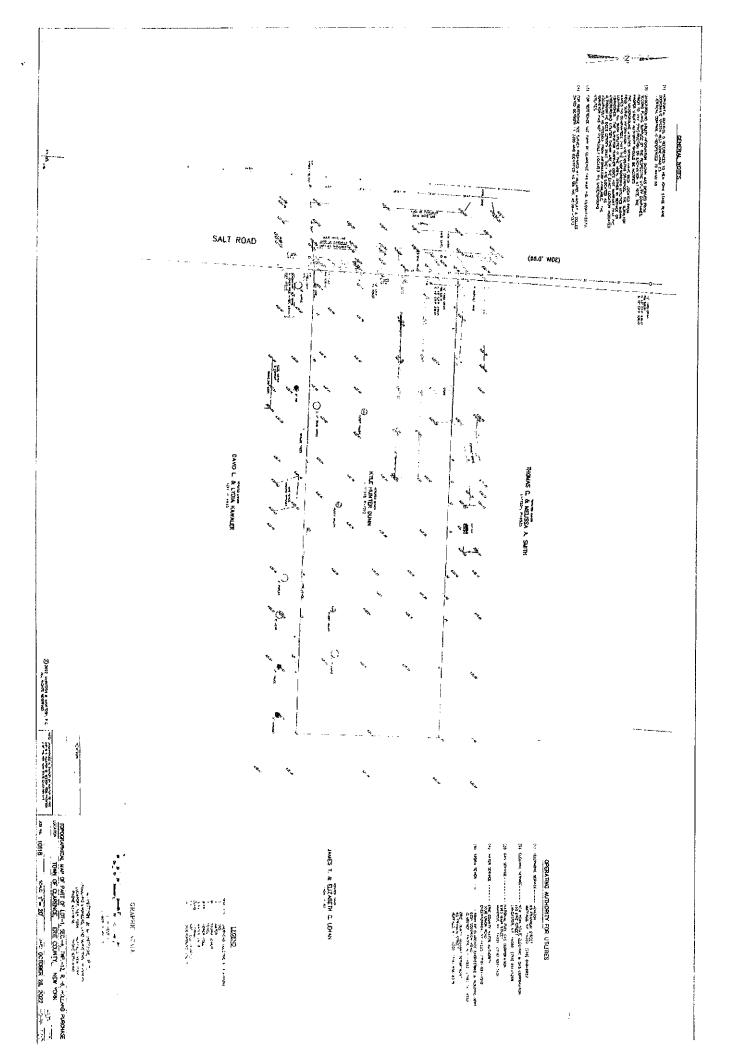
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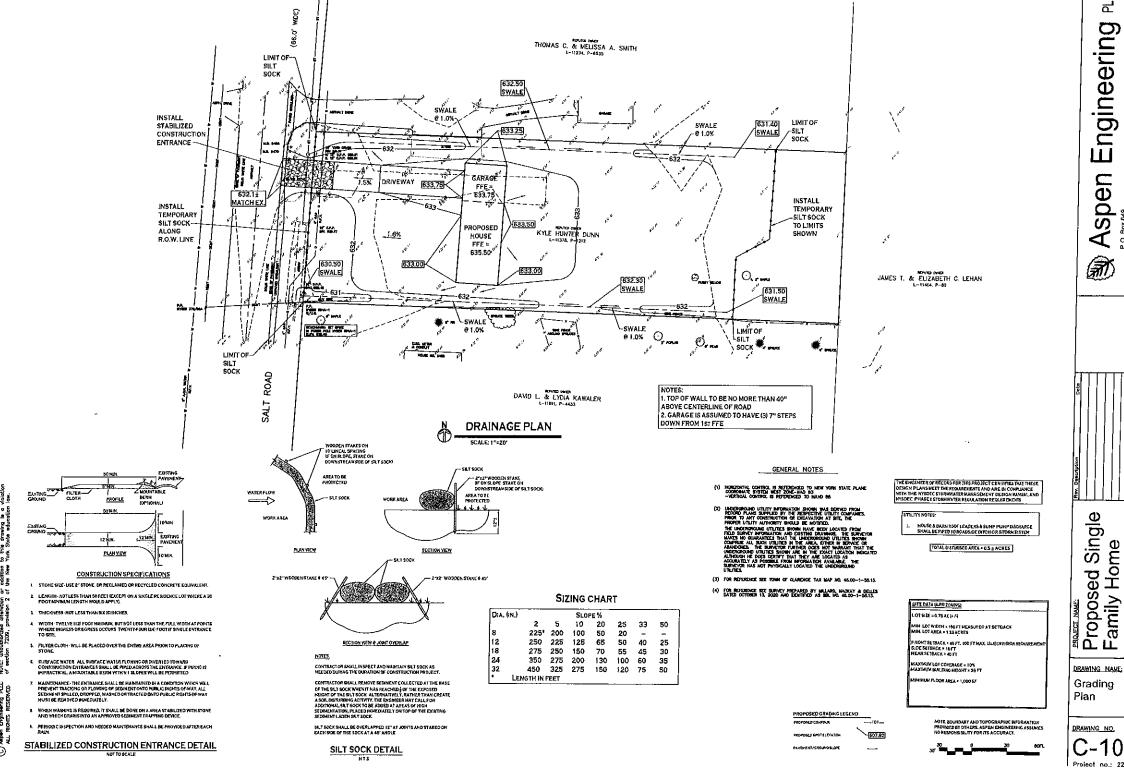
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PLLC Engineering

Aspen P.O. Box 649 Octhard Park, New York, 1417, 716-559-3342

**a** 

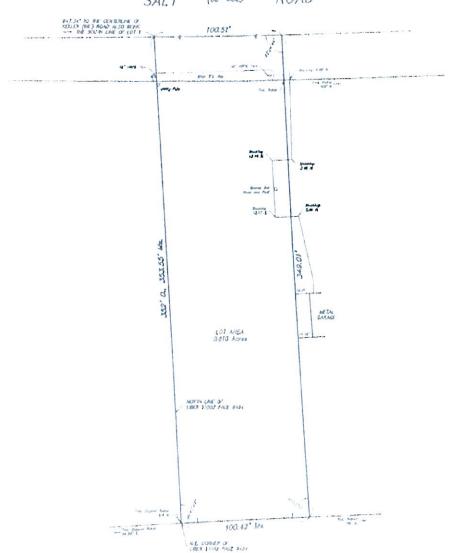Proposed Single Family Home 6455 Salt Road Clarence, New York

DRAWING NO.

C-100 Project no.: 22.xxx

## **DICEY-BUCCINNA RESIDENCE**

PERMIT SUBMISSION - AUGUST 1, 2024

6455 SALT ROAD CLARENCE, NEW YORK 14031

PRE-CONSTRUCTION

1. PROJECT SCOPE OF WORK IS A NEW SINGLE-FAMILY RESIDENCE.

2. THESE DOCUMENTS HAVE BEEN PREPARED BASED ON ANECDOTAL INFORMATION ABOUT THE SITE PROVIDED BY THE OWNERS TO THE ARCHITECT DURING THE COURSE OF HISMER WORK, SUB-GRADE NATURAL AND MANAMORE ELEMENTS SHALL BE THE REPONSIBILITY OF THE OWNER OF UNCOVER ANDOR ORSASSEMBLE OR OTHERWISE REMOVE, OR TO PROVIDE OR SHADE WISE OR OTHERWISE REMOVE, OR TO PROVIDE OBSERVATION, DOCUMENTATION, OR TESTING AS MAY BE REQUIRED BY THE BUILDING

REMOVE, CRITO PROVIDE GISSENVATION, DECOMENTATION, OR TESTINGS SAM 36 REQUINED IT THE GOLDING CODE OFFICIAL WAY. OR THE STATE OF THE ST

YORK STATE BUILDING COOK, RESIDENTIAL CODE. AND THE ENERGY CONSERVATION CONSTRUCTION CODE (2005 EDITIONS). THE OWNER/CONTRACTOR SHULL BE RESPONSIBLE FOR ADAPTING THESE PLANS, IR RECURRED, TO SUT SITE CONDITIONS. SUCH ALTERATIONS SHALL NOT VIOLATE ANY APPLICABLE CODES, NOR ALTER THE STRUCTURAL INTEGRITY OF THE BUILDING. ANY DIMENSIONS SHOWN AS 4- ARE APPROXIMATE AND SHALL BE VERIFIED AND/OR ADJUSTED IN THE FIELD. OWNER/CONTRACTOR SHALL VERIFY IN THE FIELD ALL NOTES AND DIMENSIONS BEFORE CONSTRUCTION. THESE DRAWNICS ARE NOT TO BE SCALED. USE DISCISSIONS GIVEN AND FIELD VERIFY AS REQUIRED. THE SITE PLAN SHOWNY IS SCHAMALTE FOR THE PURPOSE OF DEMONSTRATING CONTRACT.

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9. THE WORK SCOLENCE MID SCHEDULE SHALL BE MITURALLY AGREED UPON BY BOTH THE OWNERS AND THE CONTRACTOR.

10. APPLICABLE CODE REQUIREMENTS MAY VARY ALONG WITH CONSTRUCTION STANDARDS AND TECHNIQUES. VERRY ALL STRACKS AND GRADE ELEVATIONS WITH BUILDING INSPECTOR AND CICKINED UND SURVEYOR BEFORE BEGINNING ANY WORK. ON THE ARCHITECT OF ANY DISCREPANCIES BEFORE BEGINNING ANY WORK. ON THE ARCHITECT OF ANY DISCREPANCIES BEFORE BEGINNING ANY WORK.

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12. THE CONTRACTOR SHALL BE RESPONSIBLE SO THAT ALL WINDOWS AND DOORS INSTALLED AN SPECIFIED OR AS APPROVED SUBSTITUTIONS MEET THE NEW YORK STATE BURGY CONSERVATION CODE REQUIREMENTS, AND ALL CODE REQUIREMENTS FOR HATURAL LIGHT, VENTILATION, AND EXERCISENCY SCREESS, WINDOWS AND OR OLONG SCHEPAULEMENTS, AND ALL CODE REQUIREMENTS FOR HATURAL LIGHT, VENTILATION, AND EXERCISENCY SCREESS, WINDOWS AND OR OLONG SCHEPAULEMENTS, AND ALL CODE THE SITE SHOULD BE MADE BY ALL OTHER CONTRACTOR OF THE SITE SHOULD BE MADE BY ALL OTHER CONTRACTOR OF SOME BY ALL OTHER CONTRACTOR OF STORY AND ALLY MAKE BEARDS OF ALL OTHER CONTRACTORS CONCERNED TO FILL STORY AND BEAUTED FOR LIFE OF ALL AND ALL OF DISCONTIONS WHICH LAND YOUR AS BEADERS OF ALL OTHER CONTRACTORS CONCERNED TO FILL STORY AND ALLY ALL OF DISCONTIONS WHICH LAND YOUR AS BEADERS OF ALL OTHER CONCERNS AND OF A BUT IS

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DRAWINGS.

15. THE CONTRACTOR SHALL OBTAIN AND PAY FOR ALL PERMITS AND APPROVALS REQUIRED BY THE LOCAL ZOWING AND BUILDING DEPARTMENTS AND ANY OTHER GOVERNMENTAL AGENCY HAVING JURISDICTION OVER THE WORK.

ALL APPLICABLE REGULATIONS SHALL BE ADMERED TO AND CARRIED OUT BY ALL INDIVIDUALS UNDER THIS CONTRACT.

CONTRACT. THE CONTRACTOR SHALL FURNISH A CERTIFICATE OF INSURANCE INDICATING THE TYPE AND AMOUNTS OF

16 THE CONTRACTOR SHALL FURNISH A CERTIFICATE OF INSURANCE INIDICATING THE TYPE AND AMOUNTS OF COVERAGE AS REQUIRED BY KEY MOY AS TOTAL AND THE COOK LIMICATION. THE TOP AND AMOUNTS OF COVERAGE AS REQUIRED KEY MEY MOYERS.

17. THE CONTRACTOR SHALL QUARANTEE HIS WORK AND HIS SUBCONTRACTOR'S WORK AGAINST FAULTY MATERIALS AND WORKMASHED HIS ACCORDANCE WITH NEW YORK STATE GENERAL BUSINESS CAW.

15. THESE CRAIMINGS HAVE BEEN PREPARED FOR STRUCTURAL AND LIFE BASETY INTENT CALLY NO MECHANICAL, ELECTRICAL PLUMBING HEP, STECKILL, NOR FIRE PROTECTION PREVENTION ENGINEERING OR SPECIFICATIONS ARE INCLUDED BY THE ARCHITECT IN THESE DOCUMENTS. ALL SUCH ENGINEERING AS

SPECIFICATIONS ARE INCLUDED BY THE ARCHITECT IN THESE DOCUMENTS, ALL SUCH ENGINEERING AS REQUIRED SHALL BE PERFORMED BY OTHER DRAWINGS MARKED WITH AN ORIGINAL OF THE ARCHITECT'S SEAL IN MY SHALL SE CONSIDERED TO BE VALID TIME COPIES.

21. ALL PLIMBING AND SELECTRICAL WORK, AND MECHANICAL HEATING, CODURG, AND VENTILATION IS THE RESPONSIBILITY OF THE OWNER AND GENERAL CONTRACTOR ON A DESIGN-BUILD BASIS, ALL EQUIPMENT, SYSTEMS, AND INSTALLATIONS SHALL COMPLY WITH ALL APPLICABLE CODES.

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GUARDS AND HANDRAILS 200 psf 12ps/ (DEAD LOAD) 12ps/ (DEAD LOAD) 12 ps/ (DEAD LOAD) SINGLE CONCENTRATED LOAD AT ANY POINT

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GUARDS AND HANDRAILS
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CODE AND THE ACCOMPANYING GEOTECH REPORT #60EA 22-125 BY GLYINI GROUP ENGINE ERWO AND ARCHITECTURE, PLC.
THE GEOTECH REPORT SHALL BE SUBMITTED TO THE BUILDING DEPARTMENT AS AN ELEMENT OF THE PERMIT REVIEW PROTHE CONTRACTOR SHALL BE AREPONSIBLE FOR ALL SUBRIGHED CONTROTIONS, THE CONTRACTOR SHALL BE AREPONSIBLE FOR ALL SUBRIGHED CONTROTIONS, THE CONTRACTOR SHALL BE AREPONSIBLE FOR CONSULTING WITH A SOILS ENGINEER TO VERIFY SUBGRADE CONDITIONS AND SUBSTANTIANTE ACTUAL
BEARING CAPACITY.

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PROVIDE DEEP SCORE CONTROL JOINTS AT JUD POINTS OF ALL SLABS BOTH DIRECTIONS

STRUCTURAL STEEL

1. ALL STRUCTURAL STEEL SHALL CONFORM WITH ASTM SPECIFICATION A-38.

1. ALL STRUCTURAL STEEL SHALL CONFORM WITH ASTM SPECIFICATION A-38.

1. MALES OTHERWISE MOTED, PROVIDE A D. PLATE BOLTED TO THE TOP FLANCE OF ALL STEEL BOLDS STITLED AND ALL STEEL BOLTS STROGERED AT 25 ON CENTER, RUGIUST FASTEN ALL COUNCELTING PARTIES AND AND MOSTS AS APPROVED BY COVERNING LODGE.

1. SHOP-PRIME AND PAIN THE PLOY, THE PLOY, THE PLOY STROKENION AND INSTALLATION PER THE LATEST EXPINION OF THE RESONANDIAL AND SPECIFICATIONS.

CAPPEDIRY

LIMESS NOTED OTHERWISE, NIMILAU FRAMING LUMBER SHALL BE DOUGLAS FIR

CONSTRUCTION GRADE, BEAMS, HEADERS, AND FLOOR JOISTS SHALL HAVE AN ALLOWAGLE
BENNING STRESS OF 178009.

Z. ALL READERS SHALL BE FREE FROM ALL SPUTS, CHECKS, OR SHALES.

2. ALL READERS SMALL BE FREE PROVIDE:

UNESS NOTE OF DEPARTS PROVIDE:

OUBLE HEADER JUST AND TRUMER AT ALL FLOOR OPENINGS.

OUBLE CONST UNDER ALL PRACLES PARTTONS.

OUBLE SOIST UNDER ALL PRACLES PARTTONS.

TWO ROWS OF 1x3 CROSS BRIDGING OR METAL BRIDGING PER JOIST SPAN.

COUNTER TOP

TWO ROWS OF INS CROSS BRIDGING OR METAL BRIDGING PER JOST SPAN

FLOOR CONSTRUCTION SHALL COMPLY WITH SECTION REG.

FLOOR CONSTRUCTION SHALL COMPLY WITH SECTION REG.

CULTING, MOTGRING, AND BORING OF FLOORING MEMBERS SHALL BE DONE ONLY ACCORDING

TO THE MANUFACTURERS INSTRUCTIONS PER SECTION RIGGS.

STAIR CONSTRUCTION SHALL CONSIST OF (§) 2/13 STRUMERS SHALL BE DONE ONLY ACCORDING

THICK RISES OF TARROCTED BY COALDONED HAMPLACTURES AND RUX THICK TREAD AND JAY

HICK RISES. OF TARROCTED BY COALDONED HAMPLACTURERS BY AND PURLINS TO BE

SIZED AS PRESCRIBED OF LANDETERS OF THE RESPIENTIAL CODE.

ROOF TRUSS LAYOUT IS SCHEMATIC ONLY TRUSS DESIGN INCLUDING SPACING SHALL BE

CETERNINED BY THUSS MANUFACTURED BY WETSPRUSIESE, FEORMA WAY, WASHINGTON,

BENDING STRESS SH-2809D. THIS PRODUCT IS MANUFACTURED FOR OUT OF THE PROPERTY OF THE PROPERTY OF THE PROPERTY OF SHEAT OF THE MANUFACTURER BY WETSPRUSIESE, FEORMA WAY, WASHINGTON,

DINING NOW GENERAL INSTALLATION OF THE PROPOUCTS, NO SUBSTITUTIONS ARE

PERMITTED WITHOUT THE ARCHITECTS WRITTEN DIRECTIONS FOR CUTTING, DRILLING, NOTCHING,

STRUCTURAL LAYOUT AND PLACEMENT OF BEAMS, JOSTS, HEADERS, COLUMNS, ETC., ALONG

WITH CALCULATIONS AND INSTALLATION OF THE REPRODUCTS ON SUBSTITUTIONS ARE

PERMITTED WITHOUT THE ARCHITECTS WRITTEN PROPOURS ANY SUBSTITUTIONS SUBMITTED

BY THE OWNER OR CONTRACTOR SHALL BE ACCOMPANIED BY A WRITTEN REPORT SHOWNS

STRUCTURAL LAYOUT AND PLACEMENT OF BEAMS, JOSTS, HEADERS, COLUMNS, ETC., ALONG

WITH CALCULATIONS AND INSTALLATION OF THE PROPERTY HOURS.

STRUCTURAL LAYOUT AND PLACEMENT OF BEAMS, JOSTS, HEADERS, COLUMNS, ETC., ALONG

WITH CALCULATIONS AND INSTALLATION OF THE PROPERTY HOURS.

STRUCTURAL LAYOUT AND PLACEMENT OF BEAMS, JOSTS, HEADERS, COLUMNS, ETC., ALONG

WITH CALCULATIONS AND INSTALLATION OF THE PROPERTY.

STRUCTURAL LAYOUT AND PLACEMENT OF BEAMS, JOSTS, HEADERS, COLUMNS, BETC, ALONG

WITH CALCULATIONS AND INSTALLATION OF THE PROPERTY.

STRUCTURAL CAPAC

OR SETTER, PROVIDE DOUBLE FRANKING MEMBERS UNDUENTABLE TO SPECIFION.

13. PLYMOOD SHALL CONFORLY TO U.S. PRODUCT STANDARD PS-1, TRICKINES AS SHOWN, APA RATIO SHEATHING EVEN HAULING AND SPACHASP PER APA RECOMMENDATIONS FOR LOCATIONS INTENDED, AND AS REQUIRED BY THE BUILDING CODE.

14. ALL WOOD STRUCTURAL, FRANKING, THIRDING, AND SHATHENS ELEMENTS AND COMPONENTS IN CONTACT WITH CONNETERASONSKY, OR CLOSER TO THE EXPOSED GROUND OR CRAWL SPACES OR UNEXCAVATED AREAS THAN ALLOWED BY CODE SHILL BE FALLY WOOD PRESENTINE-TRACTED IN ACCORDANCE WITH SECTION ATTS. PROTECTION OF WOOD AND WOOD-BASED PRODUCTS AGAINST DECAY.

15. OPENINGS IN THE BUILDING ENVELOPE (DOORS, WINDOWS, UTILITIES) TO BE CAULKED, WEATHERSTRUPED, OR OTHERWISS SEALED.

16. CONTRACTOR SHALL BE RESPONSIBLE FOR ALL CONSTRUCTION MEANS, METHODS, TECHNIQUES, SEQUENCES AND SAFETY PREGLATIONS IN CONNECTION WITH THE WORK.

INSULATION, GYPSUM BOARD, AND FINISHES; MINIMUM REQUIRED THERMAL PERFORMANCE PER TABLE 402.1.2 ECCCNYS (CLIMATE ZONE 5).

CEILINGS EXTERIOR WOOD FRAME WALLS FLOORS BASEMENT WALLS

 $\triangle$ 

R-49 R-20 (ALT.: R-13 CAVITY + R-5 CONTINUOUS) R-30 R-39 R-15 (CONTINUOUS EXTERIOR OR INTERIOR INSULATION)

R-19 (CONTINUOUS CANTY INSULATION AT INTERIOR)
R-19 (CONTY INSULATION AT INTERIOR)
R-5 (CONTY INSULATION AT INTERIOR WITH
R-5 CONTINUOUS INSULATION AT INTERIOR OR EXTERIOR)
R-5 (UNDER FULL AREA OF THE HEATED SLAB)


SLAB (HEATED) BUILDING ENERGY EFFICIENCY SHALL COMPLY WITH THE REQUIREMENTS OF CHAPTER 11 OF THE RESIDENTIAL BUILDING CODE AND CHAPTER 1 (RESIDENTIAL) OF THE ENERGY CONSERVATION

BLOWING REPORTED INSULATION AT ROOFS, CEILINGS, WALLS.
FOR SPRAYED POLYDISTHME FORM, (SPF) INSULATION, THE INSTALLED THICKNESS OF THE ROOF SOCKERS HOW THE AVAILED OF THE INSTALLED THICKNESS SHALL BE INDICATED ON THE GENTRICATION, FRET THE RECOMPRISE HAS OF SECTION HIGH 10.3.
MITERIAL SHOW INSTALLATION SHALL COMPLY WITH SECTION HIGH. 10.1. THE THICKNESS OF SPRAYED FREE ROLASS AND CELL MOSE INSULATION SHALL BE WRITTEN HINCHES ON MARKERS HAS ALL BOT A BANKHAIM OF ONE FREE RECOMPLY WITH SECTION HISTORY. THE THICKNESS OF THICKNESS AND AVAILE OF SPRAYED POLYMERITHME FORM INSULATION SHALL BE INDICATED ON THE CERTIFICATION PROVIDED BY THE PRISALITION HISTORY. BY ALL BE INDICATED ON THE CERTIFICATION PROVIDED BY THE PRISALITION HISTORY. BY ALL BE INDICATED ON THE CERTIFICATION PROVIDED BY THE PRISALITION HISTORY. BY ALL BE INDICATED ON THE CERTIFICATION PROVIDED BY THE PRISALITION HISTORY. BY ALL BY A

ALL MATERIALS USED IN THIS PROJECT SHALL BE WON-ASSESTOS AND NOTH EAD CONTAINING, INSTALL SIDE WALL AND CEILING INSULATION IN CONTRIVIOUS BLANKETS WITHOUT HOLES FOR ELECTRICAL BOXES AND INDITION INSULATION. LICENSTRUCTION, SHALL LICENSTRUCTION, SHALL BE 1-107-219 FT. WISJLATED SHEATHING PARKEL INSTALL PER THE MANUFACTURES INSTALLCTION AND 10 COUNTY WITH ALL APPLICABLE CODES. ALL INTERIOR WALLS ARE TO BE COVERED WITH 107 COPPSIAN WALL BOARD, USE 37 CYPSIAN BOARD ON CELLINGS WITH JOSTS, ARE TERROR OF TRUSSES AT 27 ON. OF SHORN (OPTIONAL USE AT 16" OC. CELLING MEMBER SPACING), FIRISH WITH METAL CORNER REINFORCING, TAPE FLOAT AND SAND ()


GARAGE WALLS AND CELLINGS CONTAIN TO THE HOUSE ARE TO BE COVERED WITH ONE LAYER 10.

GYPSUM BOARD, INSTALLED IN COMPLIANCE WITH SECTION R3026.
7. USE WATER RESISTANT GYPSUM BOARD FOR WALLS AND CEILINGS IN ALL BATH AND TOILET AREAS.

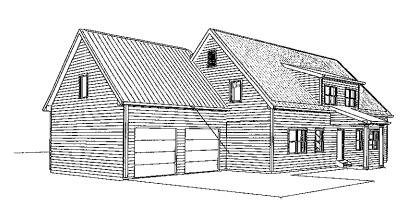

1) PERSPECTIVE VIEW

PERSPECTIVE VIEWS ARE FOR INFORMATION ONLY, NOT FOR CONSTRUCTION PURPOSES

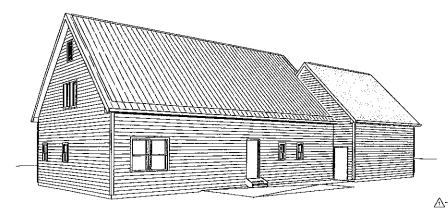

2 PERSPECTIVE VIEW

PERSPECTIVE VIEWS ARE FOR INFORMATION ONLY, NOT FOR CONSTRUCTION PURPOSES



**CODE SUMMARY** 

NAME OF PROJECT DICEY-BUCCINA RESIDENCE ADDRESS 6455 SALT ROAD - CLARENCE, NEW YORK 1403) OWNERS: SCOTT DICEY AND MICHELE BUCCINNA BUILDING TYPE: NEW SINGLE FAMILY HOUSE WY ATTACHED GARAGE PROPOSED USE: R-3 SINGLE-FAMILY RESIDENTIAL CODE AND ZONING ENFORECEMENT: TOWN OF CLARENCE, NEW YORK

APPLICABLE BUILDING CODES - NEW YORK STATE 2020 2020 RESIDENTIAL CODE OTHER NEW YORK STATE CODES AS REFERENCED

EDWIN E. SMART, AIA smartDESIGN ARCHITECTURE, PLLC 585,345,4067

BUILDING DATA BUILDING HEIGHT:

ZONING REQUIREMENTS
ZONING DISTRICT: AGRICULTURAL-RESIDENTIAL A-RE

1. MINIMUM LOT WIDTH: 100.0 FEET (ALLOWED PER SECTION 229-40 (BH

2. SETBACKS (SECTION 229-41,8 (2):

REPORT AND DIRECTIONS

3. BUILDING HEIGHT (SECTION 229-43 (A): 35 FEET

4. LOT COVERAGE (SECTION 229-45) 19.8% FOR A TWO-STORY STRUCTURE INCLUDING GARAGE

DESIGN I	LOADS	
THE FOLLOWING DESIGN LOADS HAVE BEEN USED IN THE DESIGN OF THE STRUCTURE IN ACCORDANCE WITH THE PRINTED TABLES IN THE RESIDENTIAL CODE OF NEW YORK STATE:	LIVE LOAD (TABLE 301.5)	DEAD LOAD
ROOF	50 PSF	10 PSF
SLEEPING ROOMS	30 PSF	12 PSF
NON-SLEEPING ROOMS	40 PSF	12 PSF
EXTERIOR BALCONIES/DECKS	40 PSF	12 PSF

SHEET INDEX MATRIX

SCOTT DICRY AND MICHELE BUCCINIV CORFU, NEW YORK 14036 585,402,8077

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> structural consultant

> MEP consultant

RESIDENCE 6455 SALT ROAD ARENCE, NEW YORK 1

DICEY-BUCCINNA



revision schedule description date


> drawing information

project #. dale: drawn by. 08,05.2024 TEAMK EES

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**COVER SHEET** 

86"-0" TO 87"-0" MAXIMUM 227' - 0" +4-SETBACK (FROM EDGE OF ROAD) SETBACK 349 01 GARAGE HOUSE 353.55 3 SITE PLAN - SCHEMATIC NOTE:
1. SITE PLANTS EXPENDENT OR SHOWN FOR THE PURPOSES OF DEMONSTRATING COUPLINNCE WITH ZOIMING CODE YARD SETBACK REQUIREMENTS ORLY.
2. THIS PLANTS EXPENDED FROM A SURVEY BY WILLIARD, MCKAY A DELIES OF SIBLE 45 ON-145 13, DATED 10-11-22/20,
3. THE OWNERS SHALL SLIVENT A COPY OF THE PARCEL BOUNDARY SURVEY AND DAY OTHER STIEL INFORMATION AS REQUIRED BY THE TOWN OF CLARENCE PLANNING, ZOWING, AND/OR BUILDING DEPARTMENTS FOR PROJECT APPROVALS
4. THE OWNERS SHALL SLIVENT ARE PRADMINGED FOR THE PROJECT LIMPER SPRANTE COVER.
5. CARAGE LOCATION AND CONSTRUCTION AS SHOWN IS CONDITIONAL PENDING THE OWNERS APLICATION TO THE ZOWING BOARD OF APPEALS FOR AN AREA VARIANCE AT SIDE SETBACK (15-47 REQUIRED).

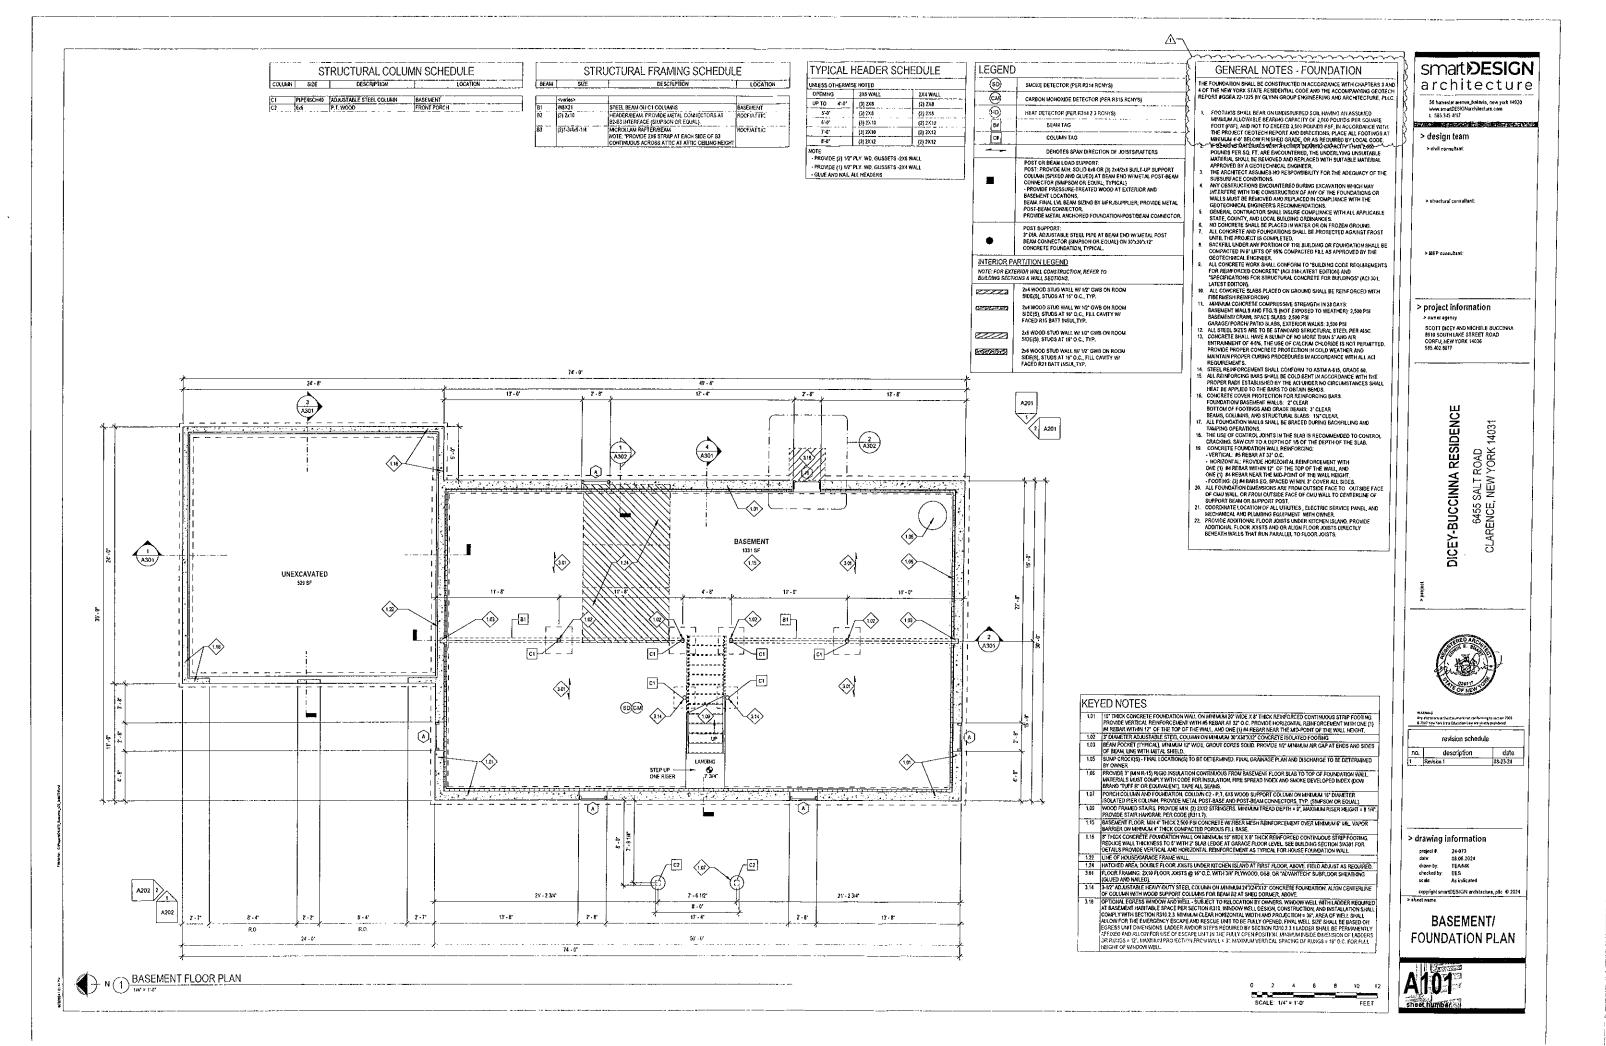

	S	FRUCTURAL COLU	IMN SCHEDULE
COLUMN	SIZE	DESCRIPTION	LOCATION
Č1	PIPE4SCH40	ADJUSTABLE STEEL COLUMN	BASEMENT
C2	6x5	P.T. WOOD	FRONT PORCH

24' - 0" +/- FIELD ADJUST

CONCRETE PATIO

(114)

A301

MIN CLEARS

(x)

1.19 (11)

PORCH

7-61/2

6.-0.

7ABLE 72'x30'

(ii)

HALLWAY

W.I.C

56 SF

BATHROOM 1

**(B)** 

(SD(CM)

**6** 

7 1700000

(5)

60"X30" UB/SHOWER

A302

LIVING ROOM (SD)

3.01

CONCRETE WALKWAY

8'-0"

74' - 6"

27' - 6"

(11¢)

STRUCTURAL FRAMING SCHEDULE					
BEAM	SIZE	DESCRIPTION	LOCATION		
	«vanes»				
B1	W8X21 (2) 2x10	STEEL REAM ON C1 COLUMNS PEADER/SEAM PROVIDE METAL CONNECTORS AT	BASEMENT ROOF/ATTIC		
B3	(2)1-314x9-1/4	22-83 INTERFACE (SIMPSON OR EQUAL).  MCROLLAN RATTERBEAM  NOTE: "PROVIDE 2X6 STRAP AT EACH SIDE OF 83  CONTINUOUS ACROSS ATTIC AT ATTIC CELLING HEIGHT	ROOFIATTIC		

BEDROOM 2

126 SF

CLOSET

<del>-(11)</del>

QUEEN 60'X79"

3.01

12 - 10

(SD)

BEDROOM 1

TYPICAL HEADER SCHEDULE						
UMLESS OTHERWISE NOTED						
OPENING	2X6 WALL	2X4 WALL				

PENIKG	2X6 WALL	2X4 WALL
PTO 4'-0'	(3) 2X8	{2} 2X8
5'-0'	(3) 2X8	{2} 2X8
6'-0"	(3) 2X10	(2) 2×10
7:-0*	(3) 2X10	(2) 2X12
80.	(3) 2X12	(2) 2X12


· PROVIDE (2) 1/2" PLY, WD, GUSSETS -2X6 WALL - PROVIDE (1) 1/2" PLY, WD, GUSSETS -2X4 WALL - GLUE AND NAIL ALL HEADERS

## GENERAL NOTES

- ALL ROOMAYALL DIMENSIONS ARE EXTERIOR FACE OF FRAMING TO CERTERLINE OF INTERIOR WALLS, ALL FOUNDATION WALL DIMENSIONS ARE FROM DUTISIDE FACE TO OUTSIDE FACE OF COMUCONOREST WALL OF ROOM OUTSIDE FACE OF CMUCONCRETE WALL T
- SUPPORT POST.
  ALL EXTERIOR FRAMED VIALLS TO BE \$25 WOOD STUDS & 16'
  OC, WINER, A21 BATT INSULATION,
  ALL INTERIOR FRAMED WALLS TO BE \$24 WOOD STUDS & 16'
  OC. WINER STORM STUDIES OF STATEMENT OF STATEME
- O.C.
  KITCHEN LAYOUT IS SCHEMATIC ONLY. FINAL CABINET DESIGN
  TO BE DETERMINED BY OTHER. INSTALLATION BY CONTRACTOR
  KITCHEN APPLIANCES PROVIDED BY OWNER AND INSTALLED BY

## POST & BEAM NOTES:

- BEARING PROVIDE MINMAM 12.25 SQUARE INCHES (2) 224 BULTLEP POST) SQUE CONTINUOUS BEARING AT ALL MICROLLAND BEAM HOSS. ALL VERTICAL SUPPORT MUST BE CONTINUOUS TO FOUNDATION MELOW PROVIDE SQUID BEARING AT FOUNDATION WITH CONN BLOCK CORES RILED SQUE GROUT FAUL HEIGHT MINMAM 2-8" WIDTH (12) CMU UNITS WIDE).
- CONNECTIONS, PROVIDE METAL CONNECTORS AS REQUIRED: POST-TO-BEAM, RAFTER-TO-RIDGE BEAM, RIDGE-TO-RIDGE BEAM, ETC. (SIMPSON STRONG-TIE OR EQUAL).
- SPECIFICATIONS, MICROLLAM LVI, BEAMS ARE SPECIFIED.
  THE CONTRACTOR SHALL VERIFY AND FINALIZE THE BEAM
  LAYOUT AND SPECIFICATIONS MITH THE
  MANK-ACTURER/SUPPLIER (WEVER-MEUSER)BEFORE
  CONSTRUCTION AND SUBSTITUTIONS ARE PERMITTED
  WITHOUT WRITTEN CONSENT OF THE ARCHITECT AND
  WRITTEN CALCULATIONS AND SPECIFICATIONS BY THE
  ALTERNATE MANK-ACTURER.

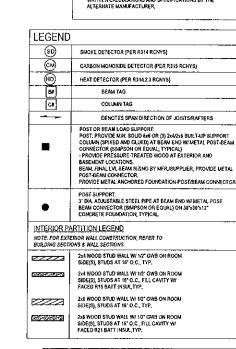

200-000 DECEMBER	SIDE(S), STUDS AT 16" O.C., FILL CAVITY W/ FACED R21 BATT INSU, TYP.
Les es	DHOTEO
KEYE	D NOTES
R	MRAGE FLOOR, MIN 4" THICK 3,500 PSI CONCRETE WI FIBER MESH EINFORCEMENT OVER MIN 6" MIL VAPOR BARRIER ON MON 6" THICK OMPACTED POROUS FILL BASE, OPTIONAL: SXEXIO WWWF EINFORCEMENT WITHIN CONCRETE SIAB, SLOPE TO DOORS.
T H	KOOD FRAMED STAIRS, PROVIDE MIN. (3) 2X12 STRINGERS, MINIMUM READ DEPTH = 9", MAXIMUM RISER HEIGHT = 8 1/4", PROVIDE STAIR MINDRAF, PER CODE (R311.7).
0 S	ROVIDE FIRE SEPPARATION AT ALL SHARED HOUSE CARAGE WALLS WI NE (I) LAYER MY GYBE APPLED TO THE GARGE SIDE HORIZONTAL EPARATION AT FLOOR-CEILING ASSEMBLY. ONE (I) LAYER 58" TYPE X WIG OVER THE STRUTTURE AT GARGE SIDE, TAPE AND FIRMSH ALL EAMS AND JOHN'S PER CODE REQUIRELEMENT.
	OUSE FRAME WALL: 2X6 WOOD STUDS @ 16" O.C., TYP.
C	XTERIOR HARDSCAPE, TYPICAL: MIMIRIA 4" THICK FIBER-REINFORCED ONCRETE SLABON-GRADE OVER MINIMAN 4" COMPACTED POROUS FI LIBERNATE: CONCRETE UNIT PAVERS OR OTHER CONCRETE, BRICK, TIL R STONE UNIT PAVERS OVER APPROVED SUBSTRATE,
P.	XTERIOR STAIRS FROM HOUSE MAIN FLOOR DOWN TO GRADE, PROVID IT. 2X12 STRINGERS, MINIMUM TREAD DEPTH=9", MAXIMUM RISER EIGHT=8 14", PROVIDE STAIR HANDRAIL PER CODE(R311.7)
FL	ATCHED AREA DOUBLE FLOOR JOISTS UNDER NITCHEN ISLAND AT FIR LOOR, ABOVE, FIELD ADJUST AS REQUIRED,
C	PEN RAILING, RAILING AND GUARD MATERIALS TÉD. ASSEMBLY SHALL DWPLY WITH REQUIREMENTS OF SECTION R311,7,8.
Oi	TCHEN LAYOUT IS SCHEMATIC AS SHOWN FOR PLAVINING PURPOSES HLY. FINAL DESIGN AND SPECIFICATION OF CABINETS, COUNTERTOPS, XTURES, AND APPLIANCES TBD BY OWNERS.
3.01 FL	.OOR FRAMING: 2X10 FLOOR JOYSTS @ 16" D.C. WITH 3/4" PLYWOOD, DE R "ADVANTECH" SUBFLOOR SHEATHING (GLUED AND NAILED).
TF PF CA	TTIC TRUSS A. USABLE OPEN AREA IS SCHEMATIC AS SHOWN: FINAL RUSS DESIGN BY OTHERS. SEE TRUSS DIAGRAM DIAIN? FOR DETAILS ROWDE M: "I WOODD SUBFLOOR OVER TRUSS BOTTOM CHORD AT PEN USABLE AREA.
\$1	KRAGE FRAME WALL: 1/2" PLYWOOD OR OSB SHEATHING OVER 2X4
	2X4 LAMINATED COLUMN. CONTINUOUS SUPPORT FOR BEAM BZ AT #ED DORMER, ABOVE.

	o ===	2	4	<u>.</u>	8	10	1
	TED COLUM ABOVE.	AN. CONT	INDOUS S	SUPPORT	FOR BEA	M B2 AT	
RAM 1610	E WALL: 10 ,C.	2. bf AM	000 OR 0	SB SHEA	FHING OV	ER 2X4	
BLE	1 YWOOD S AREA						
	BY OTHER						
	A. USABLE	COLLING					

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> DICEY-BUCCINNA RESIDENCE SALT ROAD ; NEW YORK 1 6455 S CLARENCE, N



revision schedule description date

> drawing information

24-073 08.06.2024 TEAMK EES As indicated copyright smartDESIGN architecture, ptc © 2024 > sheet name

FIRST FLOOR PLAN

1) FIRST FLOOR PLAN

A202 2

A202

A301

24' - 3 1/2"

(HD) GARAGE

551 SF (1.08) (3.08)

6" - 10"

MUDROOM 86 SF

LOSET(12)

STRUCTURAL COLUMN SCHEDULE DESCRIPTION 

STRUCTURAL FRAMING SCHEDULE					
BEAM	SIZE	DESCRIPTION	LOCATION		
	<pre><pre><pre><pre><pre><pre><pre><pre></pre></pre></pre></pre></pre></pre></pre></pre>	<del></del>	T		
61	W8X21	STEEL BEAM ON CI COLUMNS	BASEMENT		
82	(2) 2x10	HEADER/REAM, PROVIDE METAL CONNECTORS AT 82-83 INTERFACE (SIMPSON OR FOUAL).	ROCF/ATTIC		
B3	(2)1-3/4x9-1/4	MICROLLAM RAFTER/BEAM NOTE: "PROVIDE 2X6 STRAP AT EACH SIDE OF 83	ROOF/ATTIC		

TYPICAL HEADER SCHEDULE			
UNLESS OTHERWI	SE NOTED		
OPENING	2X6 WALL	2X4 WALL	
UP TO 4'-0"	(3) 2X8	(2) 2X8	

OTE:	
PROVIDE (2) 1/2" PLY, WD. GUSSETS -2X6 WALL	
PROVIDE (1) 1/2" PLY, WD, GUSSETS -2X4 WALL	


OPENING	2X6 WALL	2X4 WALL
UPTO 4-6"	(3) 2X8	(2) 2×8
5).	(3) 2×3	(2) 27/8
6'-0"	(3) 2X10	(2) 2X50
7-0	(3) 2X10	(2) 2X12
80.	(3) 2X12	{2} 2X12

- GLUE AND NAIL ALL HEADERS

## **GENERAL NOTES**

- 1. ALL ROCMANALL DIMENSIONS ARE EXTERIOR FACE OF FRAMINO TO CENTERLINE OF INTERIOR WALLS ALL FOUNDATION WALL DIMENSIONS ARE FROM OUTSIDE FACE TO OUTSIDE FACE OF CHANGEOMERER WALL OF ROOM OUTSIDE FACE OF CHANGEOMERER WALL TO CENTERLINE OF SUPPORT FOR ACR SUPPORT FOR SAME WALLS TO BE 256 WOOD STUDS @ 16" O.C. WALLS THE STEINTLATION.

  ALL INTERIOR FRAMED WALLS TO BE 254 WOOD STUDS @ 11" O.C.
- O.C. KITCHEN LAYOUT IS SCHEMATIC OINLY. FINAL CABINET DESIGN TO BE DETERMINED BY OTHER, INSTALLATION BY CONTRACTOR. KITCHEN APPLIANCES PROVIDED BY OWNER AND INSTALLED BY CONTRACTOR.
- KITCHEN APPLIANCES PROVIDED BY OWNERS AND ACCOMPACTOR CONTRACTOR TO PROVIDE SOLID WOOD BLOCKING FOR ALL CARBIETS, COUNTERS, SHELVING, ETC.
  PROVIDE ACOUSTIC SOUND-ATTENUATING BATT INSULATION IN BATTAROOM WALLS. POST & BEAM NOTES:
- BEARING, PROVIDE MINMUM 12 25 SQUARE INCHES ((2) 2X4 BULT-UP POST) SOUD CONTINUOUS BEARING AT ALL MINGROLLAM BEAMENS ALL VERTICAL SUPPORT MUST BE CONTINUOUS TO FOUNDATION HELDOW, PROVIDE SOUD BEARING AT POUNDATION WITH CAUSE DUCK CORES FULED SOUID GROUT FULL HEIGHT MINMUM 2X4" WIDTH ((2) CAUJ UNITS WIDEL).
- CONNECTIONS: PROVIDE METAL CONNECTORS AS REQUIRED: POST-TO-BEAM, RAFTER-TO-RIDGE BEAM, RIGGE-TO-RIDGE BEAM, ETC. [SIMPSON STRONG-TIE OR EQUAL).
- SPECIFICATIONS MIGROLLAM LVL BEAMS ARE SPECIFIED, THE CONTRACTOR SHALL VERIFY AND FINALIZE THE BEAM LAYOUT AND SPECIFICATIONS WITH THE MANAFACTURER/SUPPLIER (MY-YER/MEUSER/BEFORE CONSTRUCTION ON SUBSTITUTIONS ARE PERMITTED WITHOUT WRITTEN CONSENT OF THE ARCHITECT AND WRITTEN CAUCULATIONS AND SPECIFICATIONS BY THE ALTERNATE MAMFACTURER.

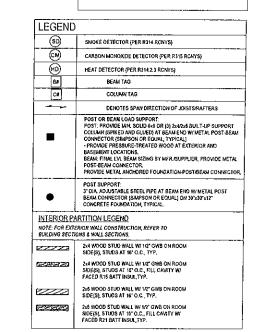

1.09	WOOD FRAMED STAIRS, PROVIDE MIN. (3) 2X12 STRINGERS. MINIMUM TREAD DEPTH = 9", MAXIMUM RISER HEIGHT = 8 1/4". PROVIDE STAIR HANDRAIL PER CODE (R311,7).
1,12	UNUSED FLOOR AREA - LOW HEAD HEIGHT <5"40", TYPICAL
1.13	GARAGE ATTICIATTIC TRUSS, FINAL TRUSS AND USABLE FLOOR AREA DIMENSIONS TBO BY TRUSS ENGINEERS.
1.28	UNUSED AREA - TRUSS WEBBING,
3.02	2X6 CEILING JOISTS @ 16" O.C. W/R-49 ATTIC INSULATION.
3,03	ATTIC AREA SHALL BE UNFINISHED, STAIRWELL WALLS AND DOOR, EXTERIOR GABLE WALLS, AND ATTIC DOOR SHALL BE INSULATED, ALL OTHER INTERIOR WALLS ARE OPTIONAL FOR FUTURE FINISH.
3.08	ATTIC TRUSS A, USABLE OPEN AREA IS SCHEMATIC AS SHOWN FINAL TRUSS DESIGN BY OTHERS, SEE TRUSS DIAGRAM 20.197 FOR DETAILS, PROVIDE 34* PLYWOOD SUBFLOOR OVER TRUSS BOTTOM CHORD AT OPEN USABLE AREA.
3.15	(3) 2X4 LAMINATED COLUMN, CONTINUOUS SUPPORT FOR BEAM 82 AT SHED DORMER, ABOVE.

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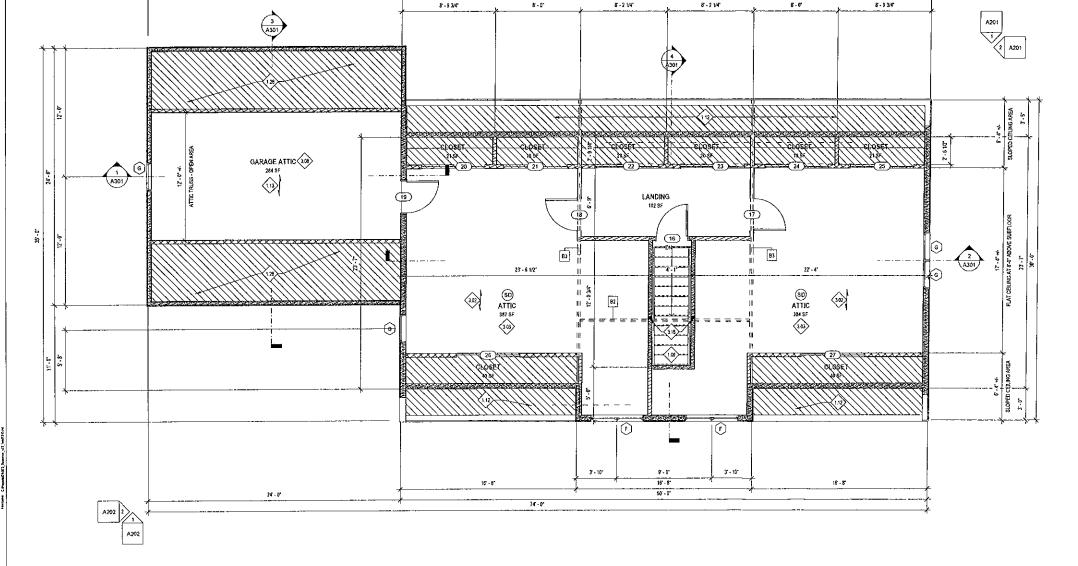
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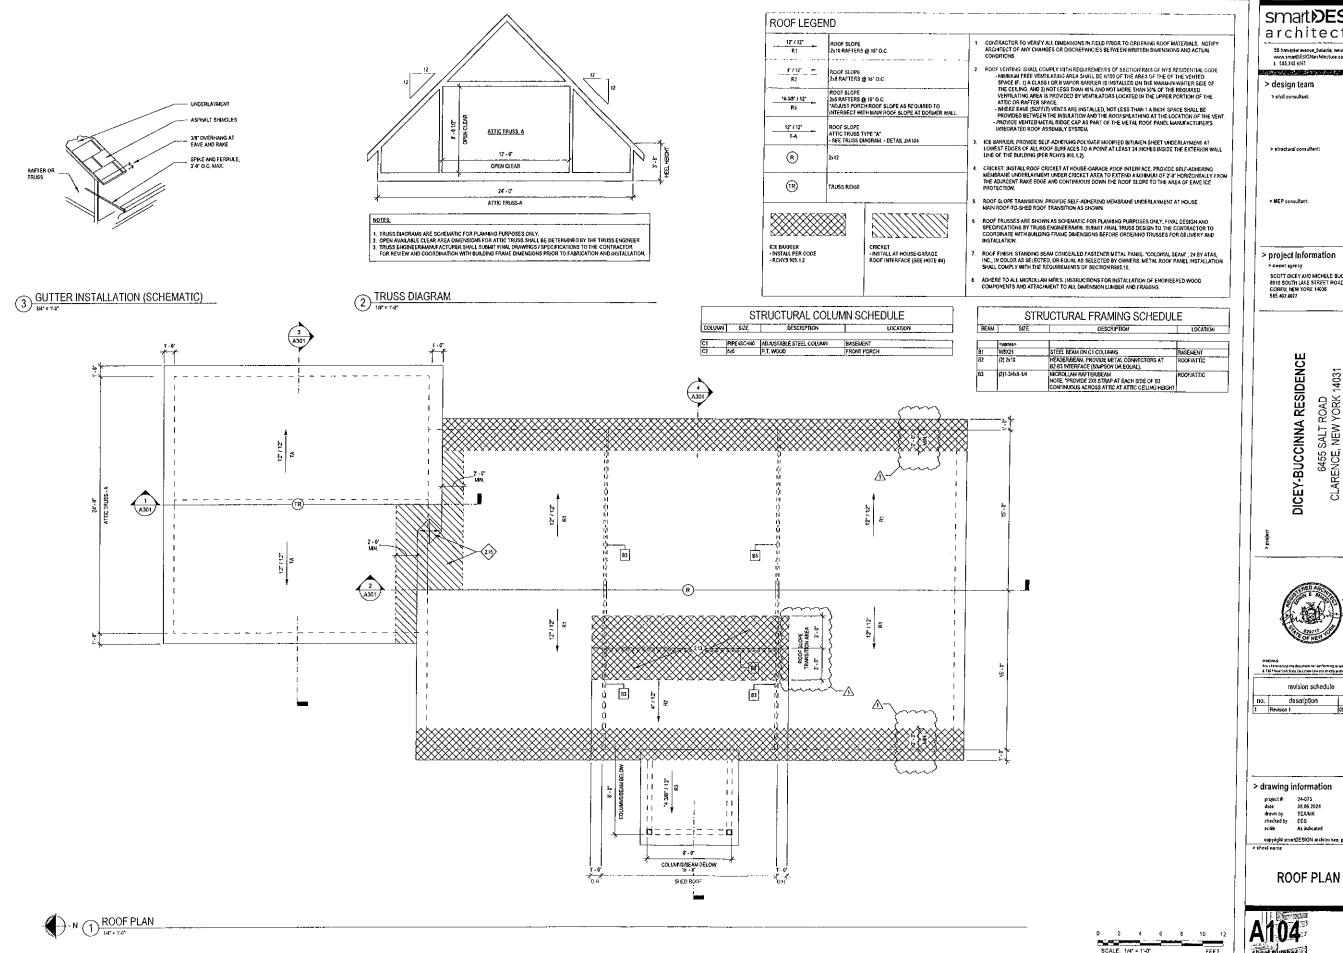
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SECOND FLOOR PLAN



74 - 0\*



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SCOTT DICEY AND MICHELE BUCCINNA 8919 SOUTH LAKE STREET ROAD CORFU, NEW YORK 14036 585,402,8077

DICEY-BUCCINNA RESIDENCE 6455 SALT ROAD CLARENCE, NEW YORK





revision schedule description

> drawing information

project #: 24-073
date: 08.06.7
drawn by. TEAM
checked by. EES
scale As inche 24-073 08.06.2024 TEAMK As indicated

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FASCIA	6*
CORNER BOARDS	4'
EAVE OVERHANGS	1.0.
RAKE OVERHANGS	1.0-
SIENNG	VINYL SIDING IN COLOR/STYLE AS SELECTED BY OWNERS.
ROOFING	ROOF FINISH STANDING SEAM CONCEALED FASTEMER METAL PAVEL IN COLOR AS SELECTED COLOMAL SEAM*; 24 BY ATAS, INC., OR EQUAL. METAL ROOF PAVEL INSTALLATION SHALL COMPLY WITH THE REQUIREMENTS OF SECTION RIPOS.10.
GUTTERS/ DOWNSPOUTS	5' SEAMLESS ALUMINUM GUTTER WITH LEADERS AND DOWNSPOUTS (SITE DRAINAGE TBD BY OLYNER)
MIN. FTG. DEPTH	3'-6" BELOW FINISH GRADE LEVEL, OR AS OTHERWISE DIRECTED BY LOCAL CODE.
TOP PLATE:	
FIRST FLOOR	8'-1 1/8" ABOVE SUBFLOOR
SECOND FLOOR	8"-1 1/8" ABOVE SUBFLOOR
WINDOW HEAD HEIGHT:	
FIRST FLOOR	6'-8" ABOVE SUBFLOOR
SECOND FLOOR	6'-8' ABOVE SUBFLOOR
WINDOW MANUFACTURER	TBO BY OWNER
ROOF VENTING	INTAKE: VENTED VINYL SOFFIT PANEL EXHAUST: CONTINUOUS RIDGE VENT ROOF VENTING SHALL COMPLY WITH REQUIREMENTS OF SECTION ROS OF NYS RESIDENTIAL CODE. SEE ROOF PLAN NOTES SHEET A 104 FOR DETAILS.

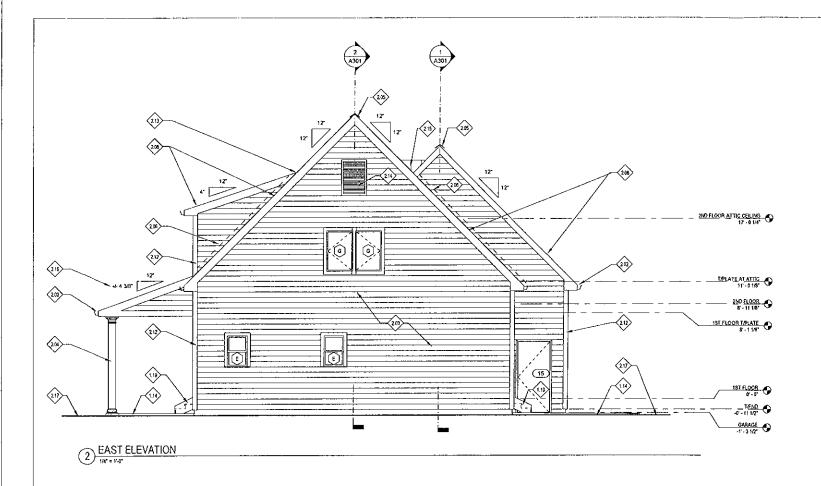1.14	EXTERIOR HARDSCAPE, TYPICAL: MINIMAM 4"TRICK FIBER-REIMFORCED CONDRETE SLAB-ON-GRADE OVER MINIMAM 4"COMPACTED POROUS FILL ALTERNATE CONCRETE UNIT PAVERS ON OTHER CONCRETE, BRICK, TILE, OR STONE UNIT PAVERS OVER APPROVED SUBSTRATE:
1.19	EXTERIOR STAIRS FROM HOUSE MAIN FLOOR DOWN TO GRADE PROVIDE P.T. 2X12 STRINGERS. MINIMUM TREAD DEPTH=9", MAXIMUM RISER HEIGHT=8 1/4", PROVIDE STAIR HANDRAIL PER CODE(R311.7)
2.02	5' SEAMLESS ALUMINUM GUTTER WITH LEADERS AND DOWNSPOUTS, TYPICAL (SITE DRAINAGE TRD BY OWNER)
2.03	HORIZONTAL SIDING AS SELECTED BY OWNER OFTY-EX HOUSE WRAP OF 1/2- CDX APARATED PLYMOOD OR OSB SHEATHING OF 255 WOOD STUDS AT 15" ON WIR AT INSULATION AT WALL CAUTY AND VAPOR RETARDER ON WARM- WINTER SIDE OF INSULATION
2.04	SUPPORT COLUMN FINISH, MATERIALS COORDINATED WITH VINIT, SIDING & TR MANUFACTURERS SYSTEM COMPONENTS, ALTERNATE, AZEK BOARDS AND MANUFIC COMPONENTS, OR COUAL INSTALL PER MANUFACTURERS INSTRUCTIONS.
2,05	ROOF RIDGE VENT: METAL RIDGE CAP AS PART OF THE METAL PANEL MANUFACTURER'S INTEGRATED ROOF SYSTEM SEE ROOF VENTING NOTES A ROOF LEGEND-SHEET AIDA.
2.06	CONCEALED FLASHING, TYPICAL
2.08	ROOF, METAL ROOF PANELS IN STYLE AND COLOR AS SELECTED, INSTALLATIO OF METAL PANEL SYSTEM AND INDEFLAYMENT TO COMPLY WITH SECTION ASSOS, 19.
2.12	4" CORNER TRIM, AZEK OR EQUAL
2.13	ROOF SLOPE TRANSITION: PROVIDE SELF-ADHERING MEMBRANE UNDERLAYMENT AT HOUSE MAIN ROOF-TO-SHED ROOF TRANSITION AS SHOWN AT ROOF PLAN, SHEET A104.
214	DECORATIVE ATTIC VENT TO BE SELECTED BY OWNER
2.15	CRIGHT: INSTALL ROOF CRICKET AT HOUSE-GARAGE ROOF INTERPACE.  ROOMES EST-ADHERING HURRARNE INSPECIAINED TIMES CRICKET AREA.  TO EXTEND A MINIMAN OF 2-0 HORIZONTALLY FROM THE ADJACENT RAKE EXIMO CONTINUOUS COWN THE ROOF SLOPE TO THE AREA OF EAVE ICE.  RROTECTION.
2.17	ASSUMED GRADE
3.15	ADJUST PORCH ROOF SLOPE AS REQUIRED TO INTERSECT WITH MAIN ROOF SLOPE AT DORMER WALL

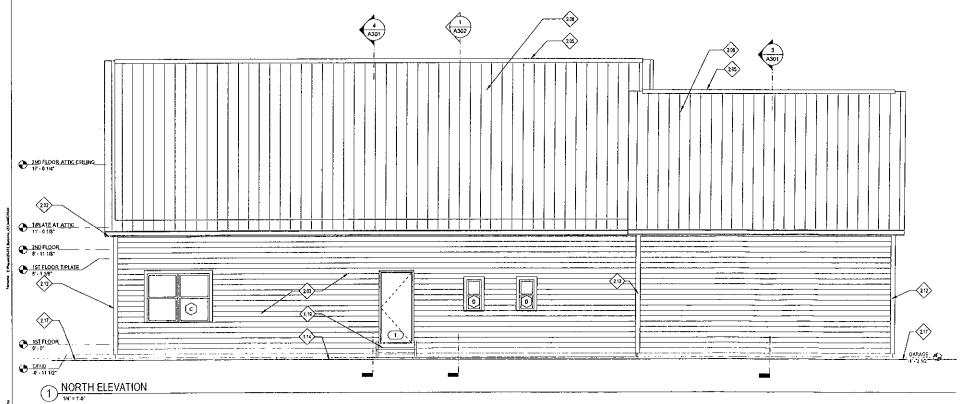CONFIGURATION ABBREVIATIONS: BP - BI-PARTING DS - DOUBLE SWING OH - OVERHEAD DOOR				PO - POCKET DOOR SL - SLIDING DOOR SS - SINGLE SWING	
DOO R#	CONFIGURATION	МОТН	MEIGHT	DESCRIPTION	COMMENTS
GARA 13	GE OH	lo•	lo•	lo	
14	OH	10-	0.	Garage Door Garage Door	
15	ŝs	3 0	6-8	Steel or Fiberglass Door with Wood Frame	
IST FL	OOR SS	12 6		In	
2	SS			Steel or Fiberglass Door with Wood Frame Wood Door with Wood Frame	insulated, Optional; half-life or full glass. Security dead-l
3	55			Wood Door with Wood Frame	Four or six panel, Wood or composite. Privacy locksel,
4	BP			8i-Parting Door with Wood Frame	Four or six panel. Wood or composite.
5	SS			Wood Door with Wood Frame	F. 100
6	SS			Wood Door with Wood Frame	Four or six panel, Wood or composite.
7	SS			Wood Door with Wood Frame	Four or six panel. Wood or composite.  Four or six panel. Wood or composite, Privacy lockset.
8	58			Steel or Fiberglass Door with Wood Frame	Insulated. Optional: half-tite or full glass, Security dead-b
9	SS			Wood Door with Wood Frame	Four or six panel, Wood or composite.
10	55			Wood Ooor with Wood Frame	Four or six panel. Wood or composite.
	SS	3 - 0*		Wood Door with Wood Frame	insulated. Optional; half-lite or full class. Security dead-b
	BP	5 - 0"		Bi-Parting Door with Wood Frame	invalidation operation for the page occurry to the
2ND FL					
		3 - 0		Insulated Wood with Wood Frame	Four or six panel. Wood or composite.
				Wood Door with Wood Frame Wood Door with Wood Frame	Four or six panel. Wood or composite.
	SS	3 0		Vroce Door with Wood Frame	Four or six panel. Wood or composite,
				Siding Door with Wood Frame	Insulated Security dead-bolt lockset Four or six panel, Wood or composite.
				Skiding Door with Wood Frame	Four or six panel. Wood or composite.  Four or six panel. Wood or composite.
				Stiding Door with Wood Frame	Four or six panel. Wood or composite.
				Sliding Door with Wood Frame	Four or six panel, Wood or composite,
				Shaing Door with Wood Frame	Four or six panet, throad or composite.
		6 - 0		Stiding Door with Wood Frame	Four or six panel. Wood or composite.
		5-0		Skiding Door with Wood Frame	Four or six panel, Wood or composite.
		6-0-		Sading Door with Wood Frame	Four or six panel. Whool or composite.
rand to		!	1	Andread & and 1 1 1 1 1 1 1 1 1 1 1 1 1 1 1 1 1 1 1	The same of the party of the pa

AS REQUIRED BY CODE SECTION R310.2				WII	NDOW SCHEDULE
A 2 -8"   1'-3"   S-9"   BASEMENT AMMING UNIT WITH SCREEN  X 5   X   X -8"   3'-8"   3'-2"   BASEMENT CASEMENT UNIT WITH SCREEN EGRESS OPENING WITH WIME  INTERIOR  B   X -9"   4'-8"   Z'-9"   DOUBLE HUNG WISCREEN  B   Z   C   8'-9"   4'-8"   Z'-9"   DOUBLE HUNG WISCREEN  C   3'-9"   4'-8"   Z'-9"   DOUBLE HUNG WISCREEN  D   Y -8"   X -9"   X -9"   DOUBLE HUNG WISCREEN  D   Z - Z - Z - Z - Z - Z - Z - Z - Z - Z	TAG	WIDTH	HEIGHT	SILL HEIGHT	COMMENTS
A 5    M	ASEMENT				
A 5    H   7 - 8"   3 - 8"   3 - 2"	A	2 - 8"	1'-3'	5-9"	BASEMENT AWNING UNIT WITH SCREEN
AS REQUIRED BY CODE SECTION R310.2	5				
IST FLOOR	н	7 - 8"	3 - 6	3 - 2*	BASEMENT CASEMENT UNIT WITH SCREEN, EGRESS OPENING WITH WINDOW WEL AS REQUIRED BY CODE SECTION R310,2
B   3 - 0"   4 - 6"   7 - 0"	1				
B. 2  C   5 - 0'   4' - 8'   2 - 0'	I FLOOR				
C   6 - 0	В	3 - 0"	4'-8"	2 - 0	DOUBLE HUNG W/ SCREEN
C: 3  D   Y - 6"	2				
D   Y - 6'   Y - 0'   X - 0'   DOUABLE HANG W/ SCREEN  2 E   Z - 0'   3 - 0'   3 - 0'   DOUBLE HANG W/ SCREEN  E 2  ND FLOOR  F   S - 0'   4 - 0'   3 - 0'   DOUABLE UNIT (FACTORY MAIL!) DOUBLE HANG.  12	С	6' - 0"	4" - 8"	2-0"	DOUGBLE UNIT (FACTORY MULL) DOUBLE HUNG, EGRESS OPENING AT BEDROOMS AND 2
D: 2  E	3			•	·
E [7-0   3-0   3-0   ] 5-0	D	1'-5'	3 0.	3' - 0"	DOULBLE HUNG W/ SCREEN
E 2  NO FLOOR  F   S-0'   4-0'   3-0'	2				
DOLLBLE UNIT (FACTORY MULL) DOUBLE MANO.  F   S - 0"   4 - 0"   3 - 0"	E	2 - 0"	30,	3 - 0*	DOUBLE HUNG W/ SCREEN
F   5 - 0"   4' - 0"   3' - 0"   DOULBLE UNIT (FACTORY ARULL) DOUBLE HURG. F: 2	2				
F   5 - 0"   4" - 0"   3" - 0"   DOULBLE UNIT (FACTORY MULL) DOUBLE HUNG. F: 2					
F. 2					
		5 - 0"	4'-0'	3-0"	DOULBLE UNIT (FACTORY MULL) DOUBLE HUNG.
		2' - 8'	4' - 0"	3 - 0	CASEMENT UNIT, EGRESS OPENING.
G 4 Orand total 21					

0	2	4	6	8	10	1
	ALE: 1/	4" = 1'-0"			FE	ΕT



55 harvester avenue\_batavia, new york 14020 www.smart06910/Narchitecture.com t\_685,345,4257

> design team

atructoral consultant:

> MEP consultant:

> project information

SCOTT DICEY AND MICHELE BUCCINNA 8910 SOUTH LAKE STREET ROAD CORFU, NEW YORK 14036 585.402.8077

> DICEY-BUCCINNA RESIDENCE 6455 SALT ROAD CLARENCE, NEW YORK 14031



WARRING
Any alterations to this document not conforming to section 7303
§ 7307 New York State Solutation Law are strately prohibited

revision schedule

no. description date


> drawing information

project #. 24-073
date: 08.06.2024
drawn by. TEAAMK
checked by: EES
scale 1/4" = 1'-0"

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ELEVATIONS


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CORNER BOARDS	ar .
EAVE OVERHUUGS	1.0.
RAKE OVERHANGS	1.0.
SIDING	VINYL SIDING IN COLOR/STYLE AS SELECTED BY OWNERS,
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MIN. FTG. DEPTH	3'-6' BELOW FINISH GRADE LEVEL, OR AS OTHERWISE DIRECTED BY LOCAL CODE.
TOP PLATE:	<del></del> _
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WINDOW HEAD HEIGHT:	
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WINDOW MANUFACTURER	TBD BY OWNER
ROOF VENTING	INTAKE: VENTED VINYL SOFFIT PANEL EXHAUST: CONTINUOUS RIDGE VENT ROOF VENTING SHALL COMPLY WITH REQUIREMENTS OF SECTION ROOF OF RESIDENTIAL CODE. SEE ROOF PLAN NOTES SHEET A104 FOR DETAILS.

KEYED	NOTES
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1, 19	EXTERIOR STARS FROM HOUSE MAIN FLOOR DOWN TO GRADE. FROM DE P.1 2X12 STRINGERS, MINIMAIN TREAD DEPTHES!, MAXIMUM RISER HEIGHT-8 IM PROVIDE STAR HANDRAIL PER CODERS11.7)
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2.17	ASSUMED GRADE
3.16	ADJUST PORCH ROOF SLOPE AS REQUIRED TO INTERSECT WITH MAIN ROOF SLOPE AT DORMER WALL.

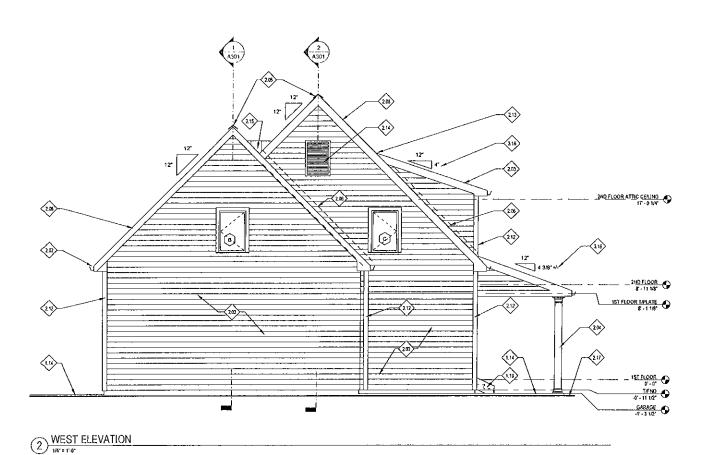



56 harvester avenue\_batavia, new york 14020 www.smart0ESIGNarchitecture.com t 585,345,4567
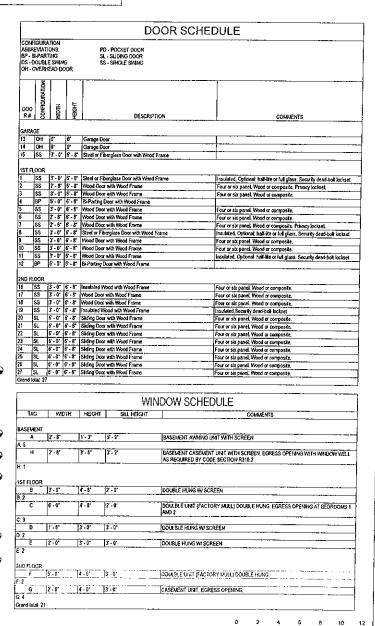
> design team

> atructural consultant:

> project information

> owner agency
SCOTT DICEY AND MICHELE BUCCINNA
8910 SOUTH LAKE STREET ROAD
CORFU, INEW YORK 14036
585,402,8077

DICEY-BUCCINNA RESIDENCE 6455 SALT ROAD CLARENCE, NEW YORK 14031

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revision schedule

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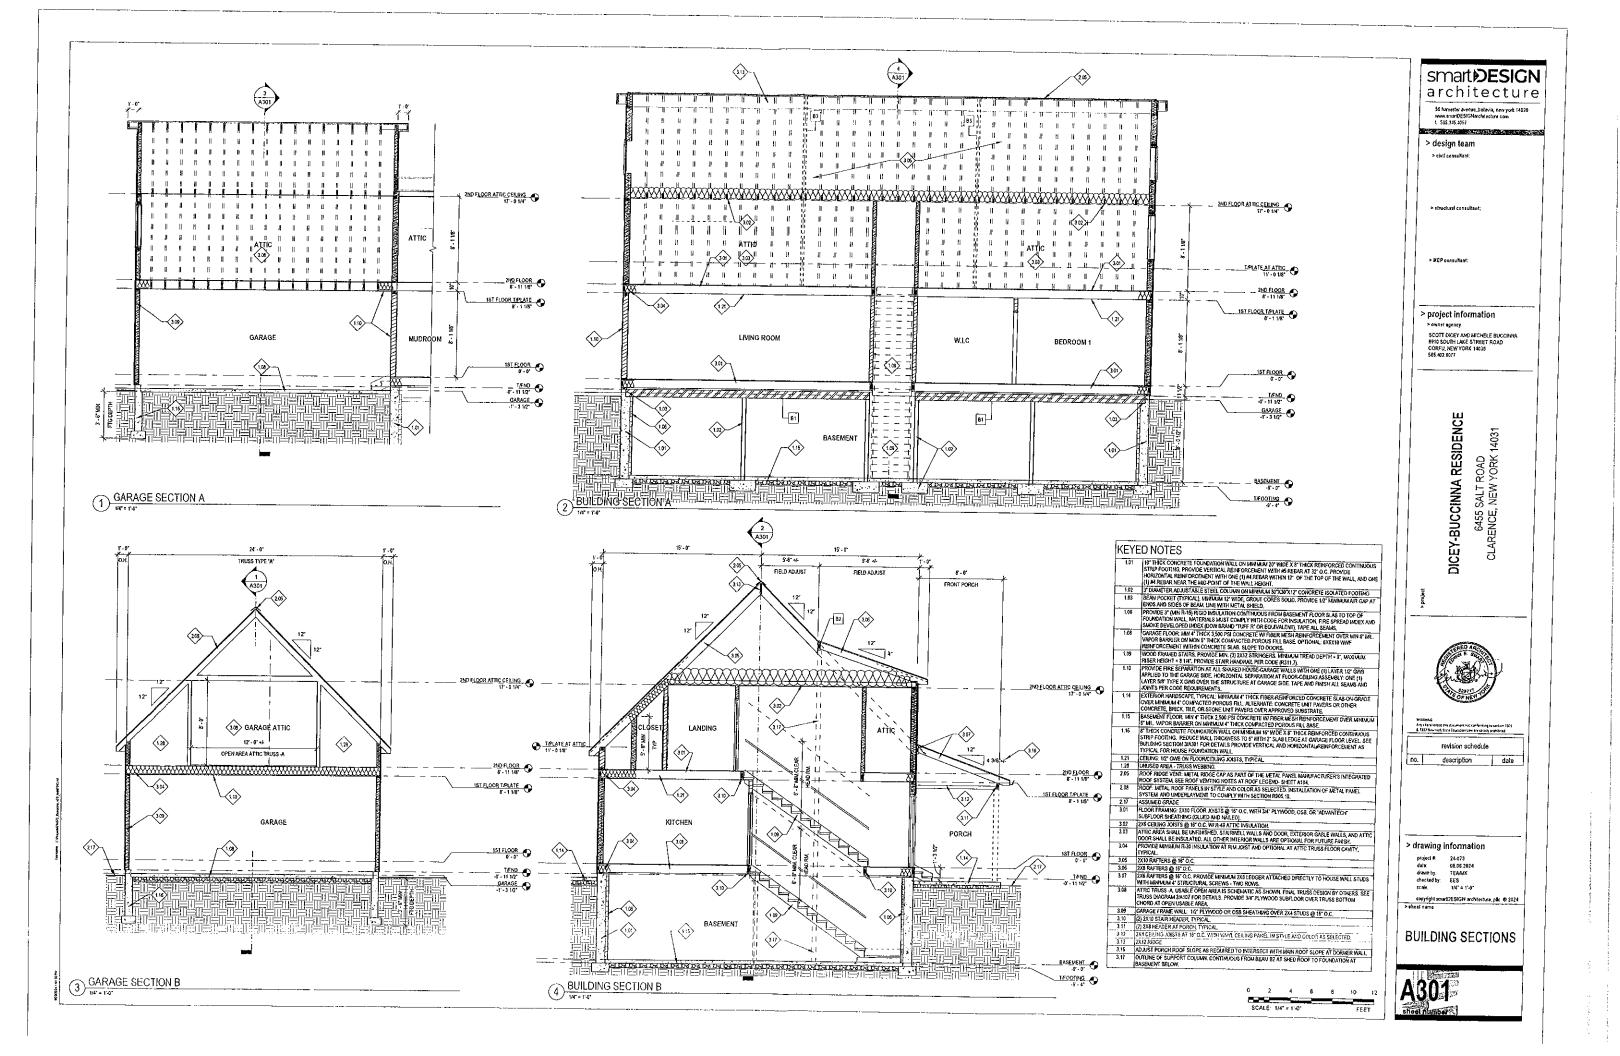
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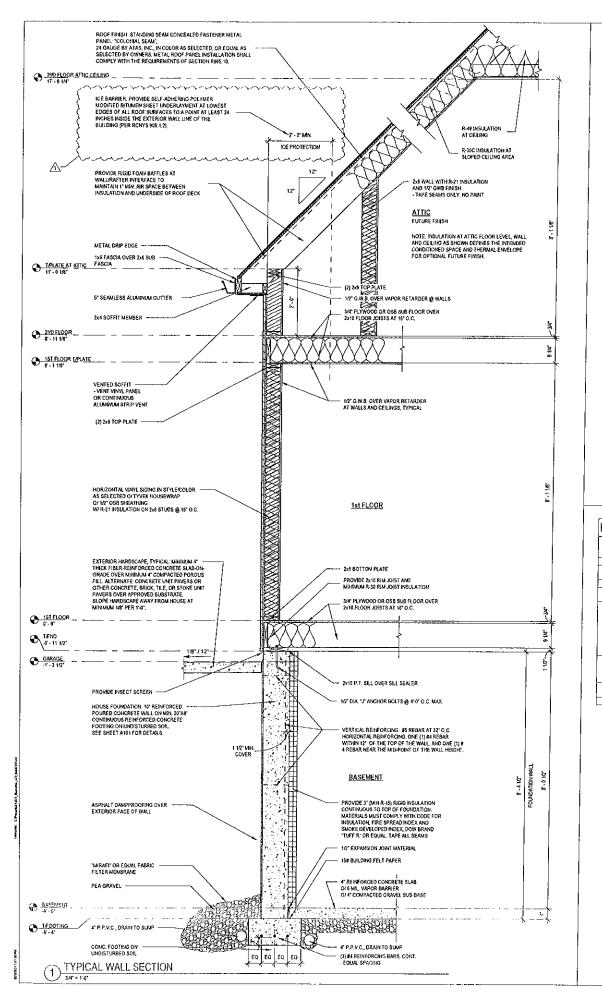
project #: 24-073
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checked by EES
scale As indicated


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**ELEVATIONS** 









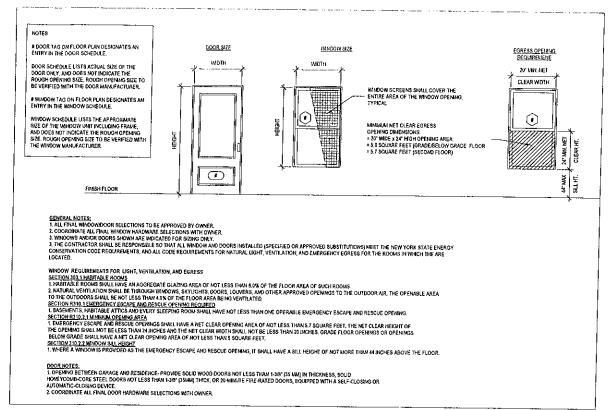

3 WINDOW AND DOOR NOTES

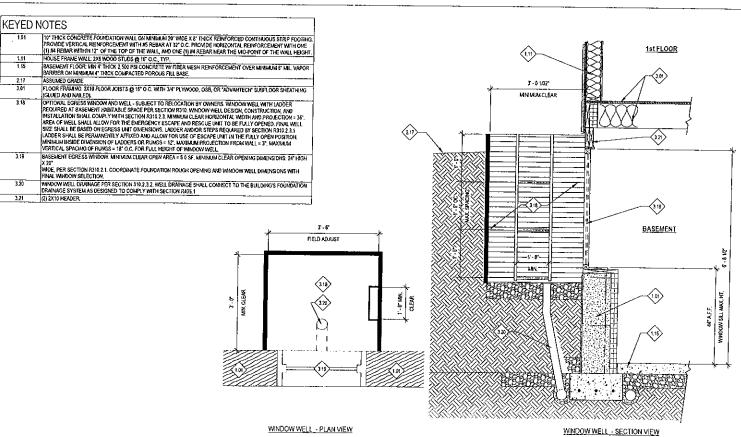

2 BASEMENT EGRESS WINDOW WELL

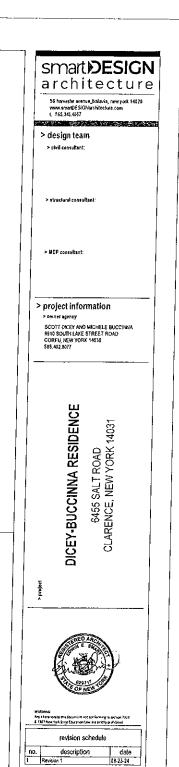

> drawing information

24-073 08.06.2024

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SCHEDULES, WALL **SECTIONS & DETAILS** 





## **Request for Action**

Town of Clarence | Office of Planning & Zoning (716)741-8933 | 1 Town Place, Clarence, NY 14031

## **Town Use Only**

Date: August 13, 2024

Received By: Planning & Zoning Office

Project Address: 5715 Salt Road

**SBL #:** 59.00-4-37.112

## **Action Desired:**

Applicant requests a variance of 1' to allow a detached accessory structure (gazebo) to have a 5' setback from the principal structure located at 5715 Salt Road in the Agricultural Rural Residential zone.

## Reason:

**APPLICANT REQUEST:** 

Town Code Reference: §229-44(F)(4)

		APPLICANT INFO
	Name / Business:	Kelli McKeever
	E-Mail:	
	Phone #:	ONFILE
FO	Address:	ONI
T IN	Town:	State: Zip:
Q	<del></del>	
¥	I	PROJECT SPONSOR INFO (If Different Than Applicant)
CONTA	Name / Business:	PROJECT SPONSOR INFO (If Different Than Applicant)
CONTACT INFO:		
CONTA	Name / Business:	
CONTA	Name / Business: E-Mail:	PROJECT SPONSOR INFO (II Different Than Applicant)  ON FILE

## CORRESPONDENCE

Please indicate the preferred entity that shall receive the appropriate correspondence and billing associated with this Request for Action.

Please select only one.

<b>√</b>	Applicant
	Project Sponsor

## **SIGNATURE**

Request for Action shall be filled out completely in the spaces provided. The complete Request for Action shall be submitted to the Office of Planning and Zoning along with all necessary plans, maps, and supporting documentation. By signing below I certify that I have the authority to submit this Request for Action, and further certify its contents to be true and correct.

signed: Signature On File

## Town Use Only:

	D.	0	Fee:	Paid:	
Action:	By:	On:	Fee,	- alu.	
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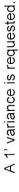


\*\*\*note the parcel lines displayed are approximate\*\*\*

## 5715 Salt Road



The minimum accessory structure setback from the principal structure is 6'.





CONTACT INFO:



# **Request for Action**

Town of Clarence | Office of Planning & Zoning (716)741-8933 | 1 Town Place, Clarence, NY 14031

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				 -				

Date:

3/22/21

Received By:

A Schaefer

Project Address: 5715 Salt Rd, Clarence Ny 14031
SBL#: 59 00-4-37 112

Action Desired: Variance of one foot to allow a metal (aluminum)
gazebo to be installed five feet from principal
structure

Reason: We are having a concrete patio poured with footings to attach a 14 foot x 20 foot gazebo and would like the gazebo to Start 5 feet away from the house to fit the space allotted best

APPLICANT INFO					
Name <del>/ Busines</del> s:	Kelli McKeever				
E-Mail:	<b>b</b>				
Phone #:					
Address:					
Town:					
F	PROJECT SPONSOR INFO (If Different Than Fay (cant)				
Name / Business:					
E-Mail:					
Phone #:					
Address:					
Town;	State: Zip:				

# SIGNATURE

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Signed:


# CORRESPONDENCE


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Please select only one.

X	Applicant
•	Project Sponser

Action:	Ву:	On:	Fee:	Paid:	
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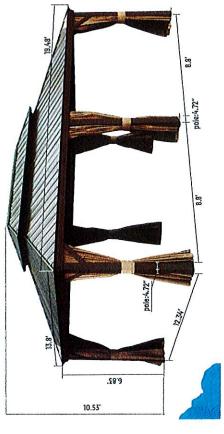





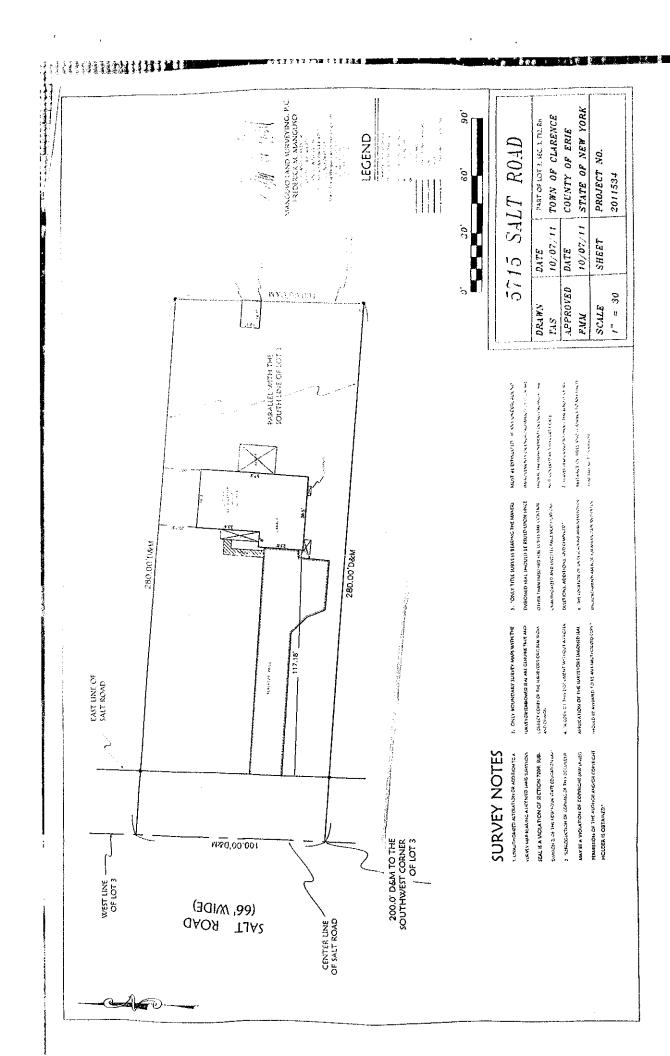

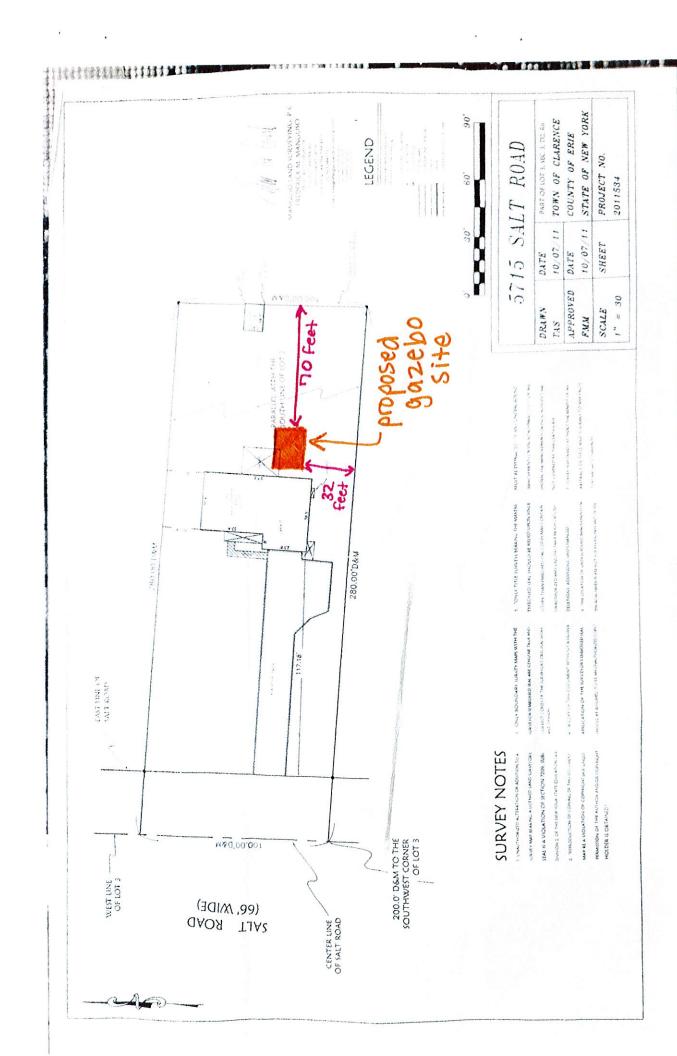
# Hardtop Gazebo 14\*20 FT

Creat a comfortable and safe outdoor retreat in the yard for your family and friends.



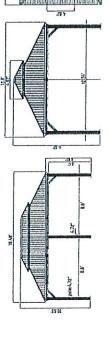

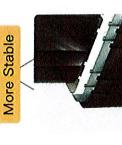

More Durable

More Sturdy












Triangular Structure

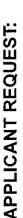



# **Request for Action**

Town of Clarence | Office of Planning & Zoning (716)741-8933 | 1 Town Place, Clarence, NY 14031

# **Town Use Only**

Date: August 19, 2024

Received By: Planning & Zoning Office

Project Address: 5175 Old Goodrich Road

SBL #: 58.18-4-16.2

# **Action Desired:**

Applicant requests variances:

1) to allow a secondary detached garage (pole barn); and

2) of 412 sq.ft. to allow a 612 sq.ft. detached accessory structure (pole barn); and

3) of 1' to allow a 10' tall overhead garage door; and

4) to allow an accessory structure (pole barn) greater than 400 sq.ft. to use materials different from the principal structure;

located at 5175 Old Goodrich Road in the Residential Single-Family zone.

# Reason:

Town Code Reference:

1)§229-55(H)

2)§229-55(H)

3)§229-55(I)

4)§229-55(F)

	APPLICANT INFO
Name / Business:	Matthew Reid
E-Mail:	
Phone #:	ONFILE
Address:	ON'
Town:	State: Zip:
	PROJECT SPONSOR INFO (If Different Than Applicant) Parco Building Systems
E-Mail:	
Phone #:	ONFILE
Address:	04.
Town:	State: Zip:

# CORRESPONDENCE

Please indicate the preferred entity that shall receive the appropriate correspondence and billing associated with this Request for Action.

Please select only one.

1	Applicant	
	Project Sponsor	

# SIGNATURE


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Signed: Signature On File

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Action:	Ву:	On:	Fee:	Paid:	
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Action:	Ву:	On:	Fee:	Paid:	



\*\*\*note the parcel lines displayed are approximate\*\*\*


# 5175 Old Goodrich Road

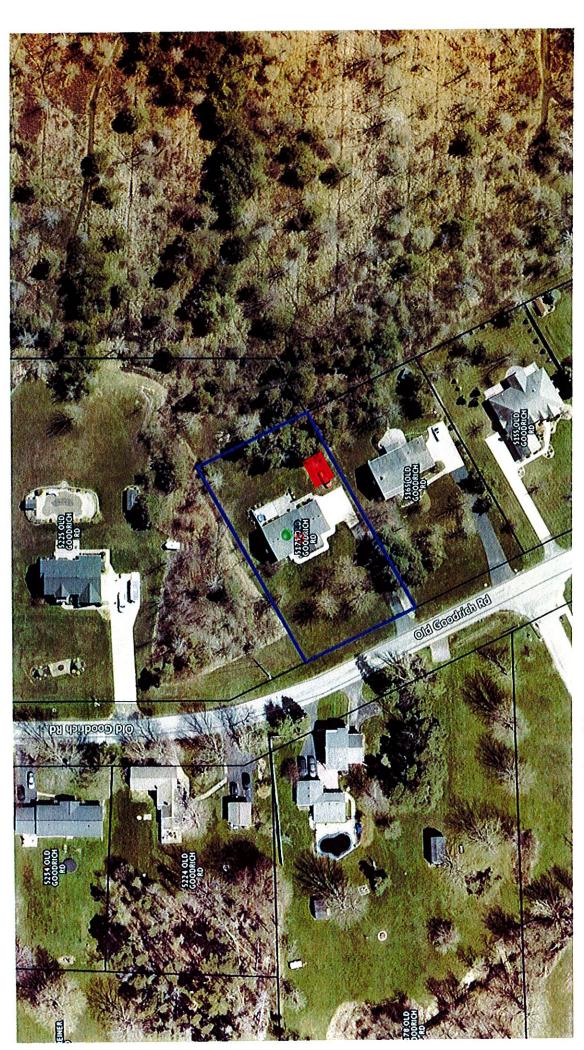

Proposed 612 sq.ft. detached accessory structure (pole barn). The maximum allowable square footage for a detached accessory structure when an attached garage exists is 200 sq.ft. A 412 sq.ft. variance is requested.

Proposed 10' tall overhead garage door. The maximum allowable height of an overhead door is 9' tall. A 1' variance is requested.

Proposed detached accessory structure with metal siding. Accessory structures with a total area exceeding 400 sq.ft. shall be constructed using materials and features similar to the principal structure.

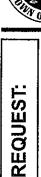

Action:

Ву:



Request for Action

Town of Clarence | Office of Planning & Zoning
(716)741-8933 | 1 Town Place, Clarence, NY 14031

ľ	Го	wn	Us	e C	nly


Date: 8/19/2024

Received By: Andrew Schaefer

Paid:


		ress: <u>5175 Old Goodr</u> BL#: 58.18-4-16.		ence NY 1	4031
REQUEST	Action Desired: Area va Hhan L	riance for an acce 180 sq feet.	essory build in	19 greater	
PPLICANT		- purpose of constr			
AP					
		APPLICANT INFO			SIGNATURE
T INFO:	Name / Business:  E-Mail:  Phone #:  Address:  Town:	Matthew Reid		in the space for Action Planning a plans, map signing below submit this	r Action shall be filled out completely be provided. The complete Request is shall be submitted to the Office of and Zoning along with all necessary is, and supporting documentation. By low I certify that I have the authority to Request for Action, and further certify ontents to be true and correct.
CONTAC		PROJECT SPONSOR INFO (11 Differ Parco Bullding Sus		Please increase incre	correspondence dicate the preferred entity that shall e appropriate correspondence and ociated with this Request for Action. Please select only one.  Int Sponsor
	Address: Town:			8	
V* 1 (	Action:	By:	On:	Fee:	Paid:
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se C	Action;	By:	On:	Fee:	Paid:
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On:

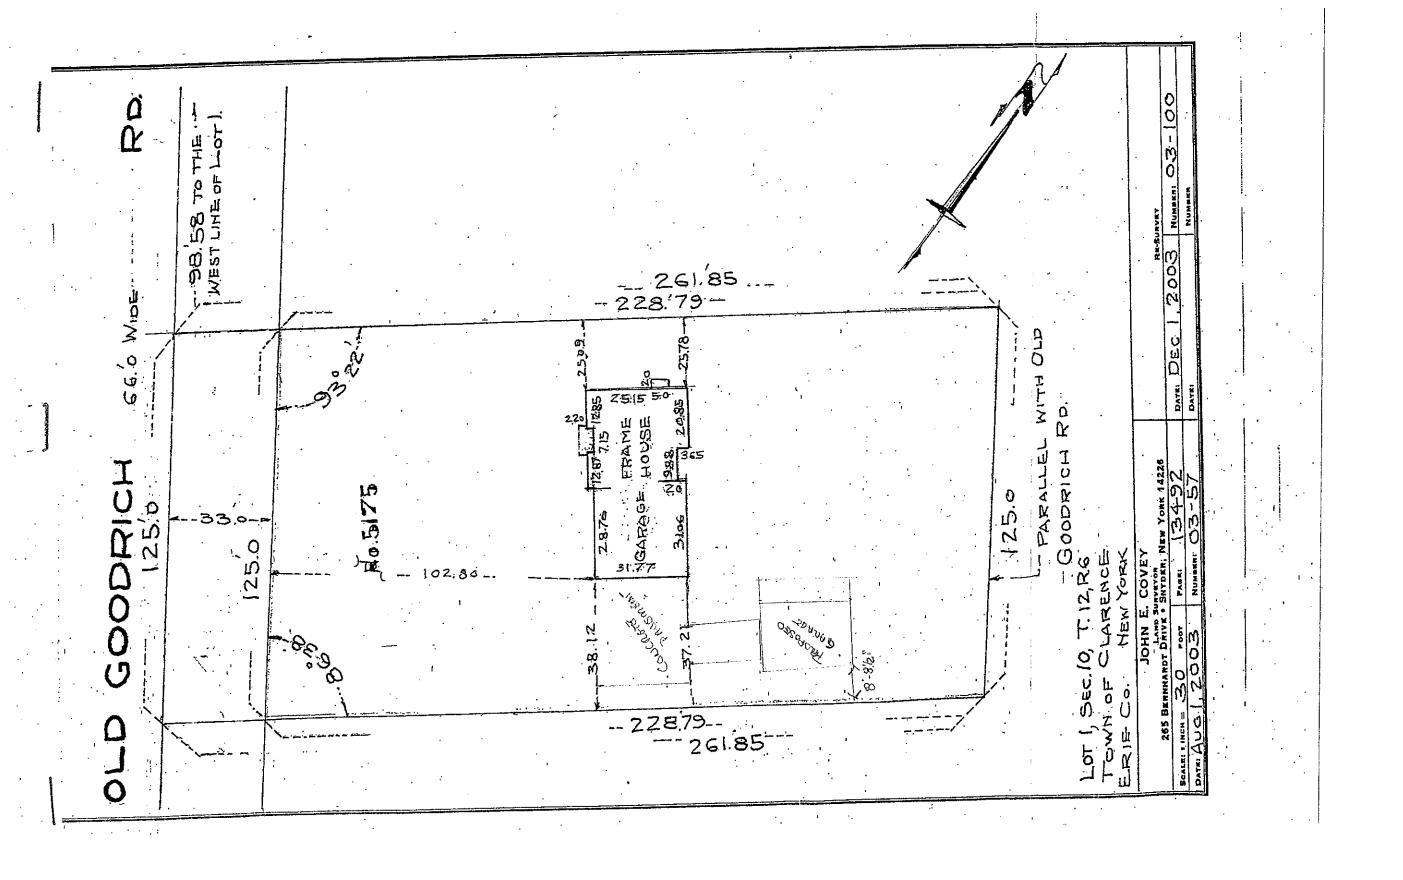

2" HIGH LETTER INDICATING CONSTRUCTION CLASSIFICATION

BACKGROUND SHALL BE REFLECTIVE WHITE

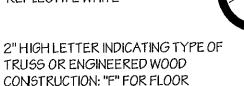

FRAMING, "R" FOR ROOF FRAMING, "FR"

FOR FLOOR & ROOF FRAMING

LETTERS & CIRCLE SHALL BE REFLECTIVE RED, CONFORMING TO PMS #187

6"Ø CIRCLE W/ ½" STROKE WIDTH

# NOTES

1. TRUSS IDENTIFICATION SIGNAGE SHALL BE AFFIXED TO THE ELECTRICAL BOX ATTACHED TO THE EXTERIOR OF THE RESIDENCE OR IN A LOCATION READILY VISIBLE TO FIRE FIGHTERS AND AS APPROVED BY THE AUTHORITY HAVING JURISDICTION

# SIGNAGE DETAIL

SCALE: N.T.S

# DRAWING INDEX

- A-1 ELEVATIONS
- A-2 FLOOR / POST PLAN
- A-3 TRUSS BRACING PLAN
- A-4 BUILDING & WALL SECTIONS

# PARCO BUILDING SYSTEMS, INC

6140 FIRST STREET, NEWFANE, NY 14108 716-778-8552, FAX 716-778-8961

# MATTHEW REID 5175 OLD GOODRICH ROAD CLARENCE, NEW YORK

# GENERAL & STRUCTURAL NOTES

1. TOTAL BUILDING AREA:

432 S.F. W/ 192 S.F. OPEN LEAN-TO

- 2. FOOTING DESIGN ASSUMES A MINIMUM SOIL BEARING CAPACITY OF 2,000 PSF. SOIL PENETROMETER TEST SHALL BE CONDUCTED PRIOR TO CONSTRUCTION TO VERIFY ACTUAL SOIL BEARING CAPACITY. NOTIFY ARCHITECT IMMEDIATELY IF TEST INDICATES LESS THAN 2,000 PSF SOIL BEARING CAPACITY FOR RE-EVALUATION OF POST FOOTINGS
- 3. ALL FOOTINGS SHALL BEAR UPON UNDISTURBED OR COMPACTED SUB-GRADE
- 4. FOOTING BEARING POINTS SHALL MAINTAIN A MINIMUM DEPTH OF 42" TO 48" BELOW FINISH GRADE, AS DETERMINED BY THE BUILDING DEPARTMENT, FOR FROST PROTECTION FOR ENTIRE PERIMETER OF BUILDING
- 5. ALL CONCRETE SHALL HAVE A MINIMUM COMPRESSIVE DESIGN STRENGTH OF 3,500 PSI

6. ROOF TRUSSES SHALL BE DESIGNED TO SUPPORT:

SNOW LOAD

32 PSF (50 PSF GROUND SNOW LOAD)


DEAD LOAD


5 PSF

WIND LOAD


115 MPH, EXPOSURE C


DRAWING NO:

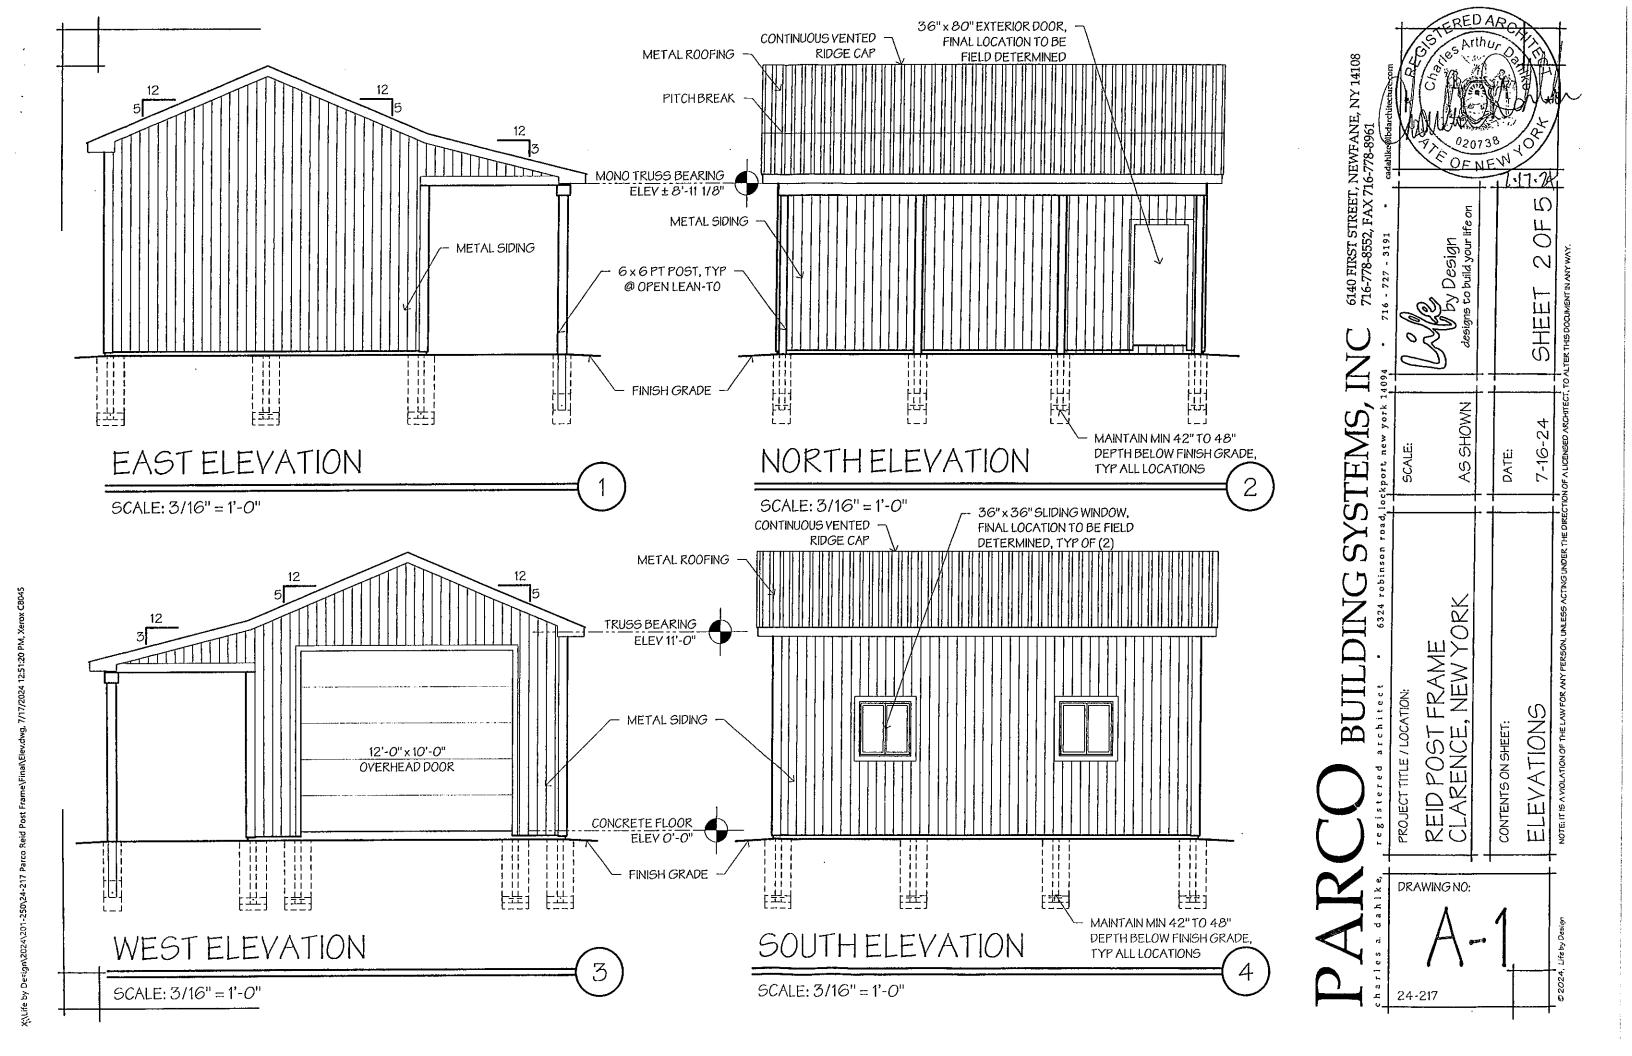

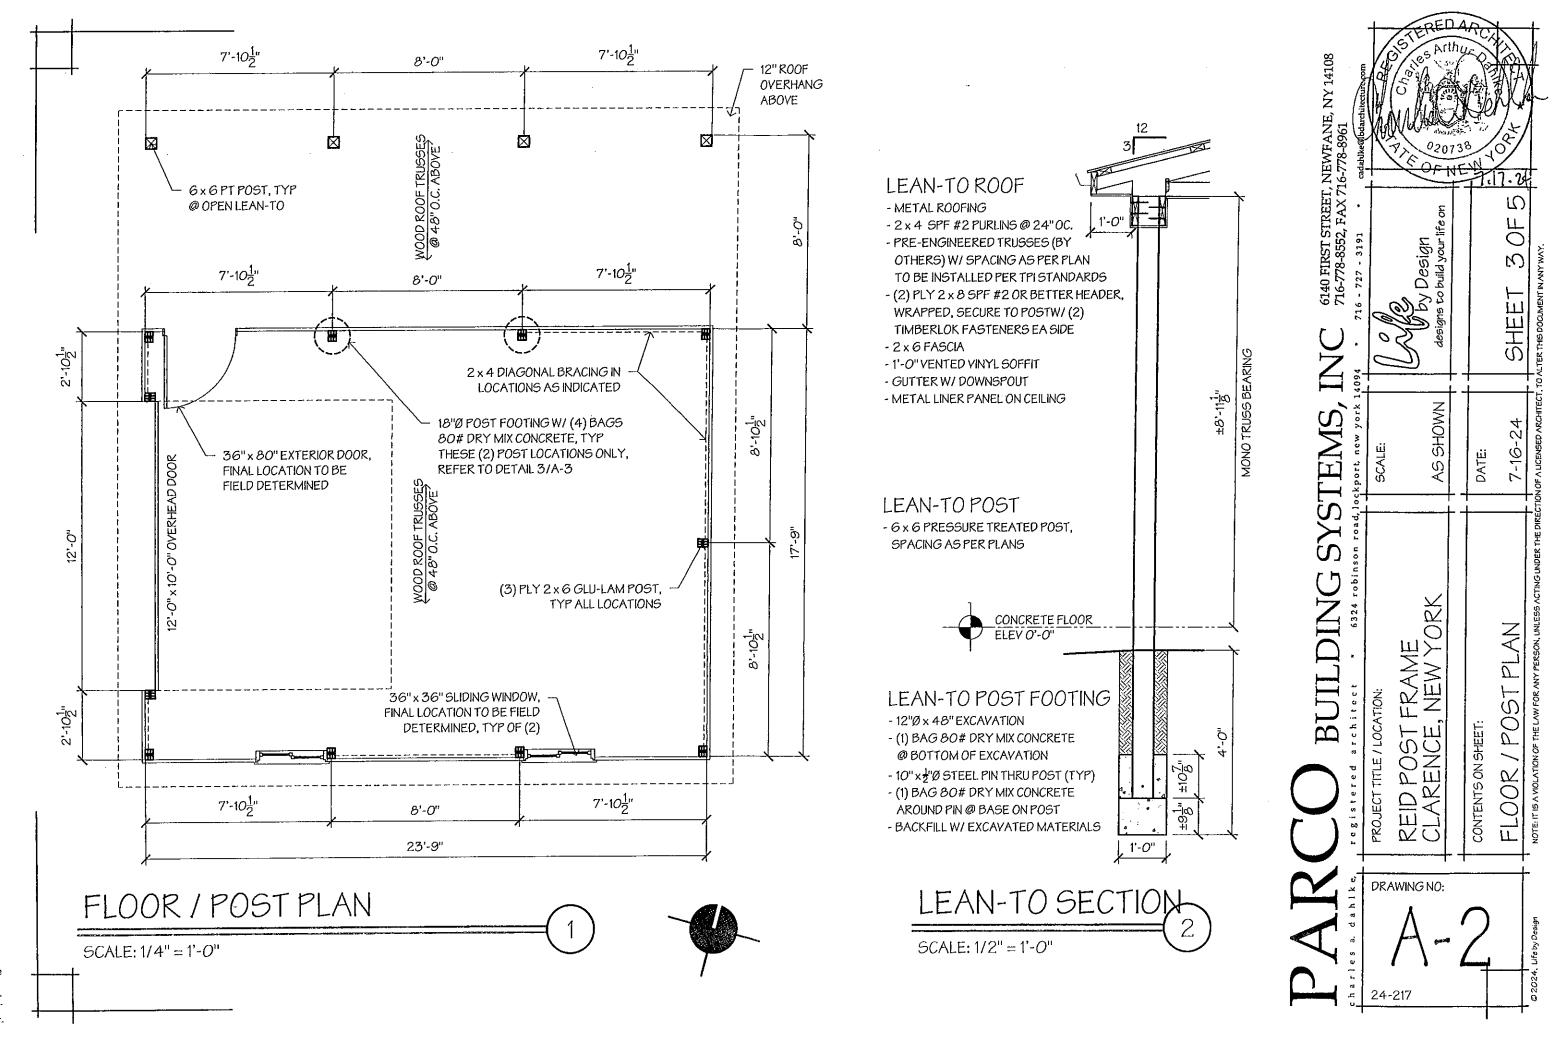

\Life by Desjqn\2024\201-250\24-217 Parco Reid Post Frame\Fina\\Floor.dwg, 7/17/2024 12:51:28 PM, Xerox C8(

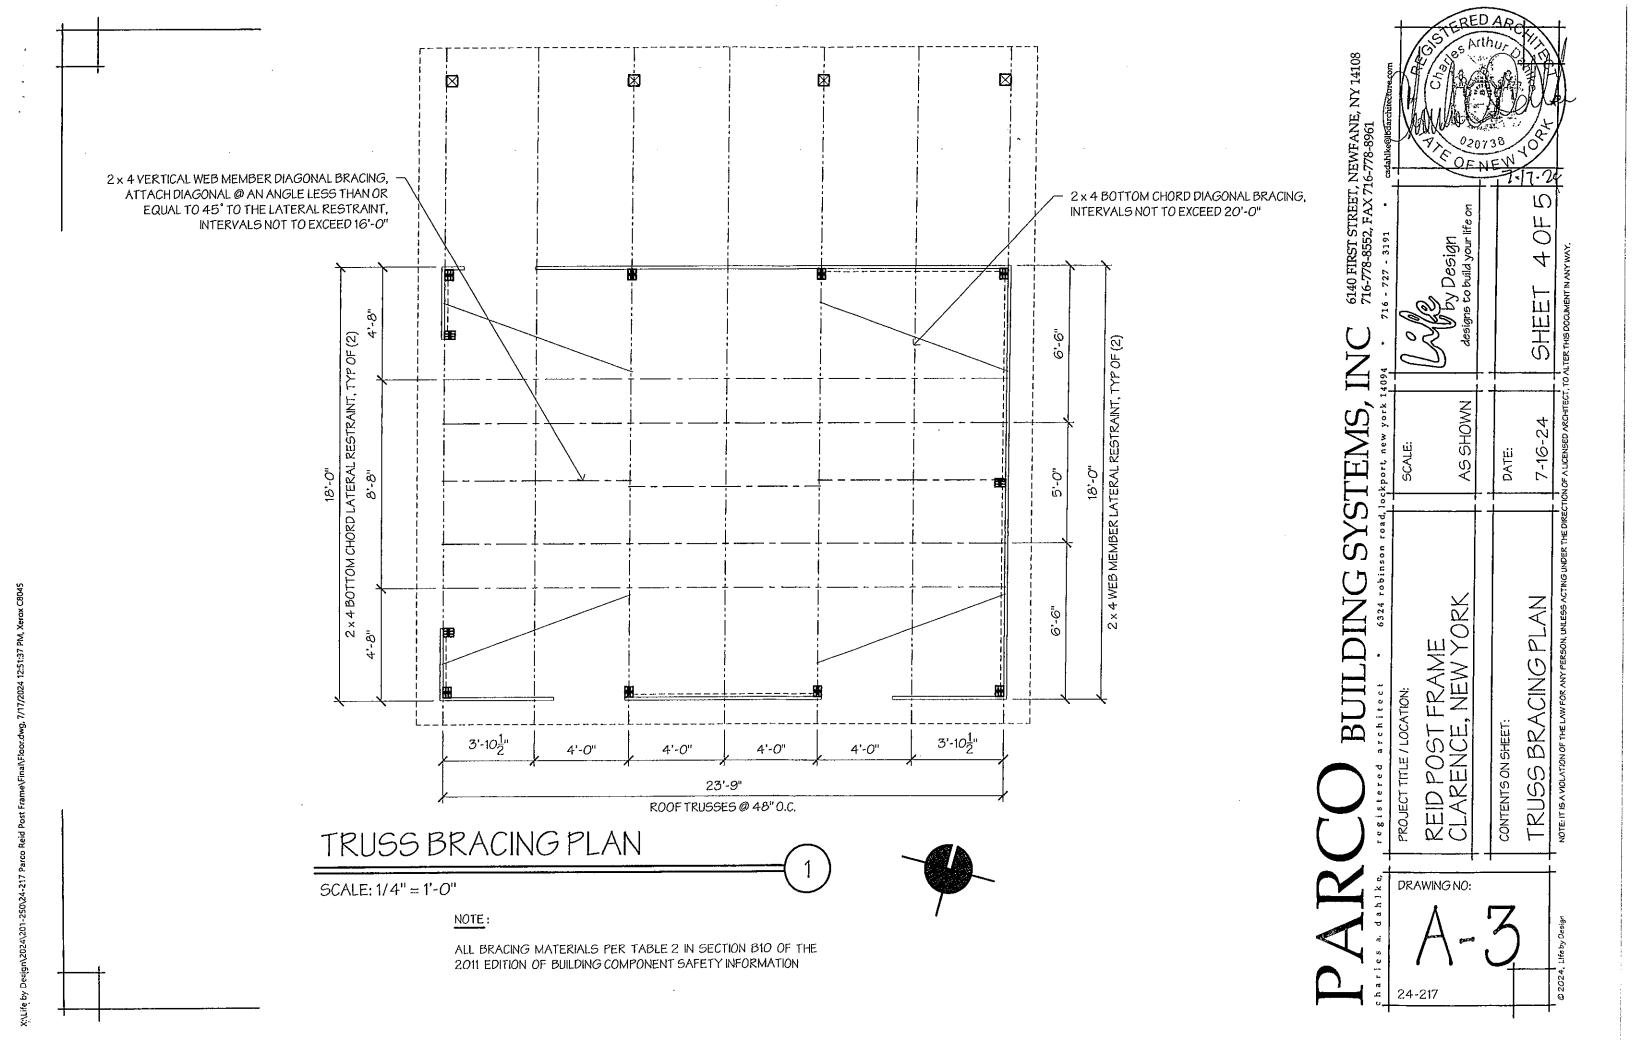

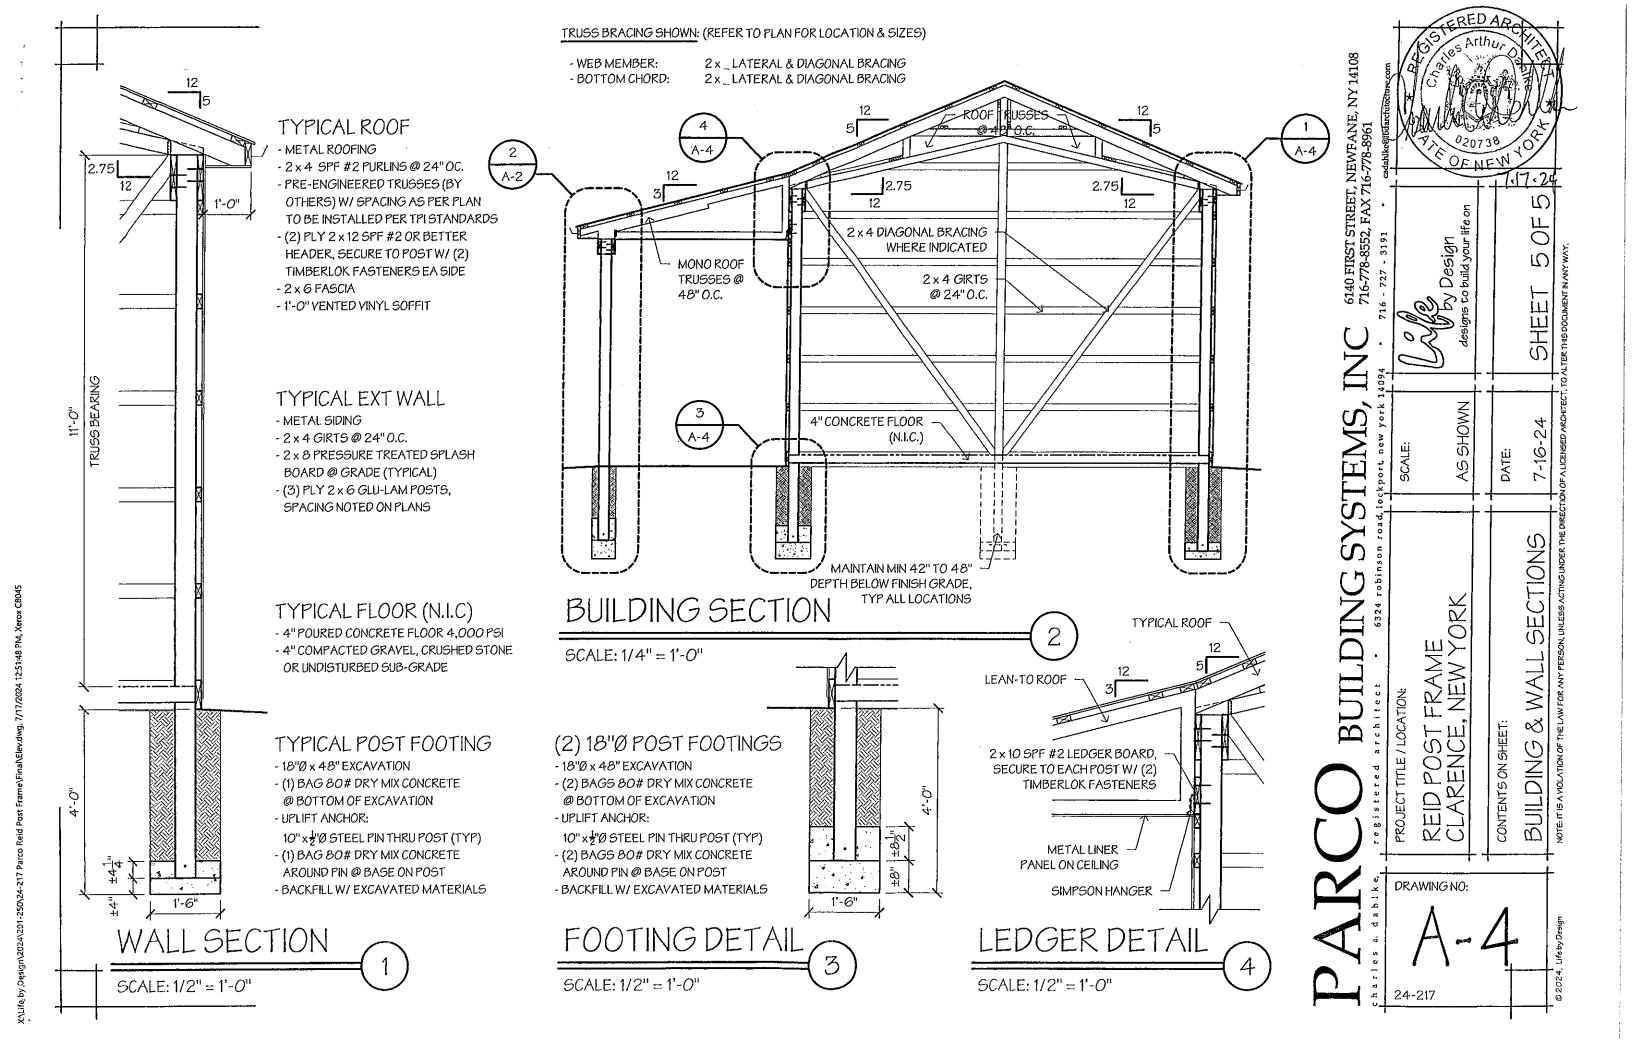



# **Request for Action**

Town of Clarence | Office of Planning & Zoning (716)741-8933 | 1 Town Place, Clarence, NY 14031

# **Town Use Only**

Date: August 23, 2024

Received By: Planning & Zoning Office

Project Address: 9330 Tonawanda Creek Road

SBL #: 6.00-3-6

# **Action Desired:**

Applicant requests a variance of 25' to allow a 61' front yard setback for an addition to the principal structure located at 9330 Tonawanda Creek Road in the Agricultural Flood Zone.

# Reason:

APPLICANT REQUEST:

Town Code Reference: §229-31

		APPLICANT INFO	
	Name / Business:	Nickie Burdick	
	E-Mail:		
	Phone #:	ONFILE	
IFO	Address:	04	
T IN	Town:	State: Zip:	,44-8-8
()			
VTA	ŗ	PROJECT SPONSOR INFO (If Different Than Applicant)	
CONTAC	Name / Business:		
CONTACT INFO:			
CONTAC	Name / Business:		
CONTAC	Name / Business: E-Mail:	ONFILE	

# CORRESPONDENCE

Please indicate the preferred entity that shall receive the appropriate correspondence and billing associated with this Request for Action.

Please select only one.

1	Applicant	
	Project Sponsor	


# SIGNATURE

Request for Action shall be filled out completely in the spaces provided. The complete Request for Action shall be submitted to the Office of Planning and Zoning along with all necessary plans, maps, and supporting documentation. By signing below I certify that I have the authority to submit this Request for Action, and further certify its contents to be true and correct.

signed: Signature On File

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\*\*\*note the parcel lines displayed are approximate\*\*\*

9330 Tonawanda Creek Road

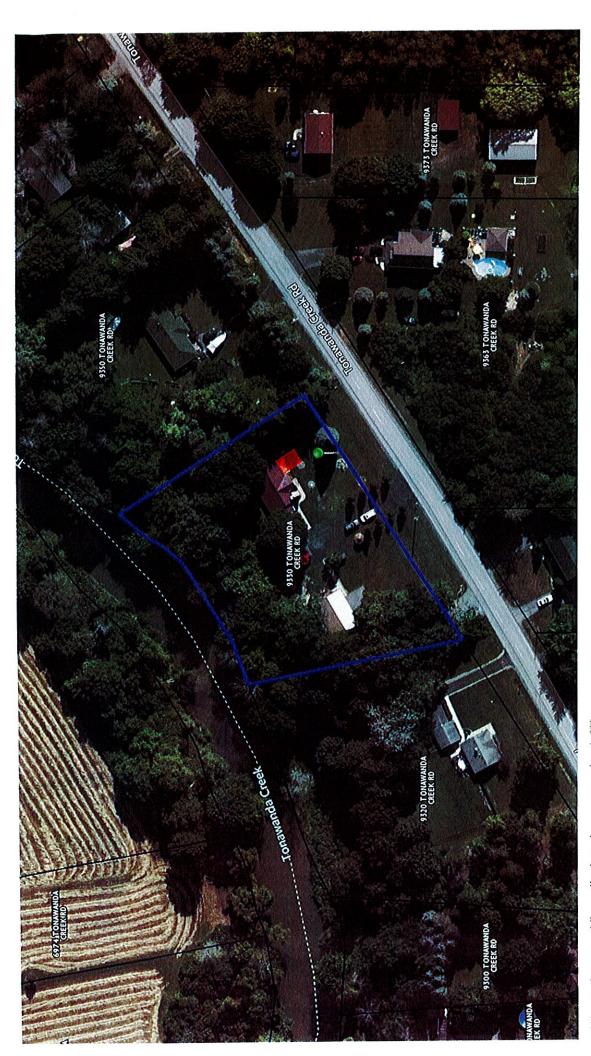

Proposed 61' front yard setback fronting Tonawanda Creek Rad.

Established front yard setback is 86'.

A 25' variance is requested.



Action:

Request for Action
Town of Clarence | Office of Planning & Zoning
(716)741-8933 | 1 Town Place, Clarence, NY 14031

Town L	Jse i	On	V
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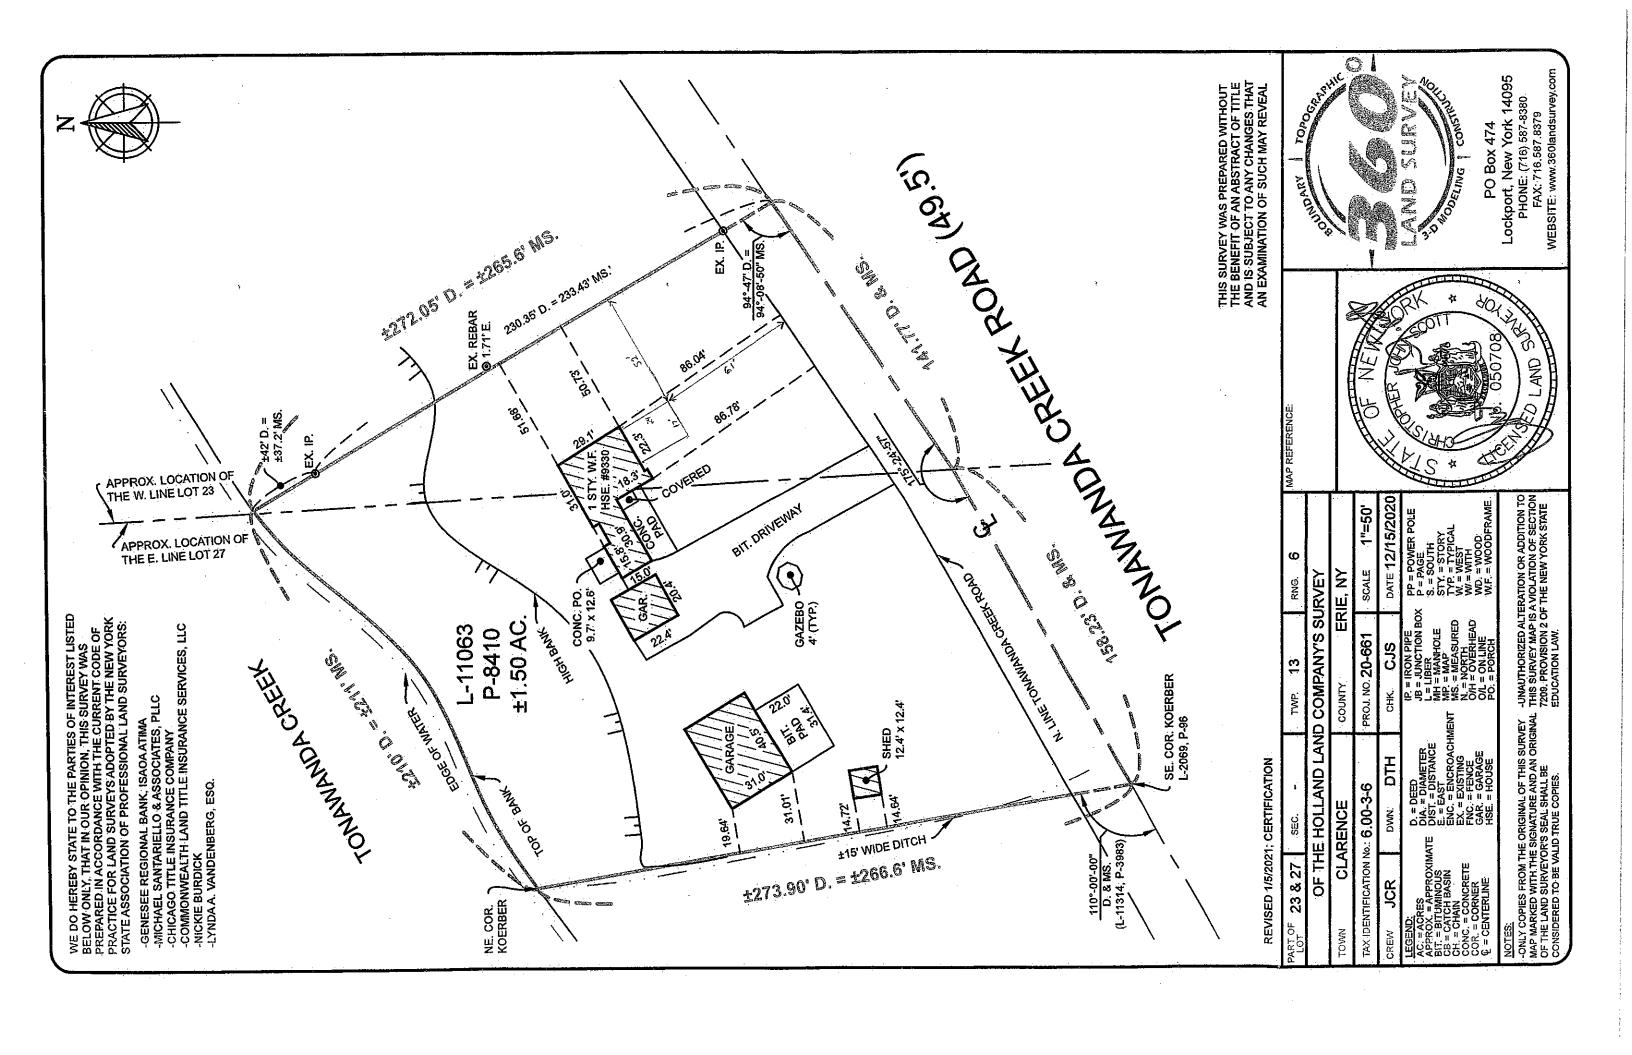
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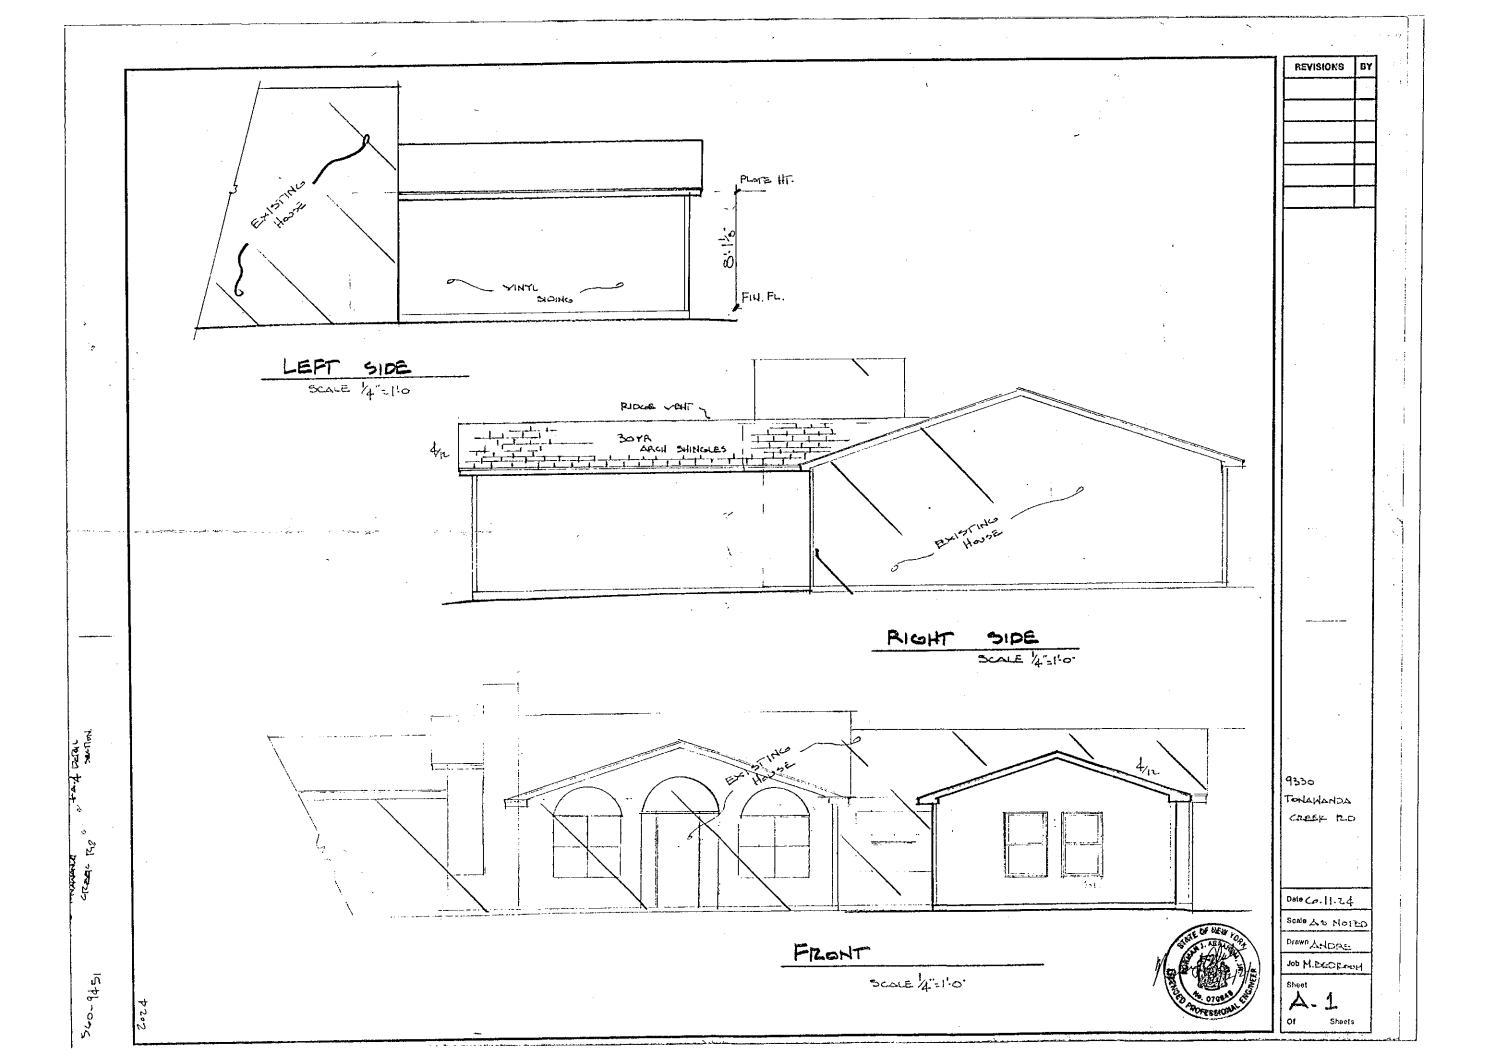
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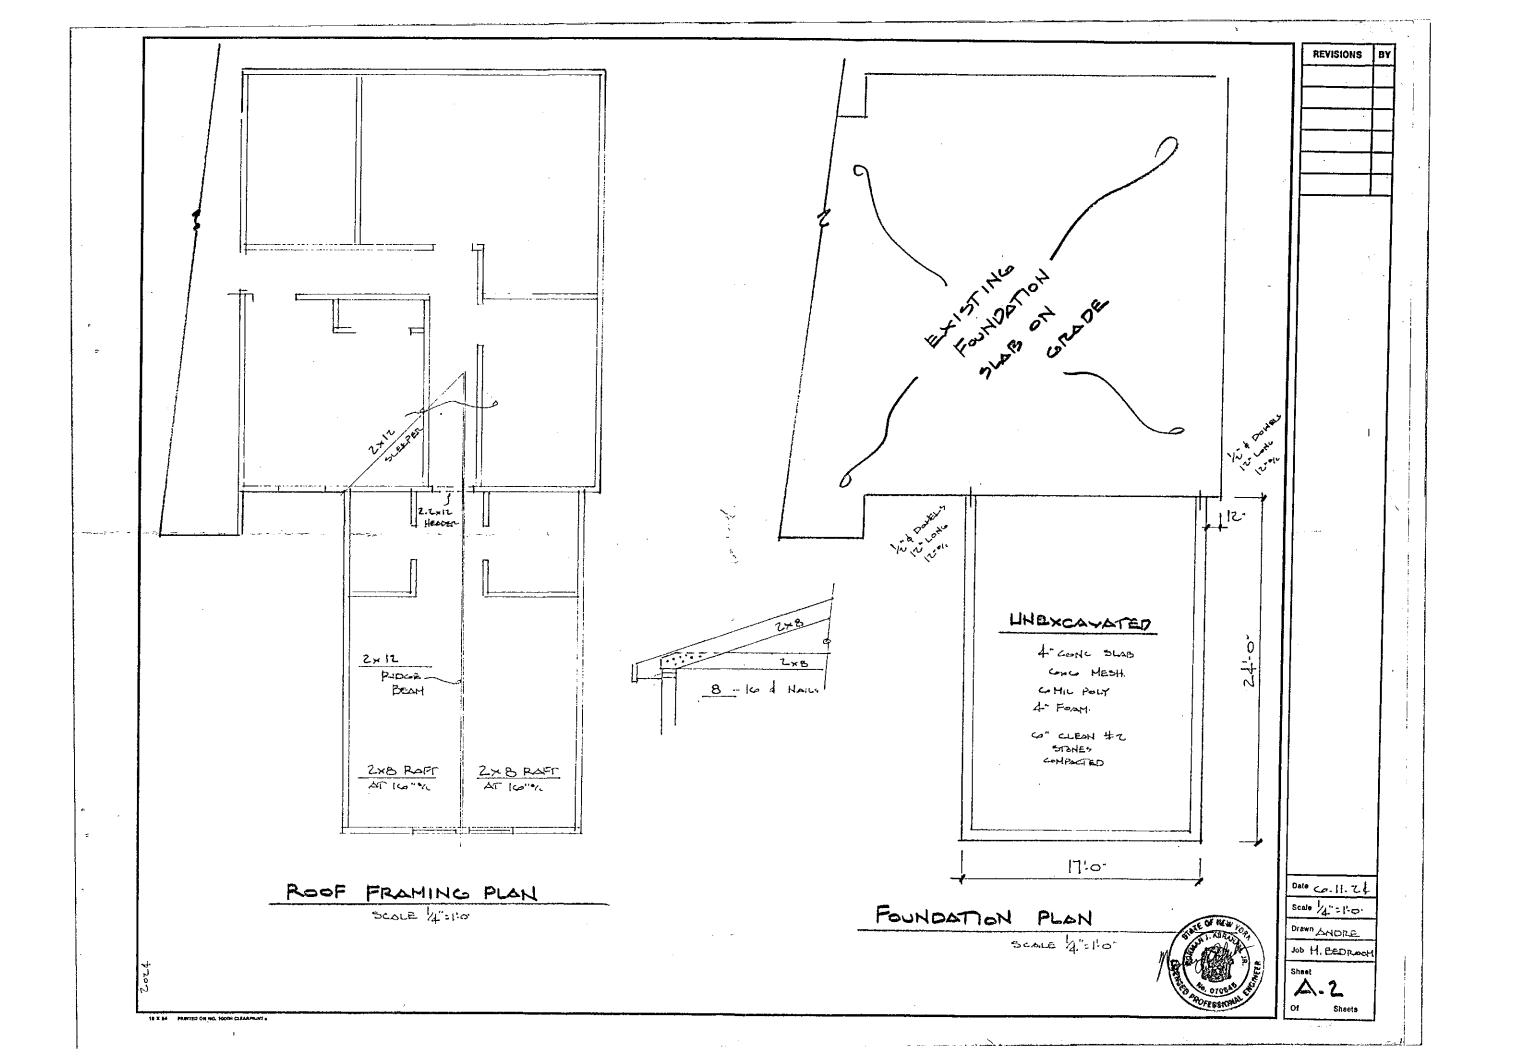
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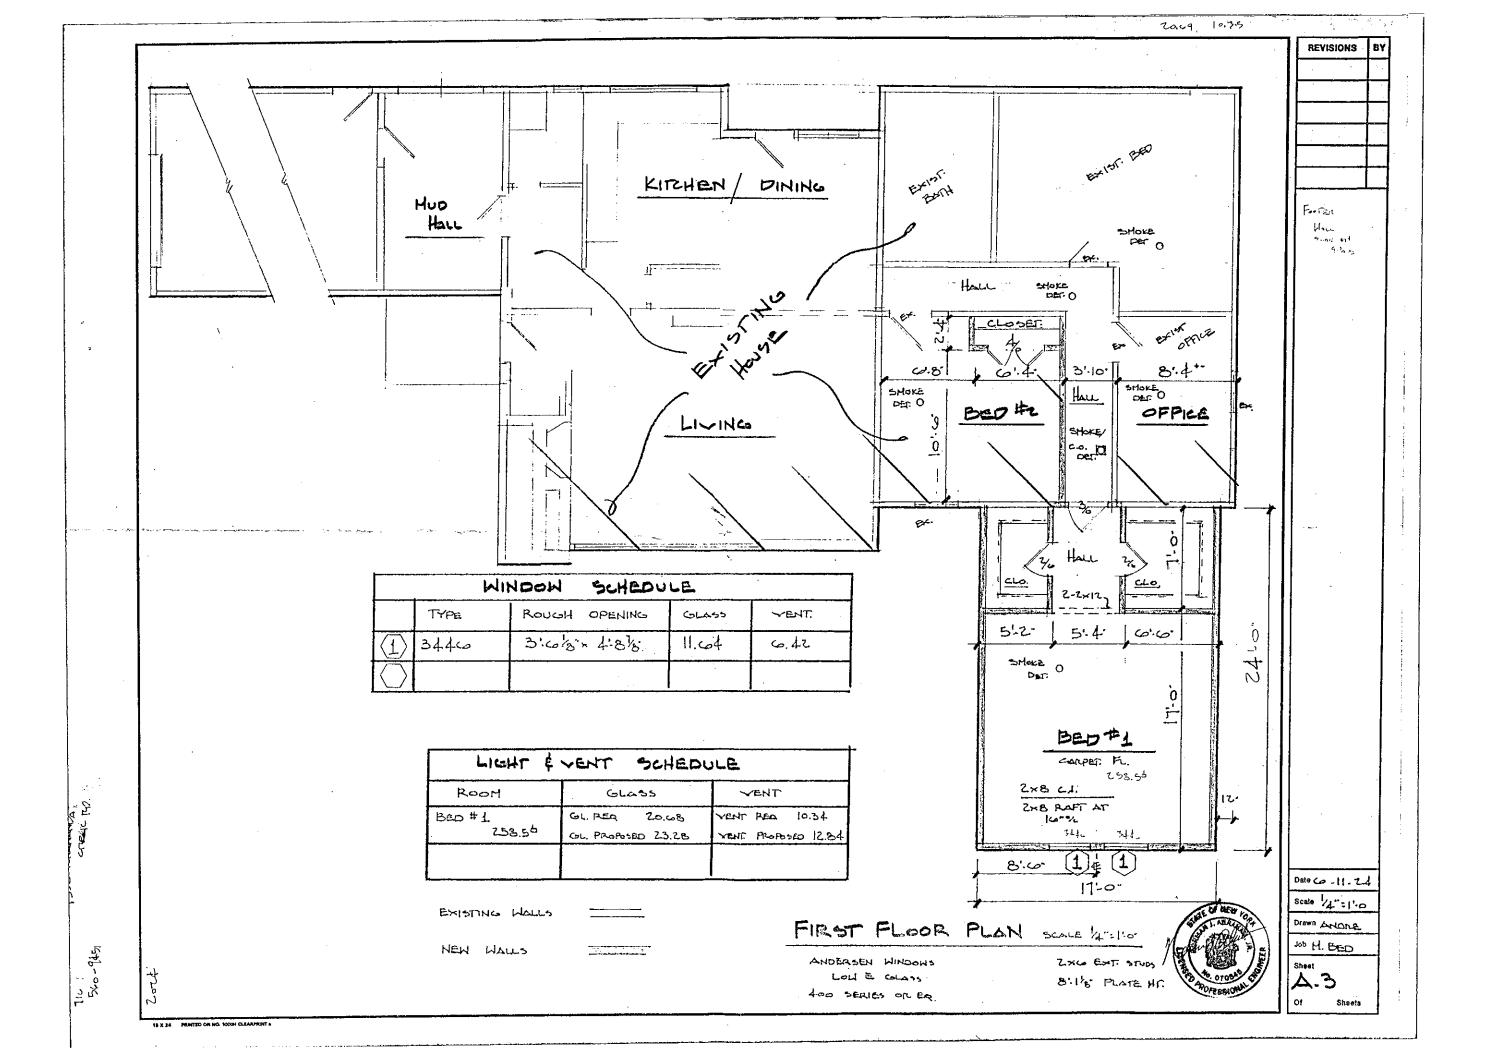
Received By:


	Project Address: 6	7330 Tonawon	to Creek Bd	Clavence Ce	enter NY 14082	
EST:	Action Desired:	- "			RECEIVE	D
REQUE	Bedroom a	ddition			AUG 2 3 202	4
APPLICANT	Reason: Need a Currently on	n addition Ber my Nave 3 bed	droom as w Rooms	e ase ha	ZONING OFFI Ding a Sel Chi	GE and
		APPLICANT INFO	,		SIGNATURE	······································
ST INFO:	Name / Business: <b>Nice</b> E-Mail:  Phone #:  Address:  Town:			in the sport of th	for Action shall be filled out of caces provided. The complete ion shall be submitted to the G g and Zoning along with all ne aps, and supporting documented out I certify that I have the a is Request for Action, and furst contents to be true and corrected.	Request Office of ecessary tation. By uthority to her certify
ONTACT	PROJE  Name / Business:	CT SPONSOR INFO (If Diffe	rent Than Applicant)	receive	CORRESPONDENCE indicate the preferred entity to the appropriate corresponde ssociated with this Request for	nce and
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# TYPICAL

# TYPICAL (NO GARAGE STORAGE) ((GARAGE STORAGE)

TABLE OF LOADS FOR HOUSE STRUCTURES.

BUILDING CODES: 2020 RESIDENTIAL CODE OF NEW YORK STATE (RCNYS)

FLOOR LIVING AREAS - -40# P.S.F. (LIVE)
-10# P.S.F. (DEAD) unless noted otherwise by calculations.

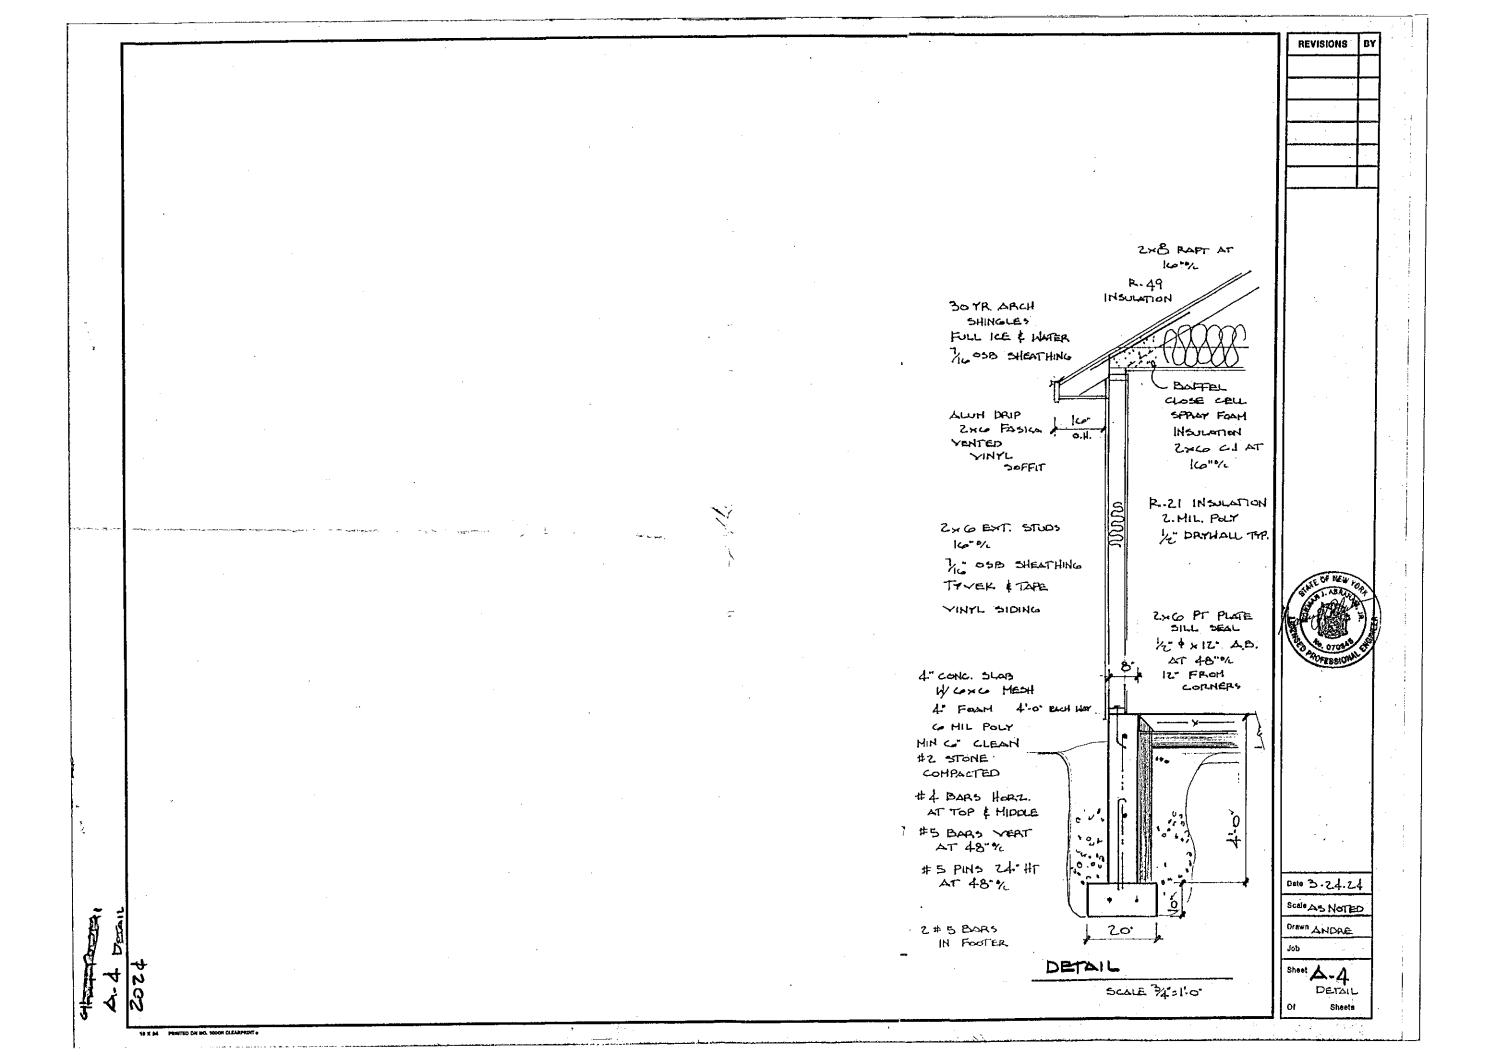- 40M P.S.F. (LIVE) unless noted otherwise by calculations, then use 30s FLOOR SLEEPING AREAS

- 10# P.S.P. (DEAD) Unless note otherwise by calculation

GARAGE FLOORS

ROOF AREAS - TOP CHORD - SOM P.S.F. (LIVE) + 10W P.S.F. (DEAD)

GROUND SNOW LOAD

- SOV P.S.P. (PER 2020 RCNYS FIG. R301.2(6))
- BUILDING SITES AT ELEVATIONS ABOVE 1,000 FT.
- THE GROUND SNOW LOAD SHALL BE INCREASED
BY 2 P.S.P. FOR EVERY 100 F.ET ABOVE 1,000 FEET PER
2020 RCNYS TABLE R301.2(1) FOOTNOTE "0"

SEISMIC DESIGN CATEGORY - B

WEATHERING INDEX - SEVERE

WIND LOAD # 107 MPE

# DESIGN CRITERIA

# DESIGN CODES

- BY NATIONAL DESIGN SPECIFICATIONS FOR WOOD CONSTRUCTION
  BY NATIONAL FOREST PRODUCTS ASSOCIATION.
- SPECIFICATION FOR THE DESIGN FABRICATION AND ERECTION OF STRUCTURAL STEEL FOR BUILDINGS, BY AMERICAN INST. OF STEEL

2X3 SPRUCE PINE FIR (N.D. 19), No. 2 GRADE OR BETTER. (NLGA) -2X10 SPRUCE PINE FIR (N.D. 19), No. 2 GRADE OR BETTER (NLGA) --

WHERE REQUIRED, LAMINATED VENEER LUMBER MAY BE USED PER ENGINEERING

STRUCTURAL STEEL A.S.T.M. A36

TABLE OF LOADS FOR HOUSE STRUCTURES BUILDING CODES: 2020 RESIDENTIAL CODE OF NEW YORK STATE (RCNYS)

FLOOR LIVING AREAS

FLOOR SLEEPING AREAS · 404 P.S.F. (LTVE) unless

10# P.S F. (DFAD) unless

GARAGE FLOURS

ROOF AREAS - TOP CHORD - 50# P.S.F. (LIVE) - 10# P.S.F. (DEAD)

BOTTOM CHORD

GROUND SNOW LOAD

- 304 P.S.P. (PER 2020 RCNYS FIG. R301.2/6)]
- BUILDING SITES AT ELEVATIONS ABOVE 1,000 PT.,
THE GROUND SNOW LOAD STALL BE INCREASED
BY 2 P.S.F. FOR EVERY 100 FEET ABOVE 1,000 FEET PER
2020 RCNYS TABLE R301.2(1) FOOTNOTE "p"

SEISMIC DESIGN CATEGURY = B

WEATHERING INDEX - SEVERE

WINDLOAD - . . . 90 MPH NORHINAL OR

115 MPH 3- SECOND GUST.

# DESIGN CRITERIA

- STRUCTURAL STEEL FOR BUILDINGS. BY AMERICAN INST. OF STEEL CONSTRUCTION.

# DES GN CODES

2x8 SPRUCE PINE FIR (XD.19) No. 2 GRADE OR BETTER (XD.19), No. 2 GRADE OR BETTER (XD.19), No. 2 GRADE OR BETTER (XLGA:

WHERE REQUIRED, LAMINATED VENEER LUMBER MAY BE USED PER ENGINEERING

STRUCTURAL STEEL - A.S.T.M. A36

CONCRETE GUALITY, DESIGN, AND CONTROL

A.) DESIGN OF MIXTURES - CONCRETE DESIGNED IN ACCORDANCE WIT ACT 301 (LATEST EDITION) TO ATTAIN POLLOWING PROPERTIES OF STRENGTH, SLUMP, AND ENTRAINED AIR CONTENT, WATERPROOFING AND SUBMITTED TO ARCHITECT FOR APPROVAL, ALL CONCRETE TO BE

USE	CLASS	23 DAY PSI	AGAR, SIZE AIR	SLUMP	W.C.RATIO
FOOTINGS, WALLS & PIERS	NO.1	anoo.	67 5%-14	4"	0.50
SLABS ON GRADE	200	35001	61, 5%-7%	3	B.45
EXTERIOR CONCRETE	NO 3	, 4000r 🕏	< 67.5%-7%	1.	0.45

ALL CONCRETE NOT DEFINITELY SPECIFIED TO BE OF CLASS 2.
REINFORCEMENT INSTALLED WHERE AND AS SHOWN.

- I.) IF, AT ANY TIME, TESTS FOR JOB CONCRETE, INDICATE FAILURE TO MEET STRENGTIL SLUMP, WATERPROOFING OR AIR CONTENT, THE
- OF ASTM SPECIFICATIONS COL WEIGHT-BATCH APPARATUS POR

- MINING OF CONCRETES

  A.) UNLESS OTHERWISE AUTHORIZED, MIXING OF CONCRETE READY-MIX EQUIPMENT CONTORMING TO ASTM SPECIFICATIONS COA, VOLUME OF MIXED MATERIAL FOR EACH BATCH NOT TO EXCEED THE MANUFACTURER'S RATED MIXER CAPACITY.
- B.) CONCRETE MIXED UNTIL THERE IS A UNIFORM DISTRIBUTION OF MATERIALS AND DISCHARGED COMPLETELY BEFORE MIXER IS RECHARGED.

  CONCRETE DELIVERED TO SITE OF WORK AND FROM THE TIME WATER IS ADDED TO THE MIX. OR BEFORE DRUM HAS REVOLVED 300 REVOLUTIONS, WHICHEVER COMES FIRST. CONCRETE BEYOND THESE LIMITS SITALL BE

# STAIR NOTES:

- ALL CONSTRUCTION OF STAIRWAY REQUIREMENTS SHALL MEET THE 2020 RCNYS (RESIDENTIAL CODE OF NY STATE) AS PER R311.7
- ALL CONSTRUCTION OF STAIR LANDING REQUIREMENTS SHALL MEET THE 2020 RCNYS (RESIDENTIAL CODE OF NY STATE) AS PER R311.7.6
- ALL CONSTRUCTION OF STAIR RISER AND TREAD REQUIREMENTS SHALL MEET THE 2020 RCNYS (RESIDENTIAL CODE OF NY STATE) AS PER R311.7.5 HANDRAIL LOCATION AND GRIP REQUIREMENTS SHALL MEET THE 2020 RCNYS (RESIDENTIAL CODE OF NY STATE) AS PER R311.7.8
- REQUIREMENTS FOR GUARDS/OPENING LIMITATIONS SHALL MEET THE 2020 RCNYS (RESIDENTIAL CODE OF NY STATE) AS PER R312.1

		The same of the sa
Lord-Bearing H	EADER	SCHEDULE Openings Shall be as Follows Unless Noted
OPENING WIDTH		
UP TO 3'-0"	(2) 2 x 6	(I) JACK STUD + KING STUD(S) PER SCHEDULE
3,-0, 10 9,-0,	(2) 2 x 8	(2) JACK STUDS + KING STUDYS) PER SCHEDULE
6'-0" TO 8'-0"	(2) 2 x 10	(2) JACK STUDS + KING STUD(S) PER SCHEDULB
8'-0" TO 10'-0"	(2) 2 x 12	(2) FACK STUDS + KING STUTYS) PER SCHEDULE
10'-0" TO 12'-0"	PER PLANS	
12'-0" TO 16'-0"	PER PLANS	NUMBER OF JACE STUDS AS I ER PLANS + KING STUD(S) PER SCHEDULE

FOR 2 x 4 WALL CONSTRUCTION

Load-Bearing He	ADER	SCHEDULE  Openings Snall be as Pollows Unless Noted
OPENING WIDTH		END SUPPORTS
UP TO 3'-0'	(3) 2 1 6	(1) JACK STUD + KING STUD(S) PER SCHEDULE
3'-0" TO 6'-0"	(3) 2 x 8	(2) IACK STUDS + KING STUD(S) PER SCHEDULE
6'-0" TO 8'-0"	(3) 2 x 10	(2) JACK STUDS + KING STUD(S) PER SCHEDULS
8'-0" TO 10'-0"	(3) 2 x 12 .	(2) JACK STUDS + KING STUD(S) PER SCHEDULE
10'-0" TO 12'-0"	PER PLANS	(3) JACK STUDS + KING STUDYS) PER SCHEDULE
12'-0" TO 16'-0"	PER PLANS	NUMBER OF JACK STUDS AS PER PLANS + KONG STUDS) PER SCHEDULE

FOR 2 x 6 WALL CONSTRUCTION

MINIMUM NUMBER OF FULL HEIGHT (KING)
Studs at Each End of Headers in Exterior Walls HEADER SPAN UP TO 8'-0" ONE (I) 8'-1" TO 18'-0" TWO (2)

# <u>PROJECT NOTES</u>

- ALL CONSTRUCTION MEETS OR EXCEEDS, THE 2010 RCNYS (RESIDENTIAL CODE OF MY STATE)
- WINDOWS ARE TO BE ANDERSEN WINDOWS WILOW E
  ARGON FILLED GLASS (OR APPROVED EQUAL)

  ALL SMOKE ALARMS & C.O. DETECTOR MUST BE INTER-CONNECTED
  AND BATTERY BACK UP AS PER RIM OF THE 2020 RCNYS (RESIDENTIAL
  CODE OF NY STATES) INCLUDING ALL EXISTING BEDROOMS
- PROVIDE HEAT DETECTOR (RATED FOR AMBIENT OUTDOOR TEMPERATURES) CENTRALLY LOCATED IN GARAGE PER R314.2.3
- GARAGE FLOOR SLOPE REQUIREMENTS SHALL COMPLY AS PER R309.1 OF THE 2020 RCNYS (RESIDENTIAL CODE OF NY STATE)
- ALL COLUMNS TO BE LOAD BEARING COLUMNS
- ALL EXHAUST FANS TO VENT TO EXTERIOR
- ATTIC ACCESS IN CEILING SHALL COMPLY AS PER R807 OF THE 2020 RCNYS (RESIDENTIAL CODE OF NY STATE)
- PROVIDE ARTIFICIAL LIGHT IN ALL HALLWAYS AND STAIRS; BOTH INTERIOR AND EXTERIOR
- THE CEILING JOISTS ARE DESIGNED WITH NO INTENDED STORAGE
- PROVIDE SAFETY GLAZING IN APPROPRIATE LOCATIONS AS PER R308.4 OF THE 2020 RCNYS (RESIDENTIAL CODE OF NY STATE)

# **GENERAL NOTES:**

- ALL COMPOSITE WOOD BEAMS AND HEADERS TO BE CONSTRUCTED WITH CONTINUOUS MEMBERS WITH NO SPLICES. GLUE ALL CONTACT SURFACES.
- ALL FOOTINGS POURED ON DRY, FROST FREE, UNDISTURBED VIRGIN SOIL WITH 1500 LB/SF MIN. BEARING CAPACITY.
- ALL POURED CONCRETE TO BE MIN. 5-1/2 BAG MIX WITH MIN. Fc = 3000 PSI @ 28 DAYS
- ALL STRUCTURAL STEEL TO BE A-36 WITH MIN. Fb-24000 PSI, ALL CONNECTIONS AND JOINTS TO DEVELOP 100% CAPACITY OF EACH MEMBER. PROVIDE MIN. 6° BEARING FOR ALL MEMBERS.
- ALL REINFORCING RODS TO BE DEFORMED TYPE "INTERMEDIATE GRADE" WITH MIN. ALLOWABLE TENSILE STRESS OF 20,000 PSI LAP ENDS 24" MIN. INSTALL, 2-6" BENT RODS @ CORNERS.
- ANCHOR BOLTS TO BE 1/2" DIA. X 16" LG. 6" 0".O.C. MAX 12". FROM CORNERS AND ENDS OF FLATES W/MIN, 7" EMBEDMENT MINIMUM (2) BOLTS PER SILL PLATE



OSOS:BIAD TYPICAL NOTES"



# **Request for Action**

Town of Clarence | Office of Planning & Zoning (716)741-8933 | 1 Town Place, Clarence, NY 14031

# **Town Use Only**

Date: August 23, 2024

Received By: Planning & Zoning Office

Project Address: 5544 Herons Glen

SBL #: 58.15-6-11.11

# **Action Desired:**

Applicant requests a variance of 19' to allow a 26' front yard setback for the construction of a single-family home located at 5544 Herons Glen in the Residential Single-Family Zone.

# Reason:

APPLICANT REQUEST:

Town Code Reference: Map Cover 3858

		APPLICANT INFO			
	Name / Business: Allie & T	ac LLC.			
	E-Mail:				
	Phone #:	ONFILE			
FO	Address:	04			
<u> </u>	Town:	State:	Zip:		
CONTACT INFO:	PROJECT SPONSOR INFO (If Different Than Applicant)				
SO	Name / Business:				
	E-Mail:		·		
	Phone #:	ONFILE			
	Address:	Ola			
	Town:	State:	Zip:		

# CORRESPONDENCE

Please indicate the preferred entity that shall receive the appropriate correspondence and billing associated with this Request for Action. Please select only one.

$\checkmark$	Applicant
	Project Sponsor

# **SIGNATURE**

Request for Action shall be filled out completely in the spaces provided. The complete Request for Action shall be submitted to the Office of Planning and Zoning along with all necessary plans, maps, and supporting documentation. By signing below I certify that I have the authority to submit this Request for Action, and further certify its contents to be true and correct.

signed: Signature On File

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\*\*\*note the parcel lines displayed are approximate\*\*\*

# 5544 Herons Glen



# Map Cover 3858 requires a minimum 45' principal structure front yard setback.

Proposed single-family home with a 26' front yard setback.

A 19' variance is requested.

Steve & Aleah Warzala Allie & Tac LLC. Date: 08/23/24

tom

Town of Clarence Zoning Board One Town Place Clarence, NY 14031

Dear Members of the Zoning Board,

I am writing to request a variance for the property we own located at 5544 Herons Glen, Clarence, NY. [SL 195A]. Due to the unique configuration of the lot, we are seeking a 19-foot variance to adjust the front yard setback from the required 45 feet to 26 feet.

# Justification for the Variance:

- Lot Configuration: The lot has an unusual cut in along the cul-de-sac that creates what we consider a side portion of the lot, which significantly affects the layout. We propose resetting the setbacks, recognizing the purple line on the site plan as the side yard boundary, rather than the front.
- **Design Consideration**: The house design aligns with the orange portion of the lot as the front, and we consider the purple aspect as the side. We do not intend to move the house closer to the front lot line but request the setback adjustment based on the side configuration.
- Comparison with Adjacent Properties: When compared to neighboring lots, such as
  the Tuch's [SL 194A], our proposed setback is actually further back. Additionally, our
  lot's geometry differs from others like the Skomra's [SL 196] which opens to the back
  rather than the front.

# **Zoning Code Interpretation:**

Upon reviewing the Town of Clarence's zoning code, specifically the definition provided under Section 229-41(A), the rear yard is defined as extending from the primary rear wall facade to the back lot line. However, our lot presents a unique scenario with a single street right of way and dual sides. We believe this situation is not explicitly covered under current definitions, and therefore, a variance is appropriate. We kindly request that the board agrees with this interpretation and allows us to proceed.

We appreciate your consideration of this request and look forward to working with the town to achieve a solution that respects both the zoning regulations and the unique characteristics of our property.

